



Republic of the Philippines

GOVERNMENT PROCUREMENT POLICY BOARD

TECHNICAL SUPPORT OFFICE



BIDS AND AWARDS COMMITTEE

Project: Supply, Delivery, and Installation of GPPB-TSO Local Area Network (LAN) Project

Bid Bulletin No.: 02

TO ALL INTERESTED BIDDERS:

Please be advised of the following clarifications and amendments to the requirements specified in the Bidding Documents issued for the above-mentioned project:

A. CLARIFICATIONS ON THE REQUIREMENTS OF THE BIDDING DOCUMENTS

Questions/Concerns on the requirements	Clarifications/Answers
1. Can we propose our own work plan for the project?	Yes, provided that it complies with the requirements under the Bidding Documents.
2. How many copies of the bid proposal shall be submitted?	Each bidder shall submit two (2) sets; one envelope marked as "ORIGINAL" while the other as "COPY". Both the ORIGINAL and the COPY shall be enclosed in one single envelope.
3. Is IO cable box included in the deliverables?	Already provided by the General Contractor of the GPPB-TSO Building
4. Can we offer a different brand for the port so long as it is compatible with Huawei? The performance of the LAN may suffer if the offered brand is not Huawei.	Yes, as long as it is compatible and minimal to no issues.
5. Can we offer a different Network Switch?	As long as it will work with the existing Huawei S5735-L24P4X-A1 Network Switch
6. Who will provide the Access Point Cable?	Already provided by the General Contractor
7. Is Network Cabling included in the Scope of Work?	No. Please refer to the Terms of Reference.
8. Can we request for an updated floor plan and a Horizontal and Vertical floor layout from the server room?	Refer to the attached revised floor plan, electrical and electronics plan for your reference.
9. Is there a separate ground tapping for ECE?	The bidder shall provide a grounding system for all equipment which complies with the

	PEC standards.
10. Core Switch should be, 2 x 48*Ethernet 10/100/1000Base-T ports and 1 x 48*SFP+ 100/1000/1000Base-X ports (with SFP+ module) since your transceiver requirement is SFP+	Please refer to Section VII. Technical Specifications and Terms of Reference for the specification of core switch and network switches.
11. The core switch wireless network management is optional if bidder can offer a separate controller	No, the bidder shall supply, deliver, and install the required core switch.
12. The core switch has to support STP (IEEE 802.1d), RSTP (IEEE 802.1w) and MSTP (IEEE 802.1s), BPDU protection, root protection and loop protection, optional to support SEP, BPDU tunnel, ERPS (G.8032)	No. The bidder shall comply with the required technical specification of the core switch indicated in Section VII. Technical Specifications and Terms of Reference.
13. The core switch has to support RIPV1/V2, OSPF, optional to support BGP, and ISIS	The bidder shall comply with the required technical specification of the core switch indicated in Section VII. Technical Specifications and Terms of Reference.
14. If the AP can be managed by Huawei Controller AC6508, Bidder shall offer a separated controller with AI Capacity with control for both AP's and Switch	If the AP can be managed by our existing Huawei Controller AC6508, the bidder is not required to provide separate controller.
15. The wireless AP shall support at least 2*2 MIMO, optional to offer 4x4:4 AP	The bidder shall comply with the required technical specification of the wireless AP as indicated in Section VII. Technical Specifications and Terms of Reference
16. The wireless AP shall support at least 1.7 Gbps wireless speed, optional to support 3.55 Gbps	The bidder shall comply with the required technical specification of the wireless AP as indicated in Section VII. Technical Specifications and Terms of Reference.
17. The wireless AP shall support dedicated AI RF for Security scanning and network quality sense	No. Refer to the specification of wireless AP indicated in Section VII. Technical Specifications and Terms of Reference.
18. The AP, Switches in this Bid shall support to be managed via unified platform, the topology of AP and Switch Network can be shown in the platform, 100% configuration of AP and Switch can be done via the platform also. The Management license for the AP and Switch should be life-time. Bidder shall	Licenses shall be perpetual or life-time. The AP and network switches shall comply with the required technical specifications in Section VII. Technical Specifications and Terms of Reference.

include the platform in the proposed solution.																																																				
19. AP, Switch, 10G SFP+ Module MM quantity clarification					Refer to the Bill of Quantities in the Terms of Reference.																																															
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21. On no. 6 of item 5.1 under 5.0 Deliverables, it is stated that "the (winning bidder) will provide cable trays or ladder racks for the installation of fiber optic cables from the ceiling of the electrical room to server cabinets." Can you confirm if the said cable trays or ladder racks are still need to be part of the BOQ and will be supplied by the winning bidder?																																																				
22. No. 7 of item 5.1 of 5.0 Deliverables, it is stated that, "and other necessary works and materials for the successful implementation of the project." Can you be more specific on this?																																																				
23. During the Pre-bid conference it was mentioned that bidders are allowed to offer non Huawei brand provided that they will replace the existing Huawei Switches, AP, and Controllers. Can you share to us the quantity of Huawei Access Point and Switches?																																																				

	<p>the minimum technical specifications for the AP and Network Switch required under the Terms of Reference or equivalent and shall work along with the specifications required for core switch. The Wireless AP controller to be delivered and supplied shall comply with the following minimum technical specifications:</p> <table border="1"> <tbody> <tr> <td>Port</td><td>10 GE + 2 x 10 GE SFP+</td></tr> <tr> <td>Power Supply</td><td>AC/DC adapter</td></tr> <tr> <td>Forwarding Capacity</td><td>10 Gbit/s</td></tr> <tr> <td>Max. no. of Managed APs</td><td>512</td></tr> <tr> <td>Max. no. of Access Users</td><td>4096</td></tr> <tr> <td>AP-AC Networking</td><td>Layer 2 or Layer 3 Networking</td></tr> <tr> <td>Forwarding Modes</td><td>Direct forwarding or tunnel forwarding</td></tr> <tr> <td>AC Active/Standy Mode</td><td>1 + 1 HSB or N + 1 backup</td></tr> <tr> <td>Radio Protocols</td><td>802.11 a/b/g/n/ac/ac wave 2/ax</td></tr> </tbody> </table>	Port	10 GE + 2 x 10 GE SFP+	Power Supply	AC/DC adapter	Forwarding Capacity	10 Gbit/s	Max. no. of Managed APs	512	Max. no. of Access Users	4096	AP-AC Networking	Layer 2 or Layer 3 Networking	Forwarding Modes	Direct forwarding or tunnel forwarding	AC Active/Standy Mode	1 + 1 HSB or N + 1 backup	Radio Protocols	802.11 a/b/g/n/ac/ac wave 2/ax
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24. Consider the maintenance of the cabling in the ceiling	The General Contractor will provide manhole for service entrance of ECE lines.																		
25. IDF cabinet must have a separate communication grounding	The bidder shall provide a grounding system for all equipment which complies with the PEC standards.																		
26. When does the proof of evidence of "Statement of Compliance" be submitted?	Under Section VII. Technical Specifications, Statement of "Comply" or "Not Comply" must be supported by evidence in a bidder's Bid and cross-referenced to that evidence. Thus, proof of evidence must be submitted																		

	<u>along with the bid proposal on or before the deadline for submission of bids.</u>
	<p>Evidence shall be in the form of manufacturer's un-amended sales literature, unconditional statements of specification and compliance issued by the manufacturer, samples, independent test data etc., as appropriate. A statement that is not supported by evidence or is subsequently found to be contradicted by the evidence presented will render the Bid under evaluation liable for rejection. A statement either in the Bidder's statement of compliance or the supporting evidence that is found to be false either during Bid evaluation, post-qualification or the execution of the Contract may be regarded as fraudulent and render the Bidder or supplier liable for prosecution subject to the applicable laws and issuances.</p>

B. AMENDMENTS TO THE REQUIREMENTS OF THE BIDDING DOCUMENTS

From	To
Section V SPECIAL CONDITIONS OF THE CONTRACT	
4. User Acceptance Test (UAT) <i>The Service Provider shall perform the following activities:</i> <ul style="list-style-type: none"> i. Best-testing of the Hardware functionalities. ii. <i>Design and implementation test and configuration</i> iii. <i>Implementing final adjustments and configurations.</i> iv. <i>User and admin acceptance test.</i> 	4. User Acceptance Test (UAT) <i>The Service Provider shall perform the following activities:</i> <ul style="list-style-type: none"> i. Beta-testing of the Hardware functionalities. ii. <i>Design and implementation test and configuration</i> iii. <i>Implementing final adjustments and configurations.</i> iv. <i>User and admin acceptance test.</i>
Section VI: SCHEDULE OF REQUIREMENTS	
Please refer to the attached revised Section VI. Schedule of Requirements of the Bidding Documents	
Section VII: TECHNICAL REQUIREMENTS	

QUALIFICATION REQUIREMENT:	QUALIFICATION REQUIREMENTS:
<p>The Service Provider should mobilize key personnel as project managers and at least 3 IT experts that must meet the following minimum qualifications:</p> <ul style="list-style-type: none"> a. Should be an established IT company with experience in IT infrastructure and Network Configuration and undertake and completed a minimum of three (3) ICT projects in the last five (years). 	<p>The Service Provider should mobilize key personnel as project managers and at least 3 IT experts that must meet the following minimum qualifications:</p> <ul style="list-style-type: none"> a. Should be an established IT company with experience in IT infrastructure and Network Configuration and undertake and completed a minimum of three (3) ICT projects in the last five (5) years. <p>Note: Other conditions under the “Qualification Requirements” shall remain the same.</p>
<p>Network Switch</p> <p>Hardware Specifications:</p> <ul style="list-style-type: none"> - CPU: Launch date (Q1'16 or higher), Vertical Segment (server), 12-core 2.1 GHz, Threads (24), Cache (18MB), TDP (65W), Turbo Boost up to 2.7 GHz or equivalent/higher - Memory: 16 GB DDR4 ECC RDIMM (expandable up to 128 GB) - Compatible drive type: 12 x 3.5" or 2.5" SAS/SATA HDD/SSD - Hot swappable drive: Yes - External port: 2x USB 3.0 port, 1 x Expansion Port - LAN: 2 x 10GbE RJ-45 (10BASE-T), 4 x GbE RJ-45 	<p>Network Attached Storage</p> <p>Hardware Specifications:</p> <ul style="list-style-type: none"> - CPU: Launch date (Q1'16 or higher), Vertical Segment (server), 12-core 2.1 GHz, Threads (24), Cache (18MB), TDP (65W), Turbo Boost up to 2.7 GHz or equivalent/higher - Memory: 16 GB DDR4 ECC RDIMM (expandable up to 128 GB) - Compatible drive type: 12 x 3.5" or 2.5" SAS/SATA HDD/SSD - Hot swappable drive: Yes - External port: 2x USB 3.0 port, 1 x Expansion Port - LAN: 2 x 10GbE RJ-45 (10BASE-T), 4 x GbE RJ-45
<p>UPS</p> <ul style="list-style-type: none"> - Capacity: 8TB - Rating (VA/W): 220VA/2200W - Format: 2RU - Battery: Hot-swappable - Sockets: 8 IEC 10A; 2 IEC 16A sockets with energy metering (including 5 remote controlled sockets) 	<p>UPS</p> <ul style="list-style-type: none"> - Rating (VA/W): 220VA/2200W - Format: 2RU - Battery: Hot-swappable - Sockets: 8 IEC 10A; 2 IEC 16A sockets with energy metering (including 5 remote controlled sockets)

energy metering (including 5 remote controlled sockets)	- Interfaces: 1 USB port; 1 serial RS232 port; 1 mini-terminal block for Remote ON/OFF; 1 mini-terminal block for Remote Power OFF; 1 mini-terminal block for output relay; 1 Ethernet port (RJ45)
Compliance with the Terms of Reference attached herein as Annex A	Please refer to the attached revised Terms of Reference.

Please be guided accordingly.

Issued this 12th day of April 2023.

MS. JULIE D. ABRIGO
Chairperson
 Bids and Awards Committee

Section VI. Schedule of Requirements

The delivery schedule expressed as weeks/months stipulates hereafter a delivery date which is the date of delivery to the project site.

Description	Quantity	Total	Delivered, Weeks/Months
Project implementation Plan including all enumerated documents required under Annex A	1 lot	1 lot	Within 10 working days from receipt of the Notice to Proceed
Supply, delivery, and installation of all network equipment and hardware including proper configuration and commissioning of all hardware components	1 lot	1 lot	120 calendar days from approval of the implementation plan
Admin and User's Training	1 lot	1 lot	Within 5 working days from the date of the Project Completion.
Project Documentation	1 lot	1 lot	Within 10 working days after the date of Admin and User's Training

***The GPPB-TSO shall be given a minimum of seven (7) working days-period to review and evaluate each report submitted by the Contractor/Supplier. The period allocated for the GPPB-TSO's review and evaluation shall be deemed not interruption or stop the running of Completion Period allocated to Contractor/Supplier**

I hereby verify to comply with all the above requirements.

Signature over the printed name of the authorized representative

Company name

Date

TERMS OF REFERENCE

SUPPLY, DELIVERY, AND INSTALLATION FOR GPPB-TSO LOCAL AREA NETWORK (LAN) PROJECT

1.0 INTRODUCTION

The Government Procurement Policy Board (GPPB) was established by virtue of Republic Act No. 9184 (R.A. 9184) as an independent inter-agency body that is impartial, transparent, and effective, with private sector representation.

The GPPB, being an inter-agency body composed of top-level public officials, is supported by its very own Technical Support Office (TSO) to provide support in the performance of its duties and responsibilities, particularly in spearheading the implementation of public procurement reform initiatives in the Philippines (Sec. 63.2, Implementing Rules and Regulations of Republic Act 9184). With the construction of its own building, the GPPB-TSO aims to continually improve the quality and efficiency of the services to its various stakeholders. It will strengthen internal processes that support GPPB-TSO's mandate and improve the performance efficiency of each functional area. Specifically, it will establish a fast, redundant, and reliable network infrastructure. It will set up an innovative active network component and create a more effective and efficient Information and Communication Technology (ICT) infrastructure.

2.0 OBJECTIVE

This project aims to:

- 2.1. Establish a reliable and secured network infrastructure system that will allow smooth data transfer and communication between computers, users, and servers, better manage data traffic, reduce network congestion, protect hardware and software from data breach and cyber-attack.
- 2.2. Ensure fast, efficient, and secure sharing, accessing, and receiving of information through electronic means between and among offices and division within GPPB-TSO which will increase productivity and drives performance.

3.0 SCOPE OF WORK

The project covers the supply, delivery, and installation of all active network components for the new GPPB-TSO building. It shall include the procurement and installation of Network Switches, Data Cabinets, and Wireless Access Points from the 1st floor to the 6th floor of the new GPPB-TSO building.

3.1 DELIVERY, INSTALLATION, AND CONFIGURATION OF THE GPPB-TSO NETWORK

The Supplier/Service Provider shall be responsible for the following:

- 3.1.1. Delivery of all hardware and components for the GPPB-TSO Local Area Network (LAN).
- 3.1.2. Installation and configuration of hardware and components of the GPPB-TSO Network.
- 3.1.3. Commissioning of all hardware and components of the GPPB-TSO Network.

3.2 PROJECT IMPLEMENTATION

- 3.2.1 The Supplier/Service Provider shall be required to submit a detailed Project Implementation Plan with S-Curve within ten (10) working days upon receipt of the Notice to Proceed, which will include all items identified in the scope of work listed in

this section. This plan shall be approved by the GPPB-TSO through the Information Management Division (IMD).

3.3 USER ACCEPTANCE TEST (UAT)

The Supplier/Service Provider shall perform the following activities per module:

- 3.3.1. Beta-testing of hardware functionalities
- 3.3.2. Design and implementation tests and configurations
- 3.3.3. Implementing final adjustments and configurations
- 3.3.4. User and admin acceptance test.

3.4 PROJECT CLOSE-OUT

The Supplier/Service Provider shall perform the following project close-out activities to ensure the complete transfer of assets to the GPPB-TSO:

- 3.4.1 Onsite Administrator and User Technical Training
- 3.4.2 Project Documentation
- 3.4.3 Completion of the punch list within 15 calendar days from the date of inspection

4.0. TECHNICAL SPECIFICATION

Project deliverables must be compatible with our existing Huawei 24 Port Layer 3 Managed Network Switch, Huawei Controller AC6508, and Huawei Access Point AirEngine5761-11 and must conform to the following minimum technical specifications, equivalent or higher:

4.1. Core Switch

- 4.1.1. Dimension: 4U
- 4.1.2. Switching Capacity: 1.92Tbps
- 4.1.3. Forwarding Performance: 1440 Mpps
- 4.1.4. MPU Slot: 2
- 4.1.5. Service Slot: 3
 - Service card:
 - 2 x 48*Ethernet 10/100/1000Base-T ports
 - 1 x 48*SFP 100/1000/10000Base-X ports (with SFP+ module)
- 4.1.6. Redundancy design: MPUs, power modules, CMU, fan trays
- 4.1.7. Wireless network management:
 - Native AC
 - AP access control, AP region management, and AP profile management
 - Radio profile management, uniform static configuration, and centralized dynamic management
 - Basic WLAN services, QoS, security,
 - and user management
- 4.1.8. User Management:
 - Unified user management
 - PPPoE, 802.1x, MAC address, and Portal authentication
 - Traffic- and time-based accounting
 - User authorization based on user groups, domains, and time ranges
- 4.1.9. VLAN
 - 4K VLANs

- Access, trunk, and hybrid interface types, auto-negotiation of LNP links
 - Default VLAN
 - VLAN Switching
 - QinQ and selective QinQ
 - MAC address-based VLAN assignment
- 4.1.10. ARP
- 128K ARP entries
 - ARP Snooping
- 4.1.11. MAC address
- 1M MAC address entries
 - MAC address learning and aging
 - Static, dynamic, and blackhole MAC address entries
 - Packet filtering based on source MAC address
 - Limit on the number of MAC addresses learned on ports and VLANs
- 4.1.12. Ring Protection
- STP (IEEE 802.1d), RSTP (IEEE 802.1w), and MSTP (IEEE 802.1s)
 - SEP
 - BPDU protection, root protection, and loop protection
 - BPDU tunnel
 - ERPS(G.8032)
- 4.1.13. IP Routing
- IPv4 routing protocols, such as RIPv1/v2, OSPF, BGP, and IS-IS
 - IPv6 dynamic routing protocols, such as RIPng, OSPFv3, ISISv6, and BGP4
 - User authorization based on user groups, domains, and time ranges
- 4.1.14. Multicast
- 128,000 multicast routing entries
 - IGMPv1/v2/v3 and IGMP v1/v2/v3 snooping
- 4.1.15. QoS
- 4.1.16. Support system logs and multi-level alarms and dying gasp.

4.2. Network Switch

- 4.2.1. Dimension: 1U
- 4.2.2. Switching Capacity: 336 Gbps
- 4.2.3. Forwarding Performance: 51 Mpps
- 4.2.4. Port: 24*Ethernet 10/100/1000Base-T ports and 4*GE SFP+ (with complete SPF+ module)
- 4.2.5. Power: AC Power Supply

4.3. Network Switch (POE)

- 4.3.1. Dimension: 1U
- 4.3.2. Switching Capacity: 336 Gbps
- 4.3.3. Forwarding Performance: 51 Mpps
- 4.3.4. Port: 24*Ethernet 10/100/1000Base-T ports and 4*GE SFP+ (with complete SPF+ module)
- 4.3.5. Power: AC Power Supply
- 4.3.6. POE+

4.4. Wireless Access Points

- 4.4.1. Must be compatible with Huawei Controller AC6508
- 4.4.2. Access Point license for AP controller
- 4.4.3. Power Input: with DC power and POE power supply

- 4.4.4. Maximum Number of Users: ≤ 1024
- 4.4.5. Antenna Type: Built-in Dynamic-Zoom Smart Antennas
- 4.4.6. MIMO: Spatial Streams: 2.4GHz: 4 x 4:4, 5GHz: 4 x 4:4
- 4.4.7. Radio Protocols: 802.11a/b/g/n/ac/ac wave2/ax
- 4.4.8. Maximum Rate: 3.55 Gbps

4.5. Network Attached Storage

- 4.5.1. Hardware Specifications
 - CPU: Launch Date (Q1'16 or Higher), Vertical Segment (server), 12-core 2.1 GHz, Threads (24), Cache (18MB), TDP (65W), Turbo Boost up to 2.7 GHz or equivalent/ higher
 - Memory: 16 GB DDR4 ECC RDIMM (expandable up to 128 GB)
 - Compatible drive type: 12 x 3.5" or 2.5" SAS/SATA HDD/SSD
 - Hot swappable drive: Yes
 - External port: 2 x USB 3.0 port, 1 x Expansion Port
 - LAN: 2 x 10GbE RJ-45 (10GBASE-T), 4 x GbE RJ-45
- 4.5.2. Software Specifications
 - Networking protocol: SMB, AFP, NFS, FTP, WebDAV, CalDAV, iSCSI, Telnet, SSH, SNMP, VPN (PPTP, OpenVPN™, L2TP)
 - File system: Btrfs, ext4, ext3, FAT, NTFS, HFS+, exFAT4
 - Supported RAID type: Basic, JBOD, RAID 0, RAID 1, RAID 5, RAID 6, RAID 10
 - Storage management:
 - Maximum single volume size: 108 TB/200 TB (at least 32 GB RAM required, for RAID 5 or RAID 6 groups only)
 - Maximum system snapshots: 65,5365
 - Maximum internal volume: 256
 - File sharing capability
 - Maximum local user accounts: 16,000
 - Maximum local groups: 512
 - Maximum shared folders: 512
 - Maximum concurrent SMB/NFS/AFP/FTP connections: 4,000
 - Support virtualization
- 4.5.3. Hard Drive Specifications
 - Capacity: 8TB
 - Form Factor: 3.5"
 - Interface: SATA 6 Gb/s
 - Sector Size: 512e
 - Rotational Speed: 7,200 rpm
 - Interface Speed: 6.0 Gb/s, 3.0 Gb/s, 1.5 Gb/s
 - Buffer Size: 256 MiB
 - Maximum Sustained Data Transfer Speed: 248 MiB/s
 - Warranty: 5 years

4.6. UPS

- 4.6.1. Rating (VA/W): 2200VA / 2200W
- 4.6.2. Format: 2RU
- 4.6.3. Battery: Hot-swappable
- 4.6.4. Sockets: 8 IEC 10A; 2 IEC 16A sockets with energy metering (including 5 remote controlled sockets)

- 4.6.5. Interfaces: 1 USB port; 1 serial RS232 port; 1 mini-terminal block for Remote ON/OFF; 1 mini-terminal block for Remote Power OFF; 1 mini-terminal block for output relay; 1 Ethernet port (RJ45)

5.0. DELIVERABLES

The following are the deliverables for this project:

5.1. Network and Cabling Works

- 5.1.1. Installation of the Active Network Components
- 5.1.2. Installation of cable guide from ceiling to server cabinets
- 5.1.3. Termination and testing of cable and connectors
- 5.1.4. Proper end-to-end tagging/labeling of cables and connectors for easier referencing and identification
- 5.1.5. Restoration and cleaning of all affected areas
- 5.1.6. Provide cable trays or ladder racks for the installation of fiber optic cables from the ceiling of the electrical room to server cabinets.
- 5.1.7. And other necessary works and materials for the successful implementation of the project.

5.2. Project Implementation Plan

This shall be submitted to GPPB-TSO for approval within ten (10) working days from receipt of the NTP. This submission should include detailed project activities with corresponding target duration, start and end dates, and other resource requirements, among others. The Project Implementation Plan shall also include, among others, the following:

- 5.2.1. System Configuration and Installation Plan with S-Curve
- 5.2.2. Network Test Plan
- 5.2.3. System Acceptance Plan
- 5.2.4. Submission of Architecture and Framework GPPB-TSO Network
- 5.2.5. List of the Supplier/Service Provider's personnel and their respective assignments to the project.
- 5.2.6. Other requirements that may be required by the GPPB-TSO.

5.3. Project Documentation

- 5.3.1. Technical Specifications and/or Data Sheets of all devices.
- 5.3.2. Preventive Maintenance and Operational Manual of all devices.
- 5.3.3. Network Floor Plan Lay-Out duly signed and sealed by a Professional Electronics Engineer (PECE).
- 5.3.4. Acceptance Testing Report on GPPB-TSO Network
- 5.3.5. And other documents that may be required by the GPPB-TSO for proper documentation of the Project.

5.4. After-project Enterprise Support and Warranty

- 5.4.1. The required warranty for all active network equipment and peripherals shall be one (1) year from the date of acceptance of the project.
- 5.4.2. The Supplier/Service Provider Technical Support shall be available for technical support and/or inquiries, through email or telephone/mobile call and on-site, for a period of at least one (1) year after the acceptance of the project.
 - a. Troubleshooting

- b. Other necessary support services
- 5.4.3. Conduct annual preventive maintenance during the warranty period for all the components of the solution.
- 5.4.4. Contractor shall be responsible for all the costs related to the warranty period for hardware products.
- 5.4.5. Delivered devices and its components or parts shall be made available for at least five (5) years upon delivery.

5.5. Bill of Quantities

Item	Description	Quantity	Unit
Ground Floor			
1	UTP Cat6 patch cord 2 meters	48	pcs
2	24 port Cat6 Patch Panel loaded with label	2	pcs
3	Horizontal cable manager 1ru	2	pcs
4	24 port Network Switch	1	unit
5	24 port Network Switch (POE)	1	unit
6	10GB SFP+ module duplex MM	2	pcs
7	IDF 2.5FT data cabinet rack wall mounted (with power outlet)	1	unit
8	Wireless Access Point	6	units
9	Fiber Patch Panel 12 port SC loaded MM	1	unit
10	Fiber Patch Cord 1 meter OM3 SC-LC duplex MM	4	pcs
Second Floor			
11	UTP Cat6 patch cord 2 meters	96	pcs
12	24 port Cat6 Patch Panel loaded with label	4	pcs
13	Horizontal cable manager 1ru	4	pcs
14	24 port Network Switch	1	unit
15	24 port Network Switch (POE)	3	units
16	10GB SFP+ module duplex MM	4	pcs
17	IDF 2.5FT data cabinet rack wall mounted (with power outlet)	1	unit
18	Wireless Access Point	9	units
19	Fiber Patch Panel 12 port SC loaded MM	1	unit
20	Fiber Patch Cord 1 meter OM3 SC-LC duplex MM	8	pcs
Third Floor			
21	UTP Cat6 patch cord 2 meters	168	pcs
22	24 port Cat6 Patch Panel loaded with label	7	pcs
23	Horizontal cable manager 1ru	7	pcs
24	Core Switch	1	unit
25	10GB SFP+ module duplex MM	25	pcs
26	24 port Network Switch	2	units
27	24 port Network Switch (POE)	1	unit
28	10GB SFP+ module duplex MM	3	pcs
29	IDF 7FT data cabinet rack free standing (with fixed tray and power outlet)	1	unit
30	Wireless Access Point	7	units
31	Fiber Patch Panel 48 port SC loaded MM	1	unit
32	Fiber Patch Cord 1 meter OM3 SC-LC duplex MM	60	pcs
33	Fiber Cable 8 Core MM Data Backbone	500	mtrs
34	Network Attached Storage (with 12 pcs. Hard Disk Drive)	1	unit

35	2KVA UPS	1	unit
Fourth Floor			
36	UTP Cat6 patch cord 2 meters	48	pcs
37	24 port Cat6 Patch Panel loaded with label	2	pcs
38	Horizontal cable manager 1ru	2	pcs
39	24 port Network Switch	1	unit
40	24 port Network Switch (POE)	1	units
41	10GB SFP+ module duplex MM	2	pcs
42	IDF 2.5FT data cabinet rack wall mounted (with power outlet)	1	unit
43	Wireless Access Point	6	units
44	Fiber Patch Panel 12 port SC loaded MM	1	unit
45	Fiber Patch Cord 1 meter OM3 SC-LC duplex MM	4	pcs
Fifth Floor			
46	UTP Cat6 patch cord 2 meters	48	pcs
47	24 port Cat6 Patch Panel loaded with label	2	pcs
48	Horizontal cable manager 1ru	2	pcs
49	24 port Network Switch	1	unit
50	24 port Network Switch (POE)	1	units
51	10GB SFP+ module duplex MM	2	pcs
52	IDF 2.5FT data cabinet rack wall mounted (with power outlet)	1	unit
53	Wireless Access Point	7	units
54	Fiber Patch Panel 12 port SC loaded MM	1	unit
55	Fiber Patch Cord 1 meter OM3 SC-LC duplex MM	4	pcs
Sixth Floor			
56	UTP Cat6 patch cord 2 meters	48	pcs
57	24 port Cat6 Patch Panel loaded with label	2	pcs
58	Horizontal cable manager 1ru	2	pcs
59	24 port Network Switch	1	unit
60	24 port Network Switch (POE)	1	unit
61	10GB SFP+ module duplex MM	2	pcs
62	IDF 2.5FT data cabinet rack wall mounted (with power outlet)	1	unit
63	Wireless Access Point	8	units
64	Fiber Patch Panel 12 port SC loaded MM	1	unit
65	Fiber Patch Cord 1 meter OM3 SC-LC duplex MM	4	pcs

Item	Description	Quantity	Unit
	Installation Service, Equipment and Accessories		
1	Labor and Tools including Network Configuration, as-built plans and materials	1	lot

NOTE:

The service provider shall provide all other materials and peripherals necessary for the successful installation of all equipment and the system.

6.0 SELECTION CRITERIA

Qualification Requirements. The Service Provider should be an established IT company with experience in IT Infrastructure and Network Configuration with at least 5 years of experience similar to the project to be bid. They should mobilize key personnel as project managers and at least 3 IT experts, that must meet the following minimum qualifications:

Qualification	Minimum Requirements
<p>Professional Experience (Company)</p> <p><i>The qualifications of IT experts shall be subject to evaluation and validation of the IMD prior to deployment.</i></p>	<ul style="list-style-type: none"> • Should be an established IT company with experience in IT Infrastructure and Network Configuration and undertaken and completed a minimum of three (3) ICT projects in the last five (years). • Should submit copies of client's satisfactory certificates and/or certificates of completion and acceptance from at least three (3) clients for the last five (5) years, with similar contracts. Similar contracts refer to the supply, delivery, and installation of networks and peripherals.

7.0 DURATION OF ENGAGEMENT

The table below presents the target delivery schedule of identified project deliverables for a contract period of four (4) months.

Item No.	Deliverable	Target Delivery Schedule
1	Project Implementation Plan including all enumerated documents required under Item 5.2	Within 10 working days from receipt of the Notice to Proceed
2	Supply, delivery, and installation of all network equipment and hardware including proper configuration and commissioning of all hardware and components	120 calendar days from approval of the implementation plan
3	Admin and User's Training	Within 5 working days from the date of Project Completion
4	Project Documentation	Within 10 working days after the date of Admin and User's Training

The GPPB-TSO shall be given a minimum seven (7) working days-period to review and evaluate each report submitted by the Contractor/Supplier. The period allocated for the GPPB-TSO's review and evaluation shall be deemed not to interrupt or stop the running of Completion Period allocated Contractor/Supplier.

8.0 APPROVED BUDGET FOR THE CONTRACT

The approved budget for this Contract is Six Million Pesos only (PhpP6,000,000.00), inclusive of all applicable tax.

9.0 PAYMENT SCHEME/SCHEDULE

The payment schedule shall be as follows, subject to existing applicable budgeting, accounting, and auditing rules, laws, and regulations:

Item No.	Deliverables	% Payments of Total Value of the Contract
1	Supply and Delivery of Equipment and submission of Work Plan	15%
2	Installation, Testing, and Commission of Equipment and Issuance of Certificate of Completion	45%
3	Issuance of Final Acceptance	40%
TOTAL		100%

10.0 RESPONSIBILITIES OF GPPB-TSO

- 10.1 The GPPB-TSO shall be responsible for the procurement of hardware components and the required services to install commission;
- 10.2 It shall organize a counterpart GPPB-TSO Experts Team composed of subject matter experts and IT Staff, among others, and appoint a Project Leader (internal employee), duly authorized by the GPPB-TSO, who shall be responsible for the overall supervision of the Project and assist the Supplier/Service Provider in the successful implementation of the Project;
- 10.3 Provide pertinent data and other technical information necessary in the Supplier/Service Provider's performance of the service;
- 10.4 Provide a suitable work area to be used by the Supplier/Service Provider during the period of engagement;
- 10.5 The GPPB-TSO shall designate at least two (2) system administrators fully knowledgeable and competent in their functional areas;
- 10.6 The GPPB-TSO shall pay the Supplier/Service Provider in accordance with the payment scheme/schedule as specified in Item XI of this TOR; and
- 10.7 It shall allow the Supplier/Service Provider and its workers to access the facilities and other areas covered by the scope of work and ensure works and staff are compliant to Health Safety Standards.


11.0 OTHER CONDITION

- 11.1 The GPPB-TSO shall not be responsible for any claim for personnel injury or damage including death caused to employees of the Supplier/Service Provider in the performance of their duties.
- 11.2 The Supplier/Service Provider shall abide by all the GPPB-TSO policies and procedures on safety including the application for work permits. For security purposes, the Supplier/Service Provider's shall submit the list of names of the technical team/group assigned on the project.

Revised Plans

SCHEDULE OF FLOOR FINISHES:

- FL1 800 x 800mm POLISHED SYNTHETIC GRANITE TILE FLOOR FINISH
- FL2 800 x 800mm TEXTURED CERAMIC TILE (NON-SKID) FLOOR FINISH - OUTDOOR TYPE (SUBMIT SAMPLE FOR APPROVAL)
- PROVIDE WATER BASE WATERPROOFING FOR TERRACE
- FL3 800 x 800mm CERAMIC TILE FLOOR FINISH (SUBMIT SAMPLE FOR APPROVAL)
- (NOTE: USE 800 x 800mm CERAMIC TILE (NON-SKID) FLOOR FINISH FOR MAIN ENTRANCE STAIR / FIRE EXIT STAIR - TREADS & RISERS)
- FL4 800 x 800mm UNGLAZED VITRIFIED CERAMIC TILE FLOOR FINISH (SIZE & COLOR BY END-USER'S APPROVAL)
- PROVIDE WATER BASE WATERPROOFING
- FL5 NON-SKID CEMENT FLOOR FINISH WITH GROOVE LINES (PROVIDE FLOOR HARDENER)
- FL6 PLAIN CEMENT FLOOR FINISH (PROVIDE FLOOR HARDENER)
- FL7 1820 x 190 x 10mm THK. LAMINATE FLOORING
- FL8 CARPET MAD RIBBED FLOORING

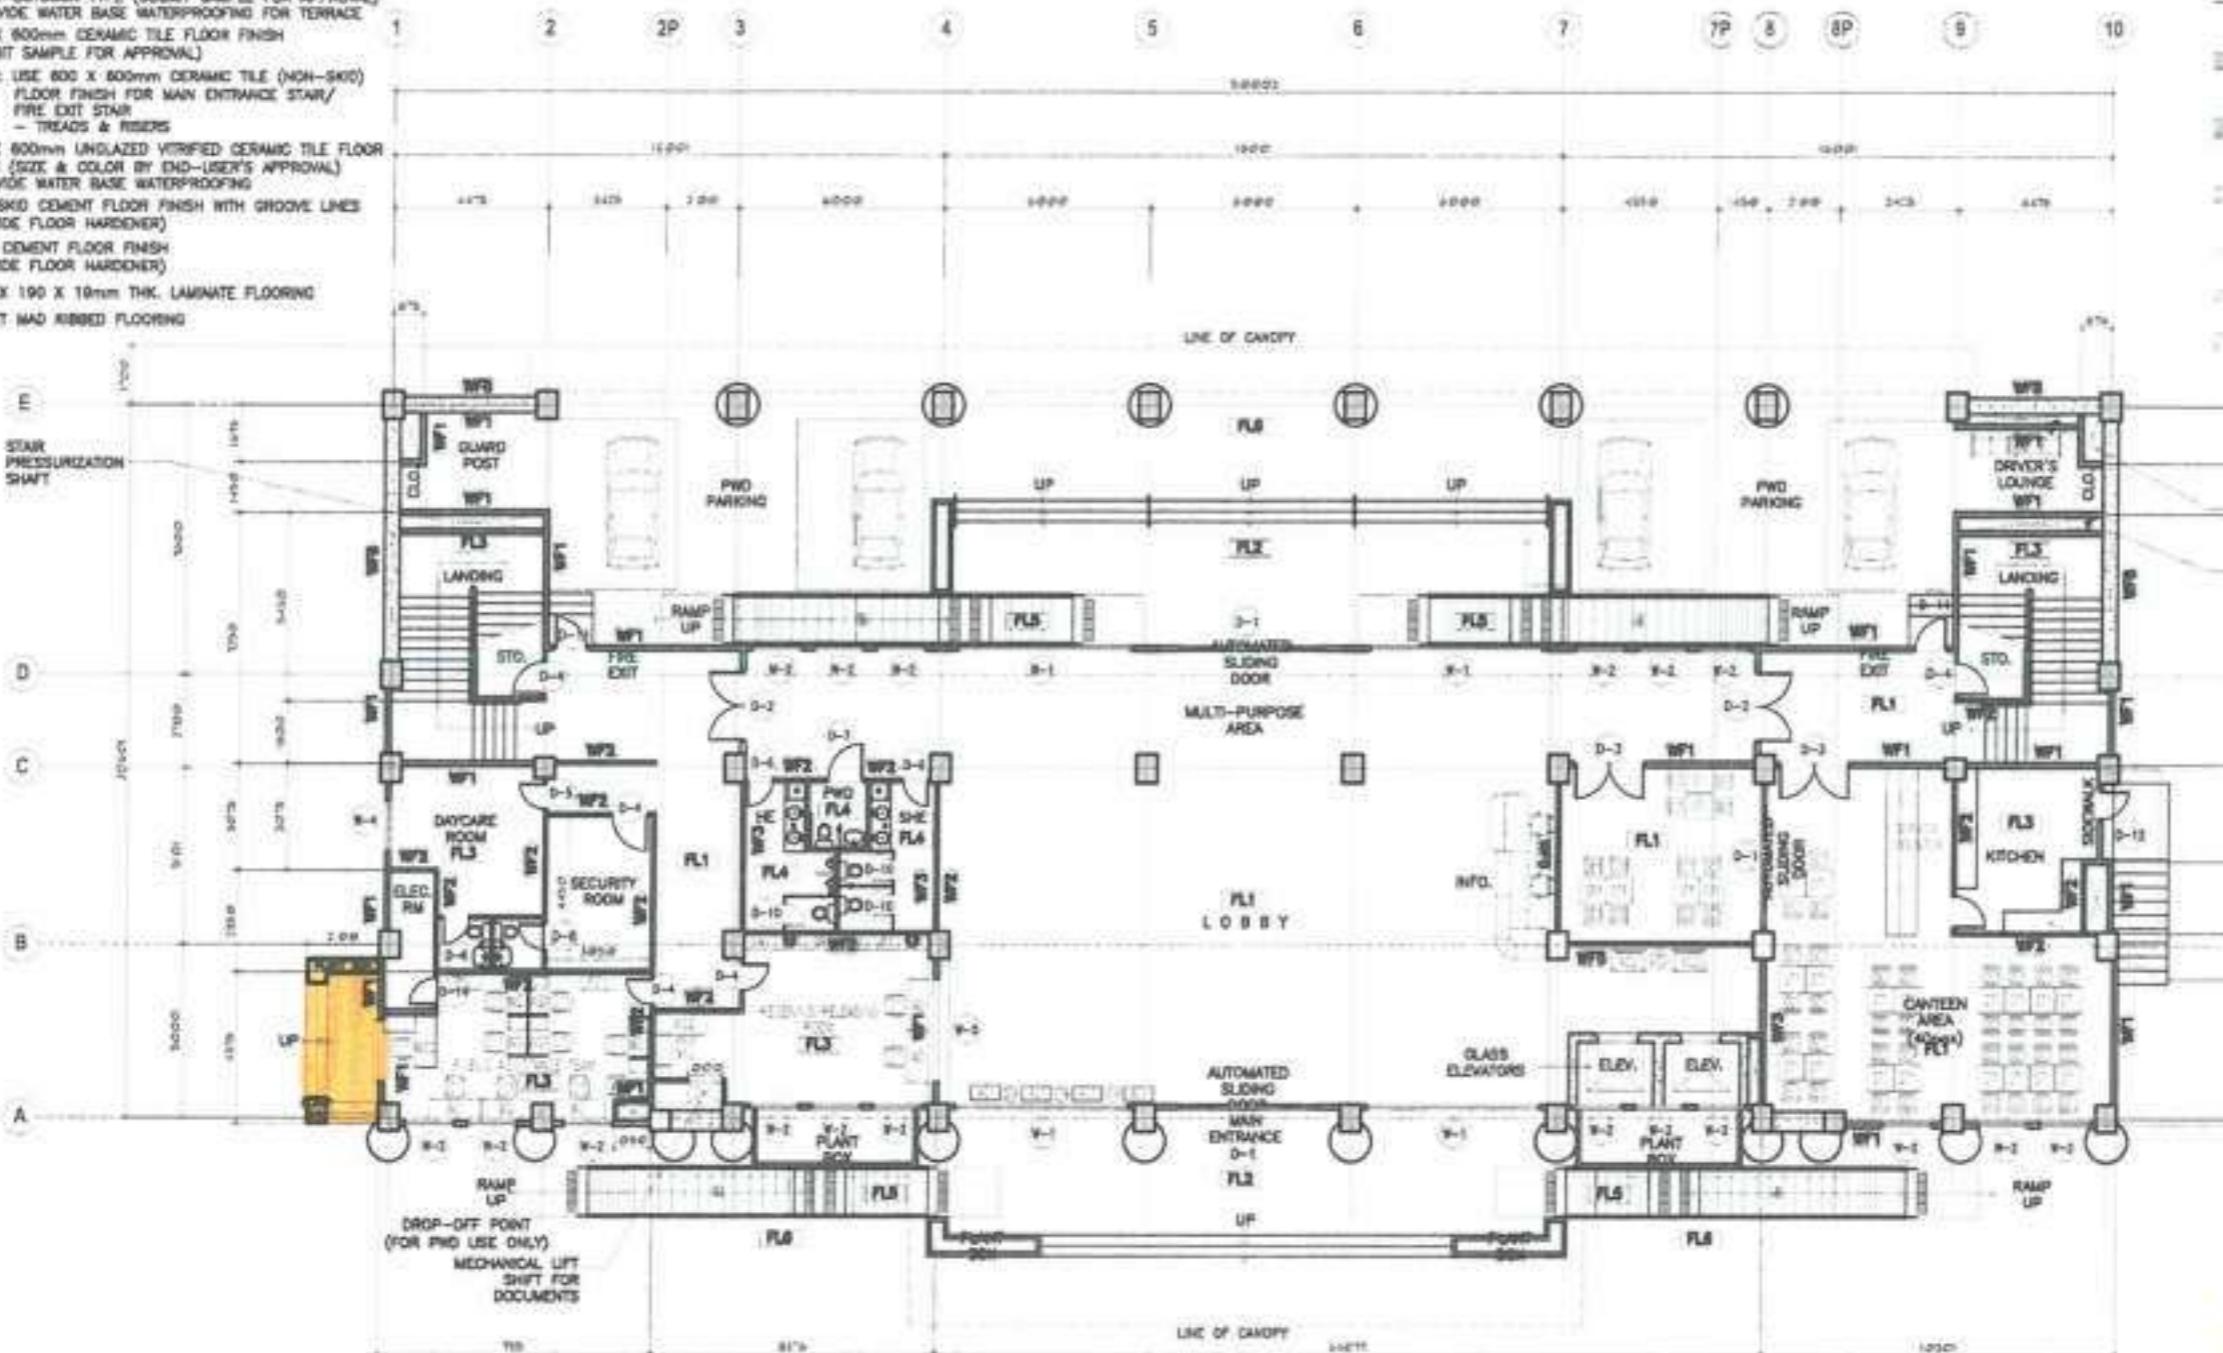

SCHEDULE OF WALL FINISHES:

- WF1 150mm THK. CHB W/ PLASH CEMENT PLASTER (PAINTED FINISH)
- WF2 100mm THK. CHB W/ PLASH CEMENT PLASTER (PAINTED FINISH)
- WF3 100mm THK. CHB W/ 800x800mm VITRIFIED WALL TILES (GLAZED)
- WF4 150mm THK. CHB W/ 600x600mm VITRIFIED WALL TILES (GLAZED)
- WF5 100mm THK. CHB W/ 1820x190x10mm THK. WALL PANELS
- WF6 12mm THK. TEMPERED GLASS
- WF7 DRYWALL PAINTED FINISH
- WF8 REINFORCED CONCRETE WALL

STAINLESS STEEL, KITCHEN AND FOOD SERVICE EQUIPMENT BY OWNER'S SUPPLIED


This concern will focus mainly for partitions and room layouts

APPROVED BY: *Jenna Emily Ray*
APPROVED DATE: 18 May 2022

REVISED GROUND FLOOR PLAN
A-1 SCALE: 200 UTS

SCHEDULE OF FLOOR FINISHES:

- FL.1 800 X 800mm POLISHED SYNTHETIC GRANITE TILE
FLOOR FINISH
- FL.2 800 X 800mm TEXTURED CERAMIC TILE (NON-SKID) FLOOR
FINISH-OUTDOOR TYPE (SUBMIT SAMPLE FOR APPROVAL)
-PROVIDE WATER BASE WATERPROOFING FOR TERRACE
- FL.3 800 X 800mm CERAMIC TILE FLOOR FINISH
(SUBMIT SAMPLE FOR APPROVAL)
(NOTE: USE 800 X 800mm CERAMIC TILE (NON-SKID)
FLOOR FINISH FOR MAIN ENTRANCE STAIR/
FIRE EXIT STAIR
- TREADS & RISERS)
- FL.4 800 X 600mm UNGLAZED VITRIFIED CERAMIC TILE FLOOR
FINISH (SIZE & COLOR BY END-USER'S APPROVAL)
-PROVIDE WATER BASE WATERPROOFING
- FL.5 NON-SKID CEMENT FLOOR FINISH WITH GROOVE LINES
(PROVIDE FLOOR HARDENER)
- FL.6 PLAIN CEMENT FLOOR FINISH
(PROVIDE FLOOR HARDENER)
- FL.7 1820 X 180 X 18mm THK. LAMINATE FLOORING
- FL.8 CARPET MAD RIBBED FLOORING

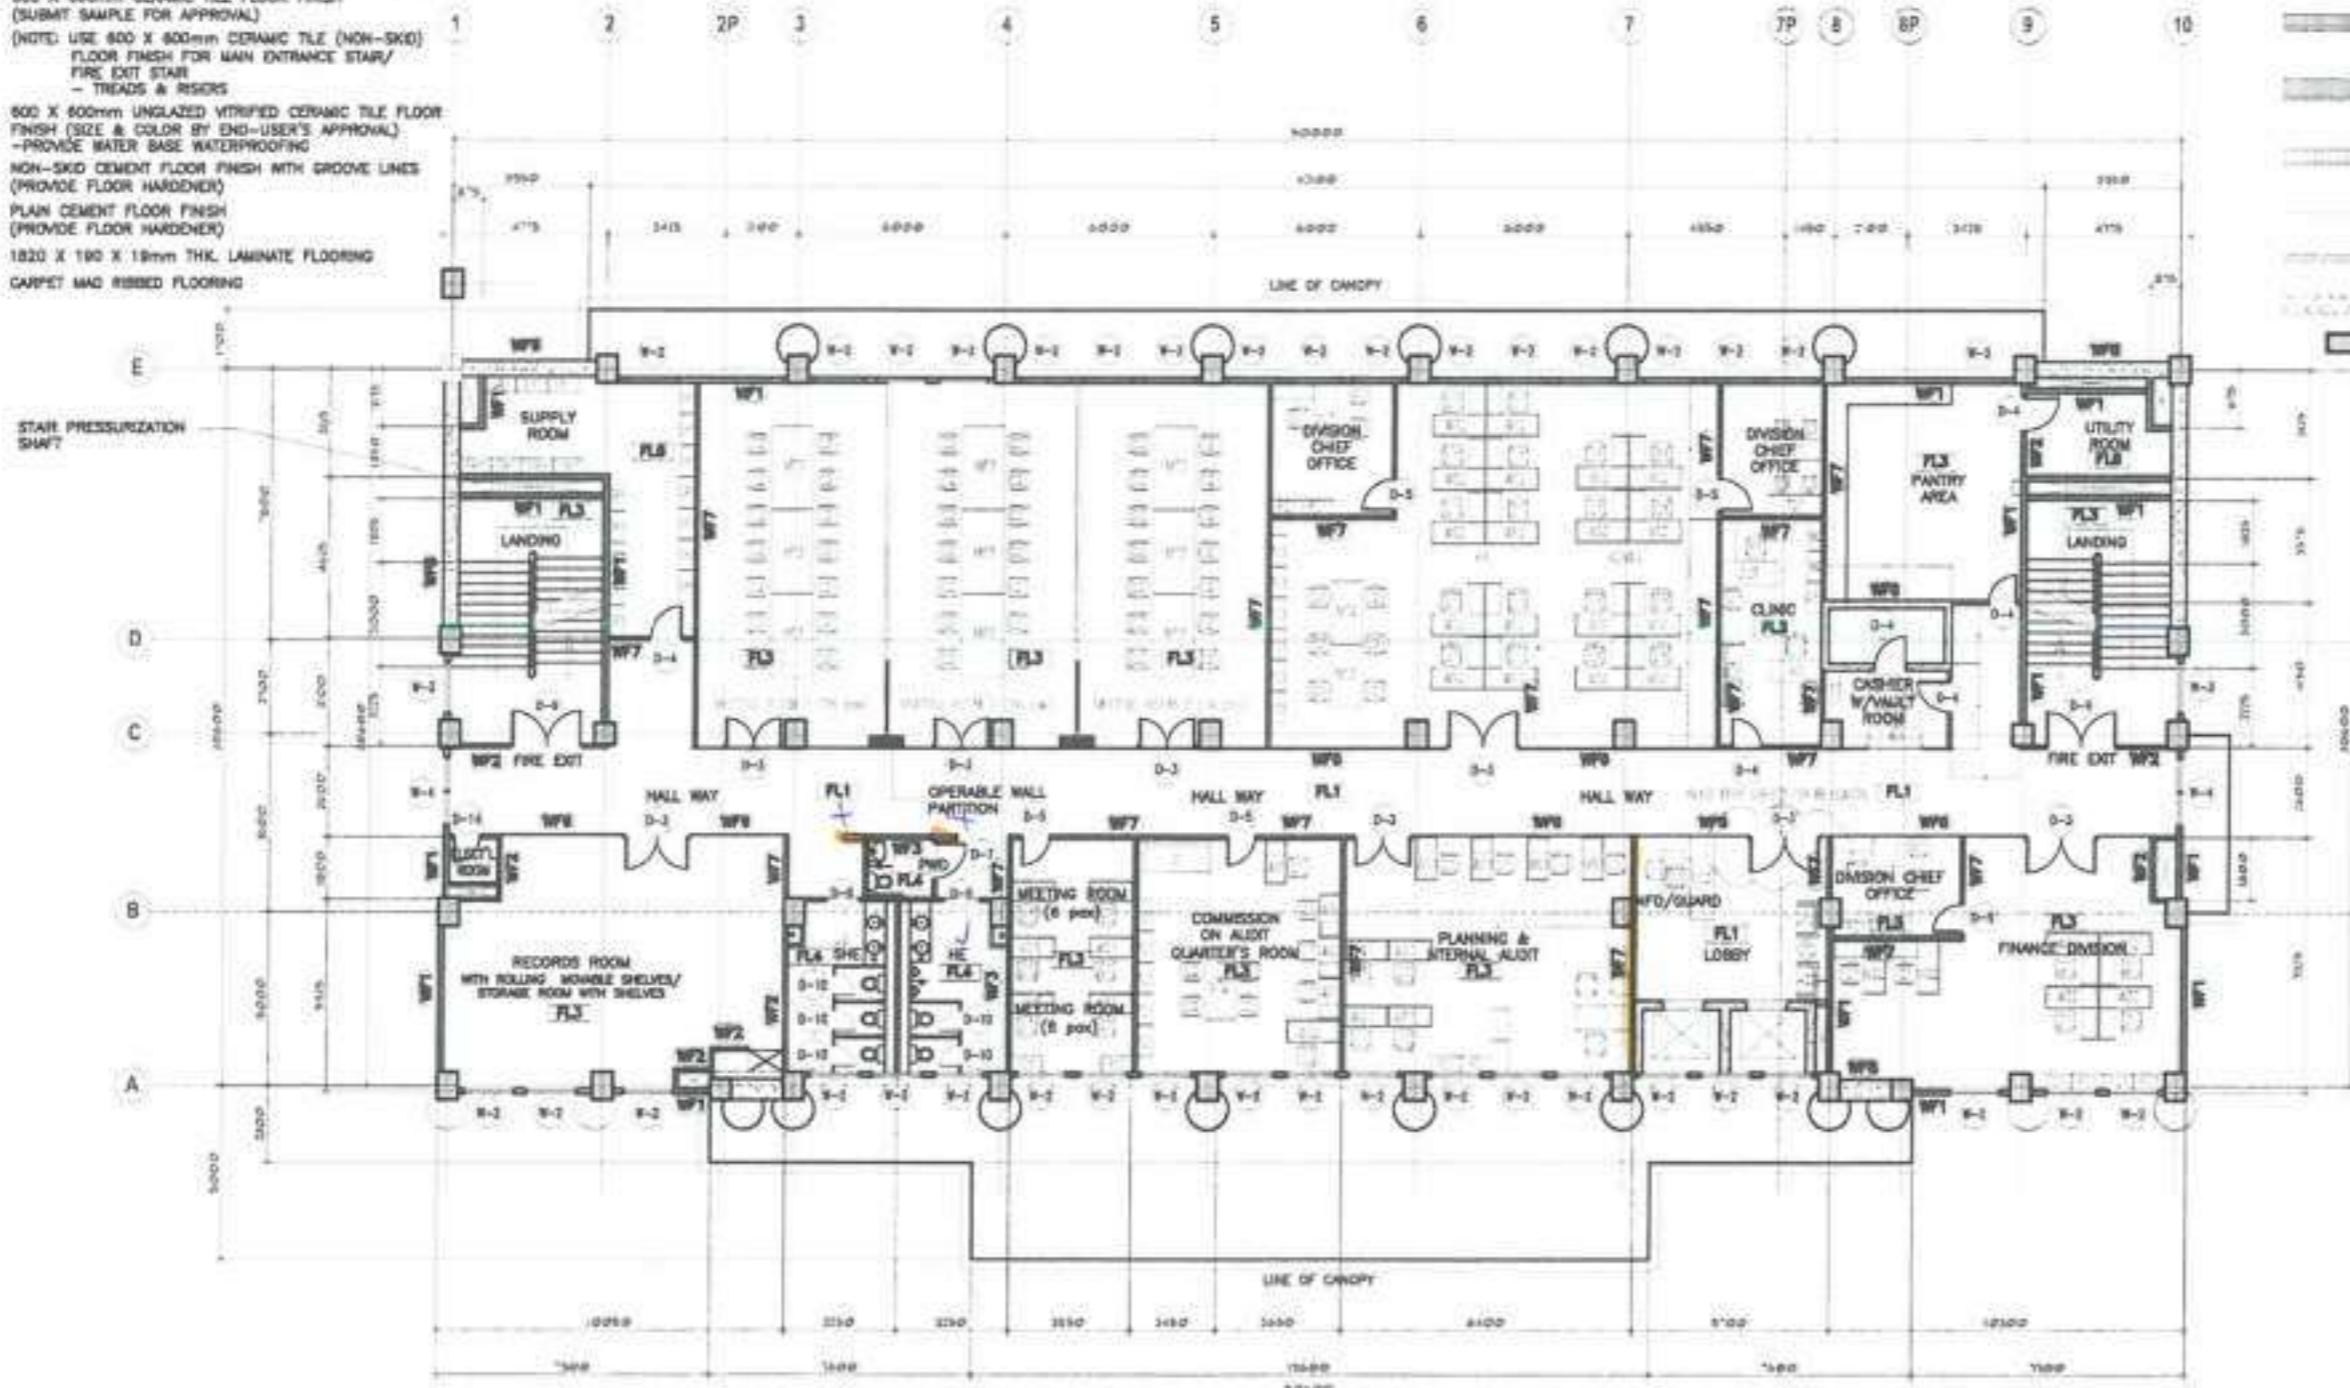

Received document
on May 13, 2022

APPROVED BY:	<i>Gina Amear Bay</i>
APPROVED DATE:	18 May 2022

REVISED SECOND FLOOR PLAN
A-2 SCALE 200 MTS

SCHEDULE OF FLOOR FINISHES:

- FL1 800 x 800mm POLISHED SYNTHETIC GRANITE TILE
FLOOR FINISH
FL2 800 x 800mm TEXTURED CERAMIC TILE (NON-SKID) FLOOR
FINISH-OUTDOOR TYPE (SUBMIT SAMPLE FOR APPROVAL)
-PROVIDE WATER BASE WATERPROOFING FOR TERRACE
FL3 800 x 800mm CERAMIC TILE FLOOR FINISH
(SUBMIT SAMPLE FOR APPROVAL)
(NOTE: USE 800 x 800mm CERAMIC TILE (NON-SKID)
FLOOR FINISH FOR MAIN ENTRANCE STAIR/
FIRE EXIT STAIR
- TREADS & RISERS)
FL4 800 x 800mm UNGLAZED VITRIFIED CERAMIC TILE FLOOR
FINISH (SIZE & COLOR BY END-USER'S APPROVAL)
-PROVIDE WATER BASE WATERPROOFING
FL5 NON-SKID CEMENT FLOOR FINISH WITH GROOVE LINES
(PROVIDE FLOOR HARDENER)
FL6 PLAIN CEMENT FLOOR FINISH
(PROVIDE FLOOR HARDENER)
FL7 1820 x 180 x 18mm THK. LAMINATE FLOORING
FL8 CARPET MAD RIBBED FLOORING



SCHEDULE OF FLOOR FINISHES:

- FL1 800 X 800mm POLISHED SYNTHETIC GRANITE TILE
FLOOR FINISH
- FL2 800 X 800mm TEXTURED CERAMIC TILE (NON-SKID) FLOOR
FINISH-OUTDOOR TYPE (SUBMIT SAMPLE FOR APPROVAL)
-PROVIDE WATER BASE WATERPROOFING FOR TERRACE
- FL3 800 X 800mm CERAMIC TILE FLOOR FINISH
(SUBMIT SAMPLE FOR APPROVAL)
(NOTE: USE 800 X 800mm CERAMIC TILE (NON-SKID)
FLOOR FINISH FOR MAIN ENTRANCE STAIR/
FIRE EXIT STAIR
- TREADS & RISERS)
- FL4 800 X 800mm UNGLAZED VITRIFIED CERAMIC TILE FLOOR
FINISH (925 & COLOR BY END-USER'S APPROVAL)
-PROVIDE WATER BASE WATERPROOFING
- FL5 NON-SKID CEMENT FLOOR FINISH WITH GROOVE LINES
(PROVIDE FLOOR HARDENER)
- FL6 PLAIN CEMENT FLOOR FINISH
(PROVIDE FLOOR HARDENER)
- FL7 1820 X 180 X 18mm THK. LAMINATE FLOORING
- FL8 CARPET MAD RIBBED FLOORING



SCHEDULE OF WALL FINISHES:

- WF1 150mm THK. CHB W/
PLAN CEMENT PLASTER
(PAINTED FINISH)
- WF2 100mm THK. CHB W/
PLAN CEMENT PLASTER
(PAINTED FINISH)
- WF3 100mm THK. CHB W/
600x300mm VITRIFIED
WALL TILES (GLAZED)
- WF4 150mm THK. CHB W/
600x600mm VITRIFIED
WALL TILES (GLAZED)
- WF5 100mm THK. CHB W/
1820x180x18mm
THK. WALL PANELS
- WF6 12mm THK. TEMPERED GLASS
- WF7 DRYWALL PAINTED FINISH
- WF8 REINFORCED CONCRETE WALL


Received documents/plans
on 13 May 2022

APPROVED BY:	<i>Arlena Junilla Bay</i>
APPROVED DATE:	16 May 2022

REVISED FOURTH FLOOR PLAN
A-4 SCALE 200 MTS

SCHEDULE OF FLOOR FINISHES:

- FL1 600 X 600mm POLISHED SYNTHETIC GRANITE TILE FLOOR FINISH
- FL2 600 X 600mm TEXTURED CERAMIC TILE (NON-SKID) FLOOR FINISH-OUTDOOR TYPE (SUBMIT SAMPLE FOR APPROVAL) -PROVIDE WATER BASE WATERPROOFING FOR TERRACE
- FL3 600 X 600mm CERAMIC TILE FLOOR FINISH (SUBMIT SAMPLE FOR APPROVAL) (NOTE: USE 600 X 600mm CERAMIC TILE (NON-SKID) FLOOR FINISH FOR MAIN ENTRANCE STAIR/ FIRE EXIT STAIR - TREADS & RISERS)
- FL4 600 X 600mm UNGLAZED VITRIFIED CERAMIC TILE FLOOR FINISH (SIZE & COLOR BY END-USER'S APPROVAL) -PROVIDE WATER BASE WATERPROOFING
- FL5 NON-SKID CEMENT FLOOR FINISH WITH GROOVE LINES (PROVIDE FLOOR HARDENER)
- FL6 PLAIN CEMENT FLOOR FINISH (PROVIDE FLOOR HARDENER)
- FL7 1820 X 180 X 18mm THK. LAMINATE FLOORING
- FL8 CARPET MAD RIBBED FLOORING

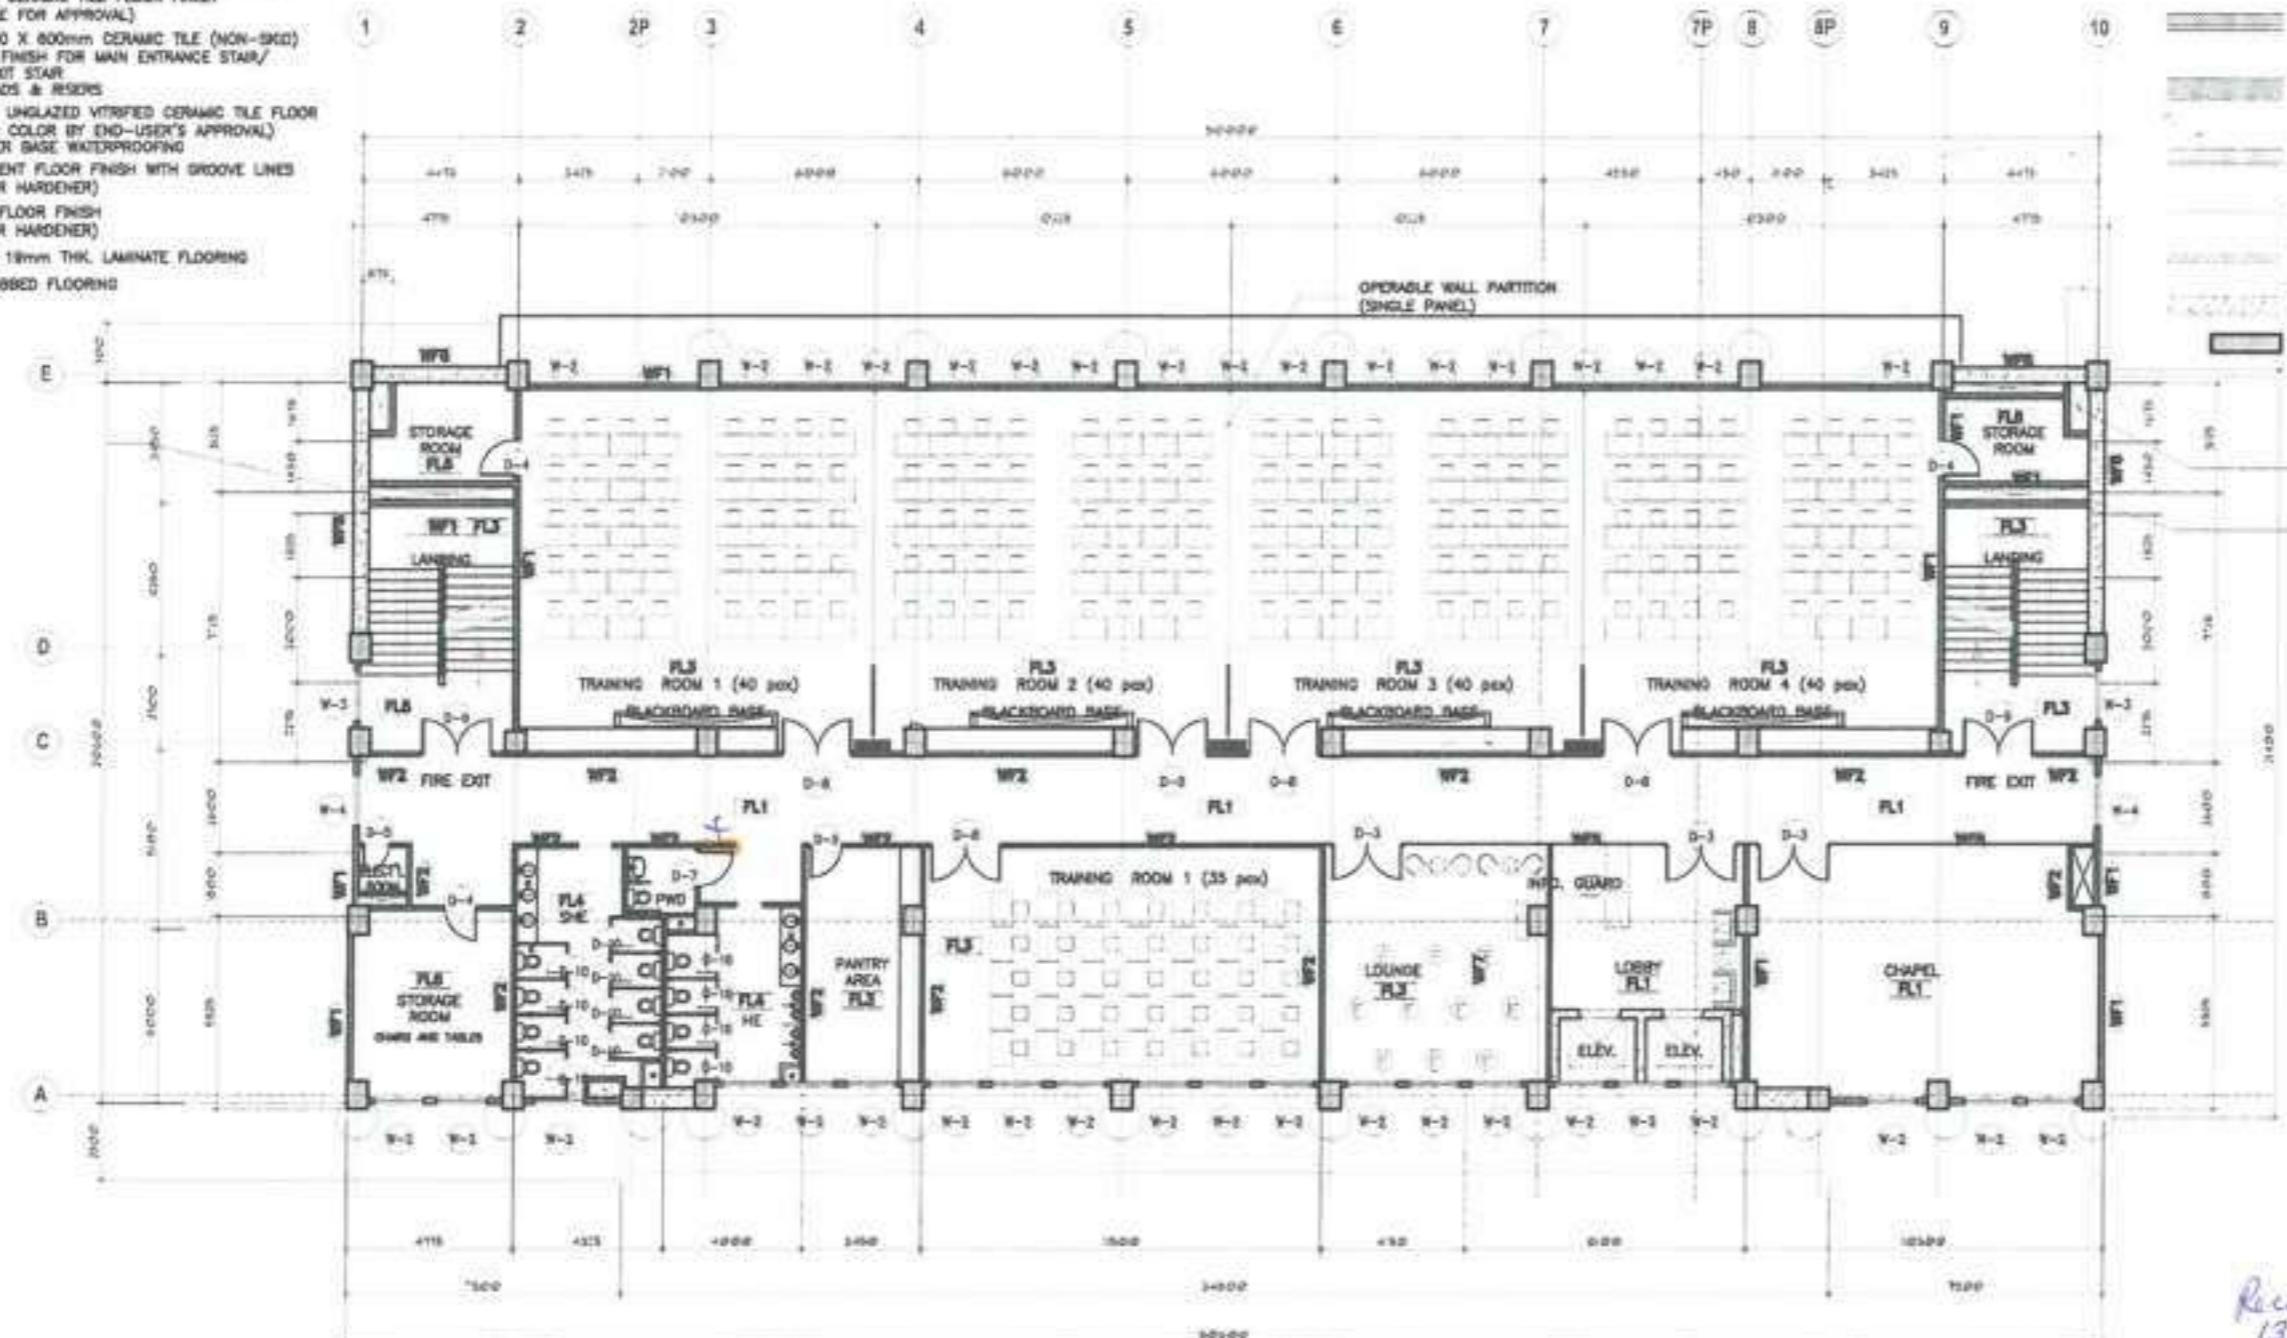

SCHEDULE OF WALL FINISHES:

- WF1 150mm THK. CEB W/ PLAIN CEMENT PLASTER (PAINTED FINISH)
- WF2 100mm THK. CEB W/ PLAIN CEMENT PLASTER (PAINTED FINISH)
- WF3 100mm THK. CEB W/ 600x600mm VITRIFIED WALL TILES (GLAZED)
- WF4 150mm THK. CEB W/ 600x600mm VITRIFIED WALL TILES (GLAZED)
- WF5 100mm THK. CEB W/ 1820x180x18mm THK. WALL PANELS
- WF6 12mm THK. TEMPERED GLASS
- WF7 GYPSUM PAINTED FINISH
- WF8 REINFORCED CONCRETE WALL
- REINFORCED CONCRETE COLUMN
- REFRIGERANT PIPE SHAFT
- STAIR PRESSURIZATION SHAFT


Received document on
13 May 2022

1 REVISED FIFTH FLOOR PLAN
A-5 SCALE

APPROVED BY: *Jeanne Angelina Arg*
APPROVED DATE: 16 May 2022

SCHEDULE OF FLOOR FINISHES:

- FL1 600 X 600mm POLISHED SYNTHETIC GRANITE TILE
FLOOR FINISH
- FL2 600 X 600mm TEXTURED CERAMIC TILE (NON-SKID) FLOOR
FINISH-OUTDOOR TYPE (SUBMIT SAMPLE FOR APPROVAL)
-PROVIDE WATER BASE WATERPROOFING FOR TERRACE
- FL3 600 X 600mm CERAMIC TILE FLOOR FINISH
(SUBMIT SAMPLE FOR APPROVAL)
(NOTE: USE 600 X 600mm CERAMIC TILE (NON-SKID)
FLOOR FINISH FOR MAIN ENTRANCE STAIR/
FIRE EXIT STAIR
- TREADS & RISERS)
- FL4 600 X 600mm UNGLAZED VITRIFIED CERAMIC TILE FLOOR
FINISH (SIZE & COLOR BY END-USER'S APPROVAL)
-PROVIDE WATER BASE WATERPROOFING
- FL5 NON-SKID CEMENT FLOOR FINISH WITH GROOVE LINES
(PROVIDE FLOOR HARDENER)
- FL6 PLAIN CEMENT FLOOR FINISH
(PROVIDE FLOOR HARDENER)
- FL7 1820 X 180 X 18mm THK. LAMINATE FLOORING
- FL8 CARPET MAD RIBBED FLOORING

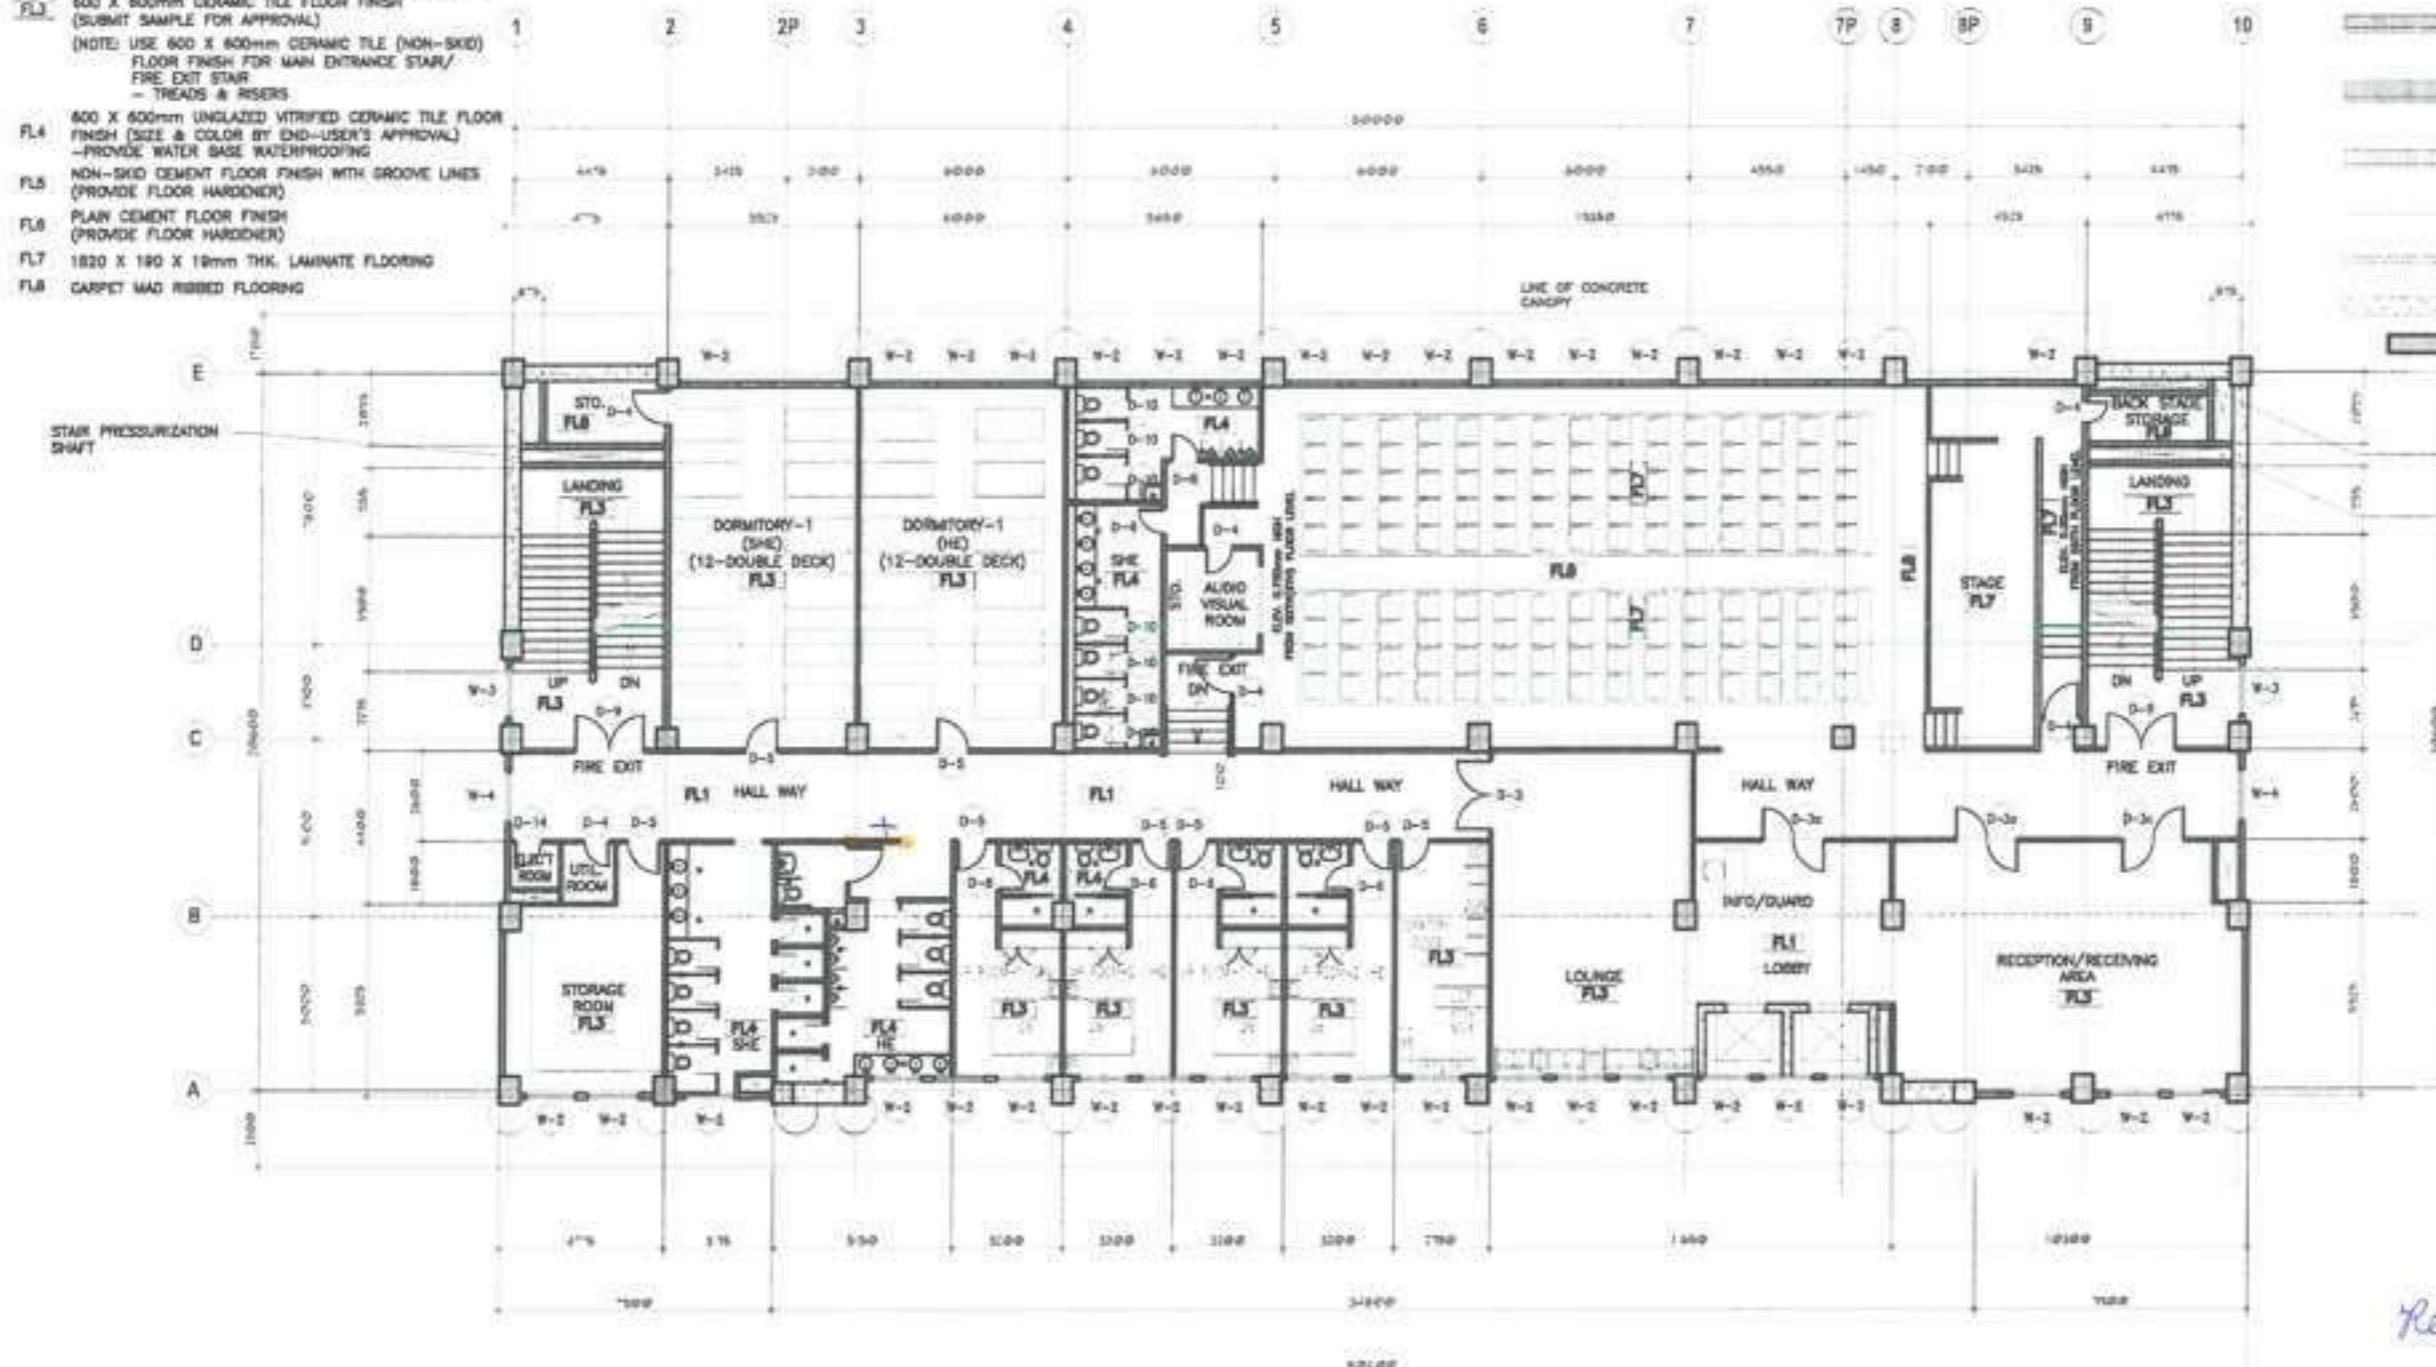

SCHEDULE OF WALL FINISHES:

- WF1 100mm THK. CHB W/
PLAIN CEMENT PLASTER
(PAINTED FINISH)
- WF2 100mm THK. CHB W/
PLAIN CEMENT PLASTER
(PAINTED FINISH)
- WF3 100mm THK. CHB W/
600x600mm VITRIFIED
WALL TILES (GLAZED)
- WF4 150mm THK. CHB W/
600x600mm VITRIFIED
WALL TILES (GLAZED)
- WF5 100mm THK. CHB W/
1820x180x18mm
THK. WALL PANELS
- WF6 12mm THK. TEMPERED GLASS
- WF7 DRYWALL PAINTED FINISH
- WF8 REINFORCED CONCRETE WALL
- WF9 REINFORCED CONCRETE COLUMN
- WF10 REFRIGERANT PIPE
SHAFT
- WF11 STAIR PRESSURIZATION
SHAFT


Received documentation
13 May 2022

APPROVED BY: *Jemma Emilia Arg*
APPROVED DATE: 13 May 2022

A-6 REVISED SIXTH FLOOR PLAN
SCALE: 200' FT/IN

SCHEDULE OF FLOOR FINISHES:


- FL1 900 X 900mm POLISHED SYNTHETIC GRANITE TILE
FLOOR FINISH
- FL2 800 X 800mm TEXTURED CERAMIC TILE (NON-SKID) FLOOR
FINISH-OUTDOOR TYPE (SUBMIT SAMPLE FOR APPROVAL)
-PROVIDE WATER BASE WATERPROOFING FOR TERRACE
- FL3 800 X 800mm CERAMIC TILE FLOOR FINISH
(SUBMIT SAMPLE FOR APPROVAL)
(NOTE: USE 800 X 800mm CERAMIC TILE (NON-SKID)
FLOOR FINISH FOR MAIN ENTRANCE STAIR/
FIRE EXIT STAIR
- TREADS & RISERS)
- FL4 800 X 800mm UNGLAZED VITRIFIED CERAMIC TILE FLOOR
FINISH (SIZE & COLOR BY END-USER'S APPROVAL)
-PROVIDE WATER BASE WATERPROOFING
- FL5 NON-SKID CEMENT FLOOR FINISH WITH GROOVE LINES
(PROVIDE FLOOR HARDENER)
- FL6 PLAIN CEMENT FLOOR FINISH
(PROVIDE FLOOR HARDENER)
- FL7 1820 X 180 X 19mm THK. LAMINATE FLOORING
- FL8 CARPET MAD REEDED FLOORING

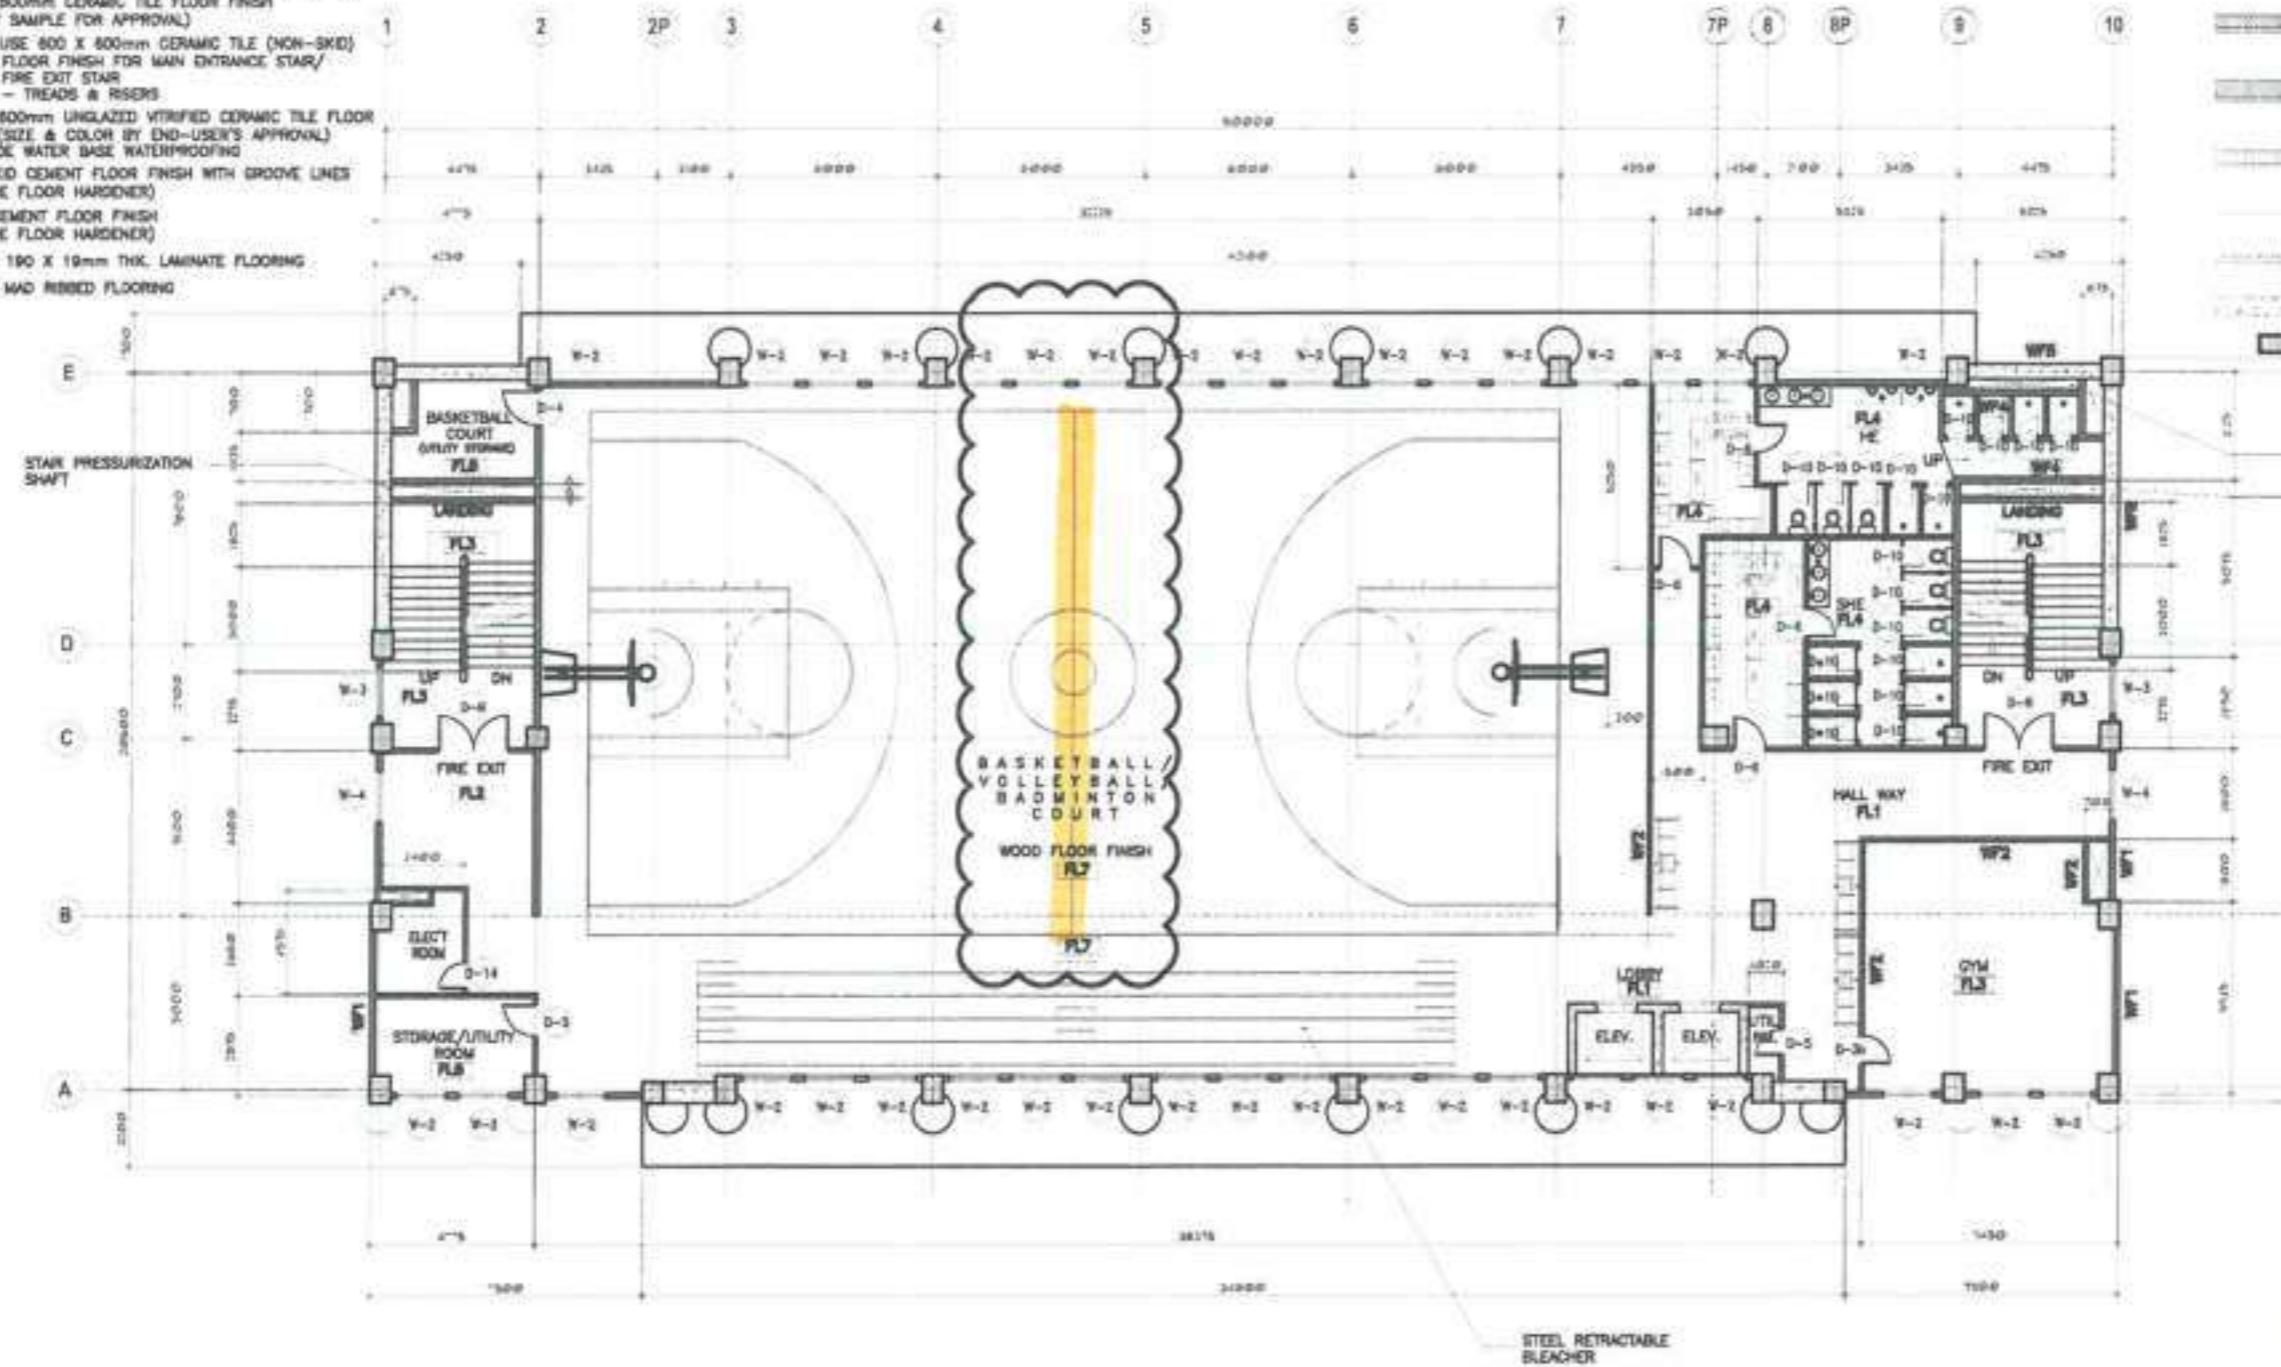

APPROVED BY: *Jenia Jonelis Long*
APPROVED DATE: 18 May 2022

Received document on
13 May 2022

REVISED SEVENTH FLOOR PLAN
A-7 SCALE: 200 MTS

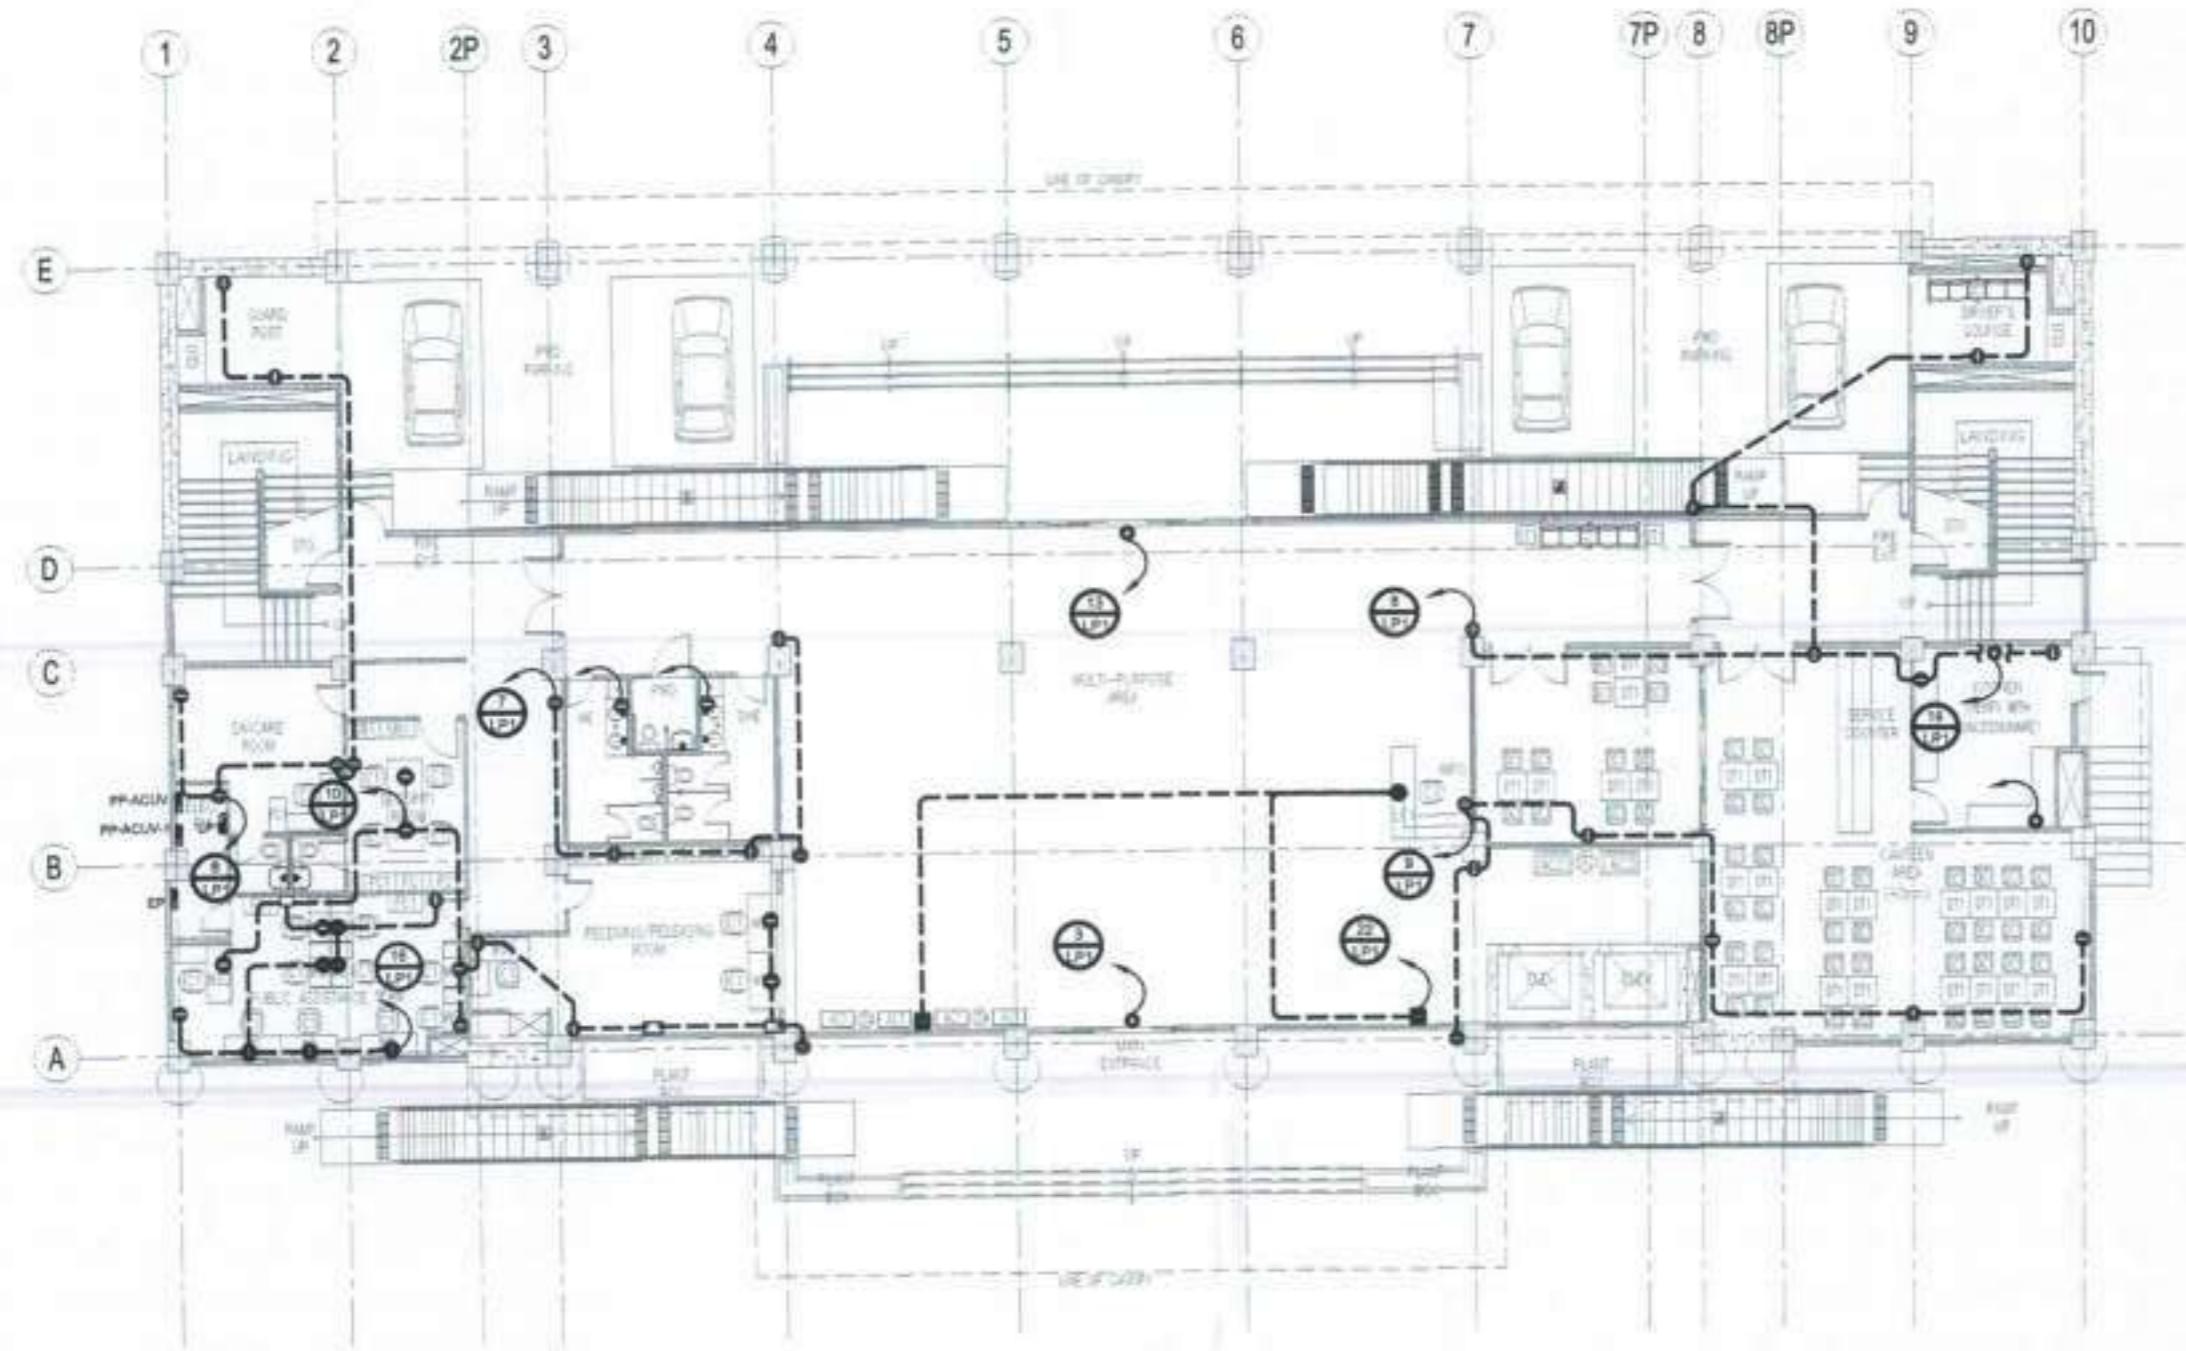

REVISED GROUND FLOOR POWER LAYOUT PLAN

SCALE:


1:100 M.

NOTE:
PURSUANT TO SECTION 4 OF ANNEX 7^a OF THE
REVISED IMPLEMENTING RULES AND REGULATIONS OF RA. 9194,
APPROVAL OF THE AUTHORIZED OFFICIALS OF DETAILED
ENGINEERING SURVEYS AND DESIGN INVESTIGATION BY COMMISSIONER
MUST NOT DIVERTS THE RESPONSIBILITY OF THE LATTER
FOR THE RESPONSIBILITY TO APPROVING OFFICIALS.

THE DESIGNS CONSULTANT SHALL BE HELD FULLY RESPONSIBLE
FOR THE FAILURE OF THE FACILITY DUE TO FAULTY
DESIGN EXCEPT FOR THE CHARGE MADE AGAINST THE
DESIGNER.

ORVILLE R. SINGSON

POSITION: ELECTRICAL ENGINEER
PROF. NO.: 0204011979 TIN No.: 155-029-123
PTB No.: 7223482, C1-29-18, MARIKINA CITY

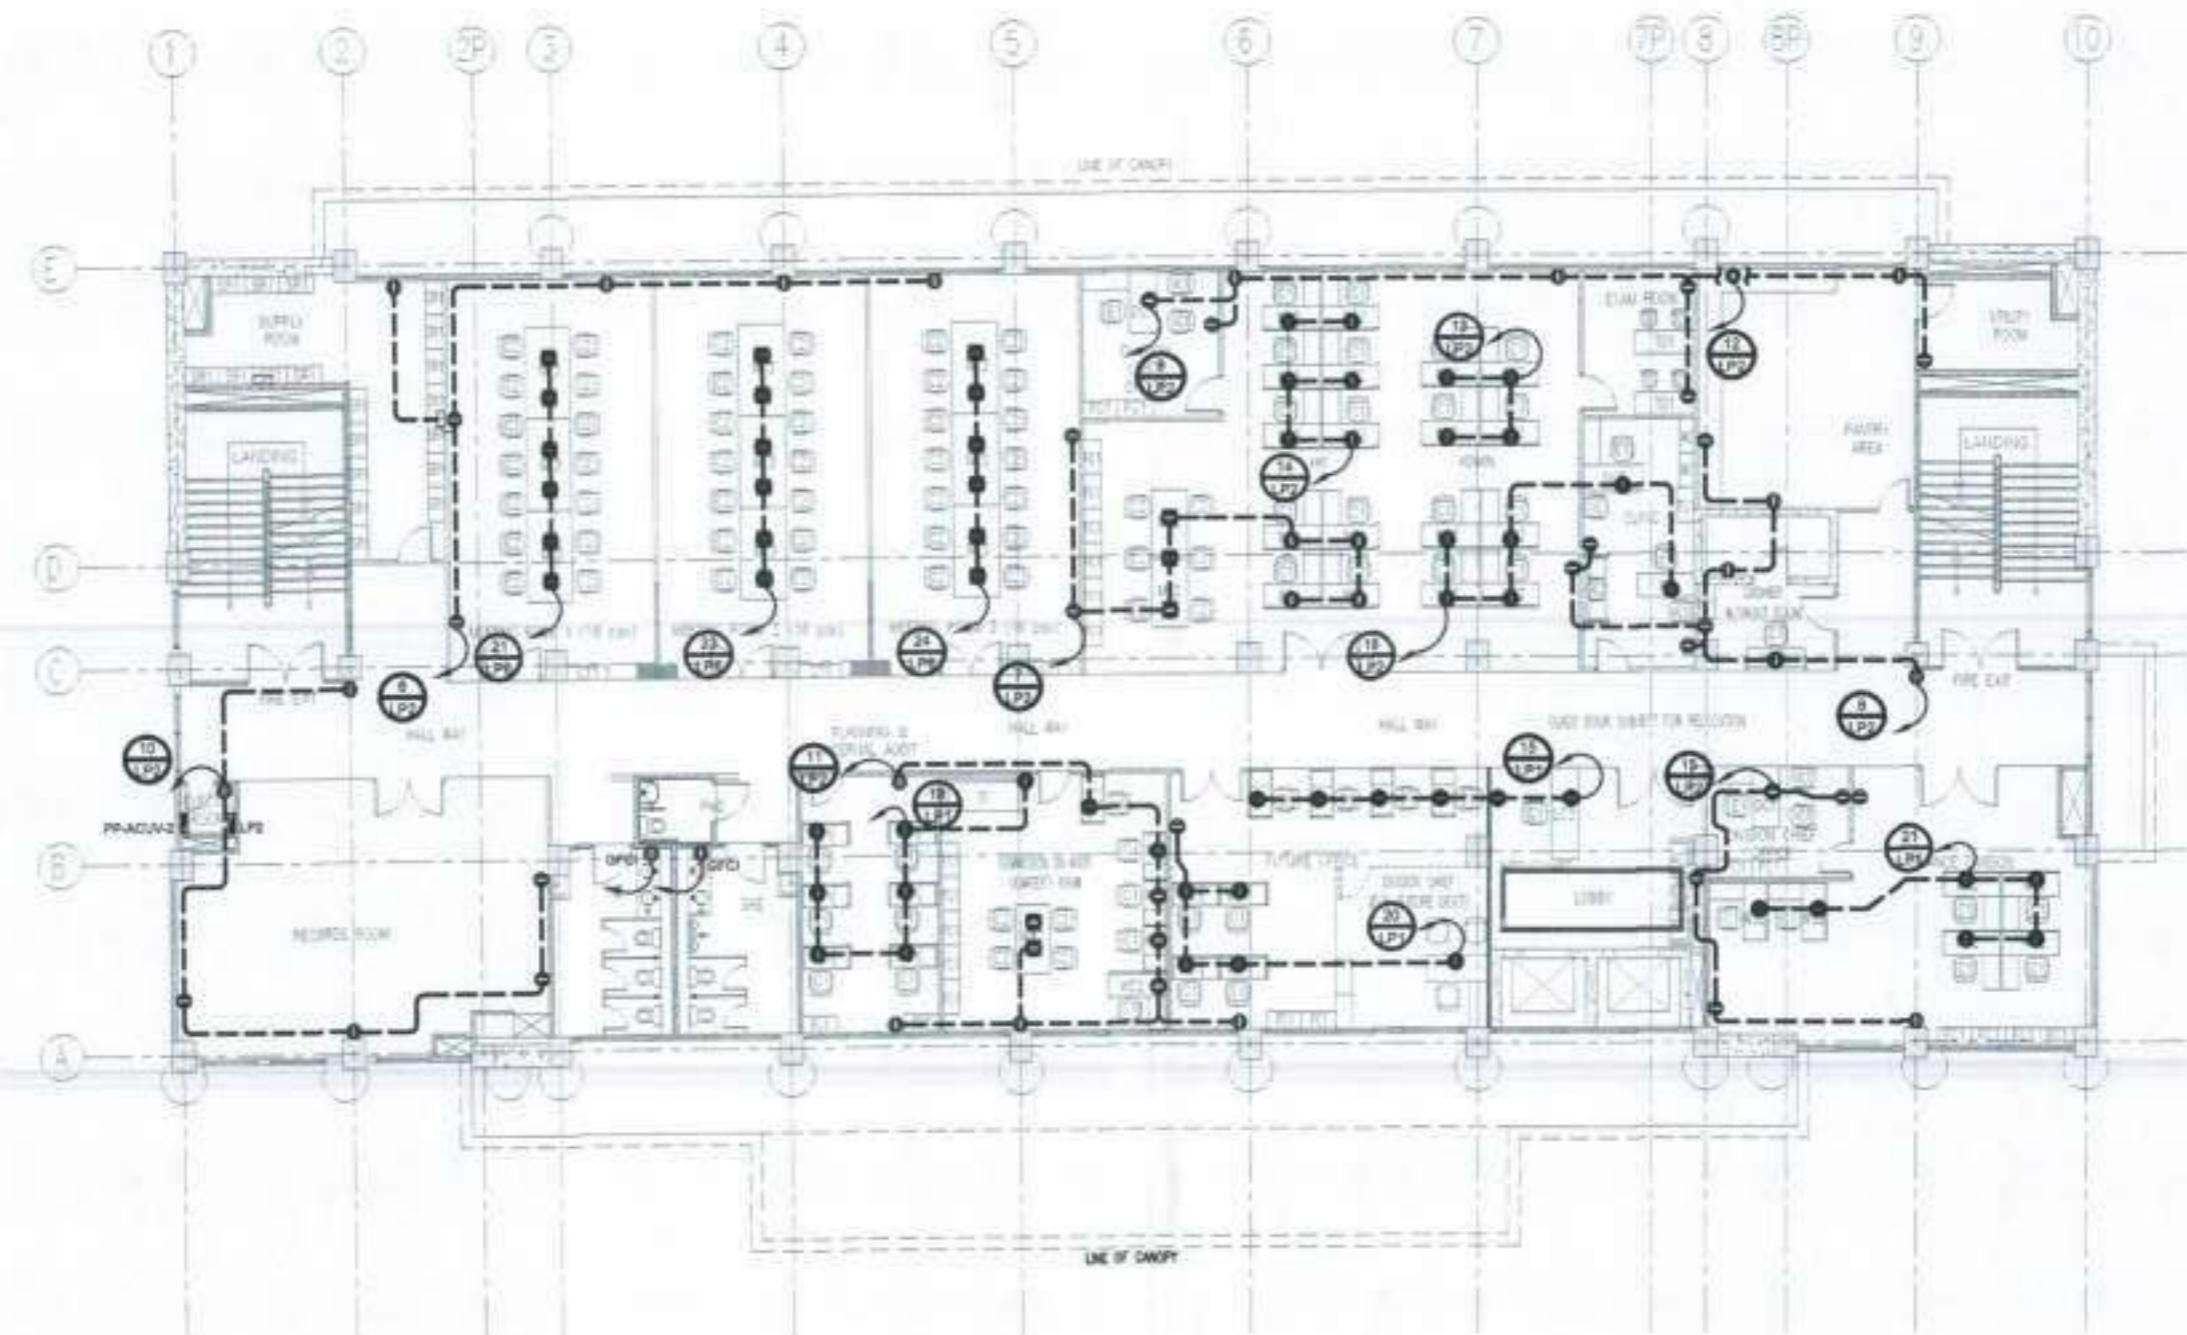

REVISED SECOND FLOOR POWER LAYOUT PLAN

SCALE


1:100 M.

NOTE: PURSUANT TO SECTION 4 OF ANNEX "N" OF THE REVISED IMPLEMENTING RULES AND REGULATIONS OF RA. 9166, APPROVAL BY THE AUTHORIZED SPAN OFFICIALS OF DETAILED ENGINEERING SURVEYS AND DESIGN INTEGRITY BY CONSOLIDATED HERCER CONSULTANTS THE RESPONSIBILITY OF THE LATTER FOR THE RESPONSIBILITY TO APPROVING OFFICIALS.

THE DESIGN CONSULTANT SHALL BE HELD FULLY RESPONSIBLE FOR THE FAILURE OF THE FACILITY DUE TO FAULTY DESIGN EXCEPT FOR THE CHANGES MADE WITHOUT THE OF THE DESIGNER.

ORVILLE R. SINGSON

ELECTRICAL DESIGN
POSITION: ELECTRICAL ENGINEER
PRO No.: 0886011777TR TIN No.: 151-658-125
PTR No.: 722982, D1-03-18, MARINAIA CITY

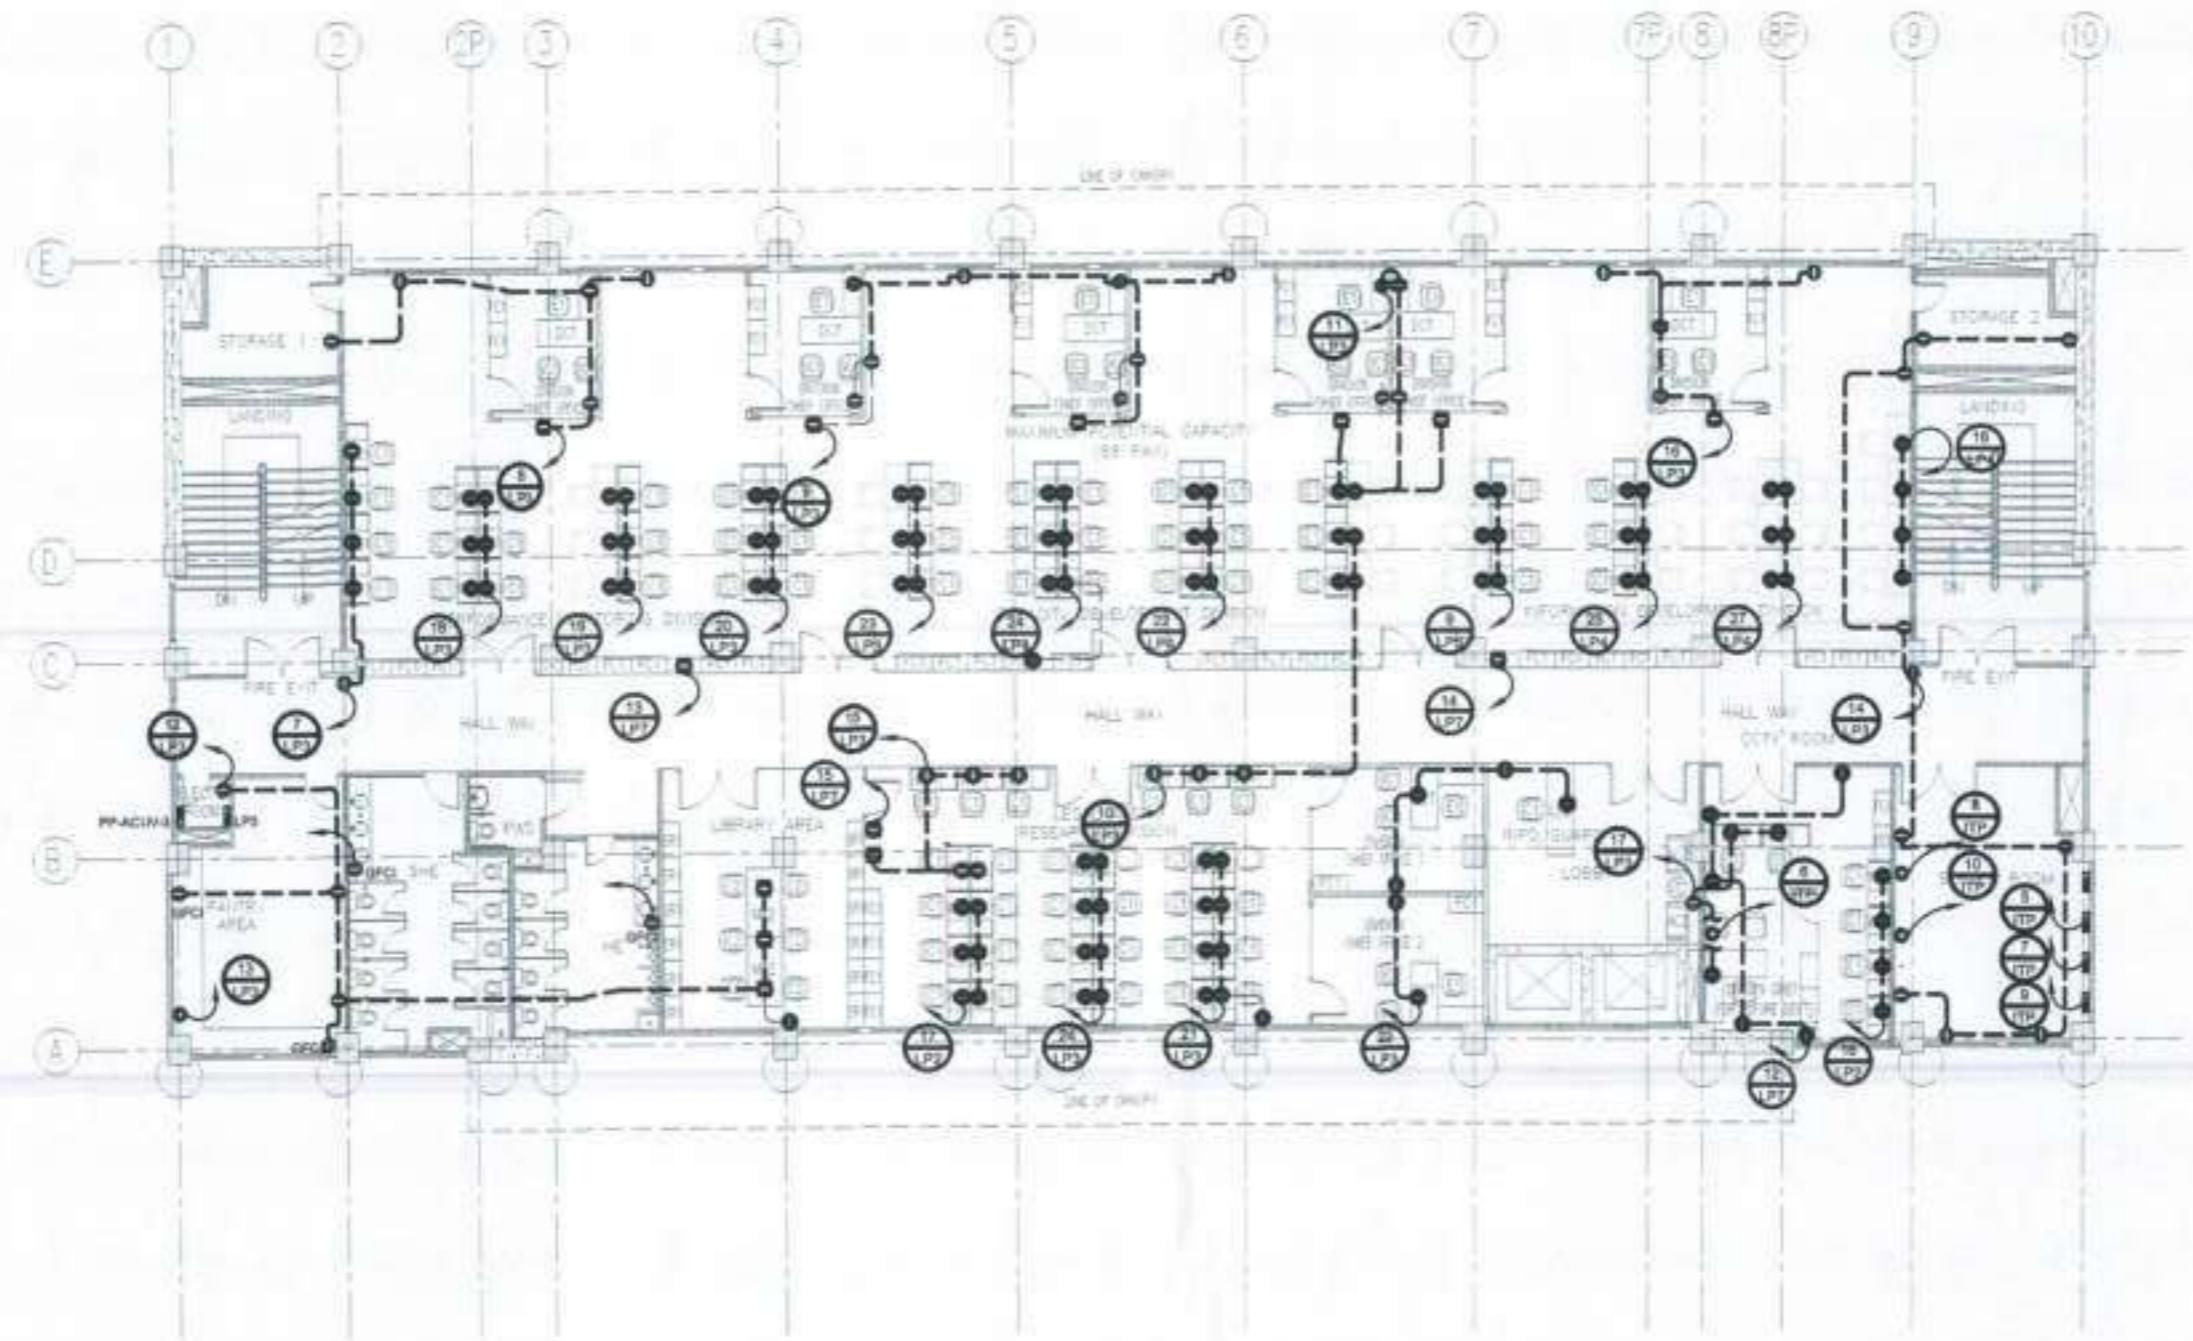

REVISED THIRD FLOOR POWER LAYOUT PLAN

SCAL

1:30 p.m.


NOTE:
PURSUANT TO SECTION 4 OF ANNEX "K" OF THE
REvised IMPLEMENTING RULES AND REGULATIONS OF RA. 9164,
APPROVAL OF THE AUTHORIZED OPEN OFFICIALS OF DENR
DETERMINING SURVEY AND DESIGN UNDERTAKING BY CONSULTANTS
NEITHER IMMINES THE RESPONSIBILITY OF THE LATTER
FOR THE RESPONSIBILITY TO APPROVE OFFICIALS.

THE DESIGN CONSULTANT SHALL BE HELD FULLY RESPONSIBLE FOR THE FAILURE OF THE FACILITY DUE TO FAULTY DESIGN EXCEPT FOR THE CHANGES MADE WITHOUT THE OF THE DESIGNER.

ORVILLE R. SINGSON

ELECTRICAL DESIGN
POSITION: ELECTRICAL ENGINEER
S/N: 080461207PTN TIN NO: 138-038-162
F NO: 7022862, C4-05-1E, MARIBASA CITY

WISMON CONSTRUCTION A DEVELOPMENT CORPORATION D.L. CERVANTES CONSTRUCTION CORPORATION	REVIEWED BY: JARL E. LAQUINDANUM	PAPERWORK DELMYN C. BALCOS PROJECT ENGINEER BSPMC-UPMC	PROJECT NAME AND LOCATION PROPOSED BEVER (2-STORY) GOVERNMENT PROCUREMENT POLICE BOARD TECHNICAL SUPPORT OFFICE (GPPTSO) BUTUAN	BUCKET CONTENTS REVISED TWO FLLOOR POWER LAYOUT PLAN	 REPUBLIC OF THE PHILIPPINES DEPARTMENT OF PUBLIC WORKS AND HIGHWAYS United Project Management (UPM) Buildings and Shared Projects Management Office See Note: DPPM-HDR Compendium for detailed information	CHECKED: VICTOR H. BADILLO PROJECT ENGINEER BSPMC-UPMC	COMMITTED: ANGELINA B. MELCHOR PROJECT MANAGER II BSPMC-UPMC	REVIEWED: ERIBERTO B. SISON CHIEF, BUILDINGS & DIVISION BUREAU OF DESIGN	RECOMMENDED: JOHNSON V. DOMINGO PROJECT DIRECTOR BSPMC-UPMC	APPROVED: EDWIN C. MATANGUIHAN D/C - DIRECTOR BUREAU OF DESIGN	APPROVED: MAXIMO L. CARVAJAL UNDERSECRETARY FOR TECHNICAL SERVICES	SET NO. E 4 11	SET NO. 4 11
100 HO. 1000 PFTO. 1000 HABAGAT PAUCO, 10000, CAGAYAN DE ORO CITY TEL. NO. (083) 445-9400 DATE: 11-06-2015	DATE:	DATE:	DATE:	DATE:		DATE:							

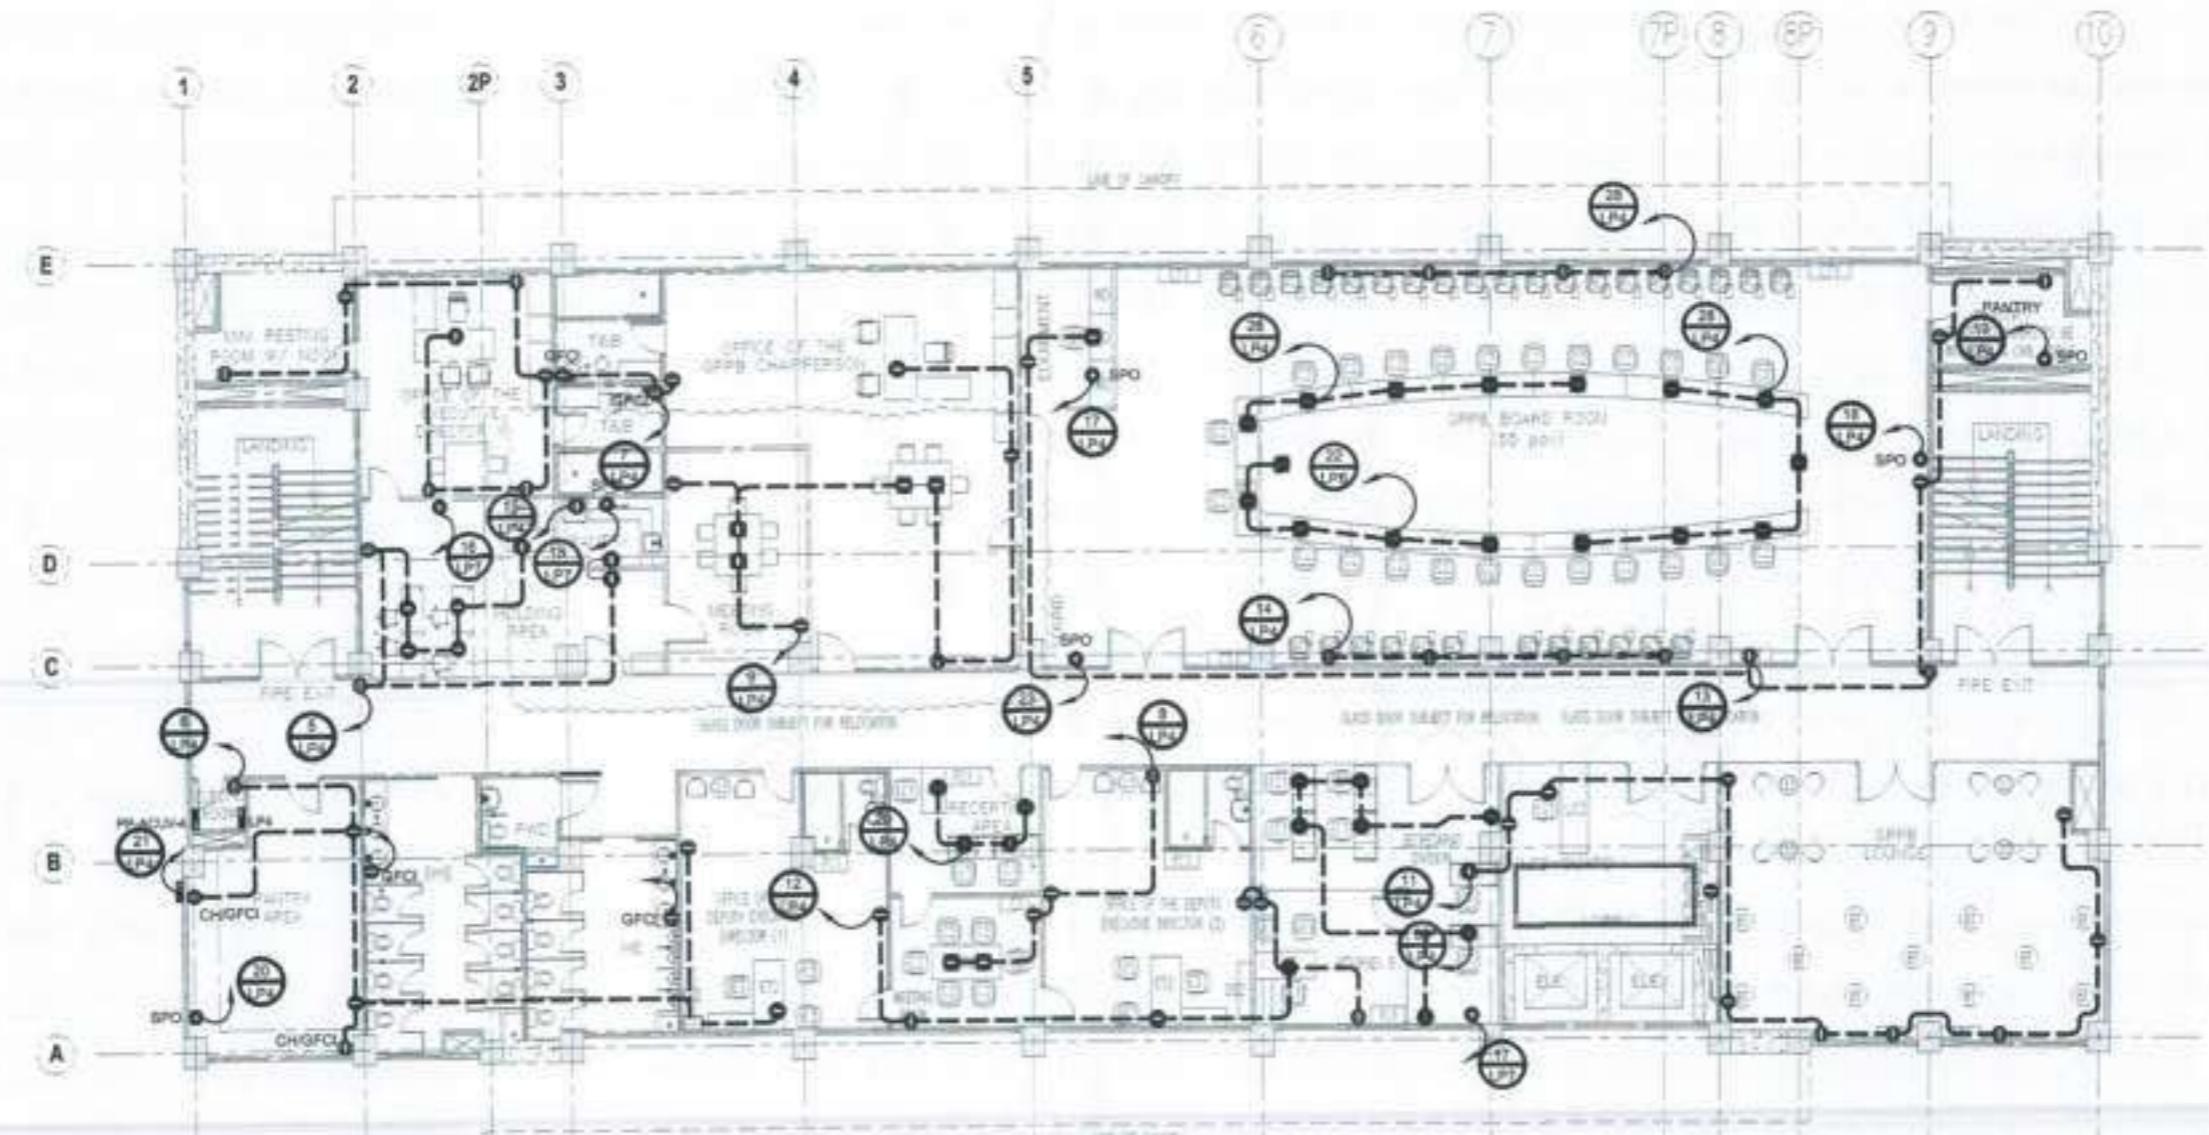

REVISED FOURTH FLOOR POWER LAYOUT PLAN

SCALE:


1:100 M.

NOTE:
PURSUANT TO SECTION 4 OF ANNEX "D" OF THE
REVISED IMPLEMENTING RULES AND REGULATIONS OF RA. 9163,
APPROVAL BY THE AUTHORIZED OFW OFFICIALS OF DETAILED
ENGINEERING DRAWINGS AND DESIGN INVESTIGATION BY CONSULTANTS
NEITHER DIMINISHES THE RESPONSIBILITY OF THE LATTER
FOR THE RESPONSIBILITY TO APPROVING OFFICIALS.

THE DESIGN CONSULTANT SHALL BE HELD FULLY RESPONSIBLE
FOR THE FAILURE OF THE FACILITY DUE TO FAULTY
DESIGN EXCEPT FOR THE CHANGES MADE WITHOUT THE
KNOWLEDGE OF THE DESIGNER.

ORVILLE R. SINGSON

POSITION: ELECTRICAL ENGINEER
PROJ. NO.: 3004011975 - TRN NO.: 101-456-102
PTD NO.: 7232882, 01-29-16, MARINA CITY

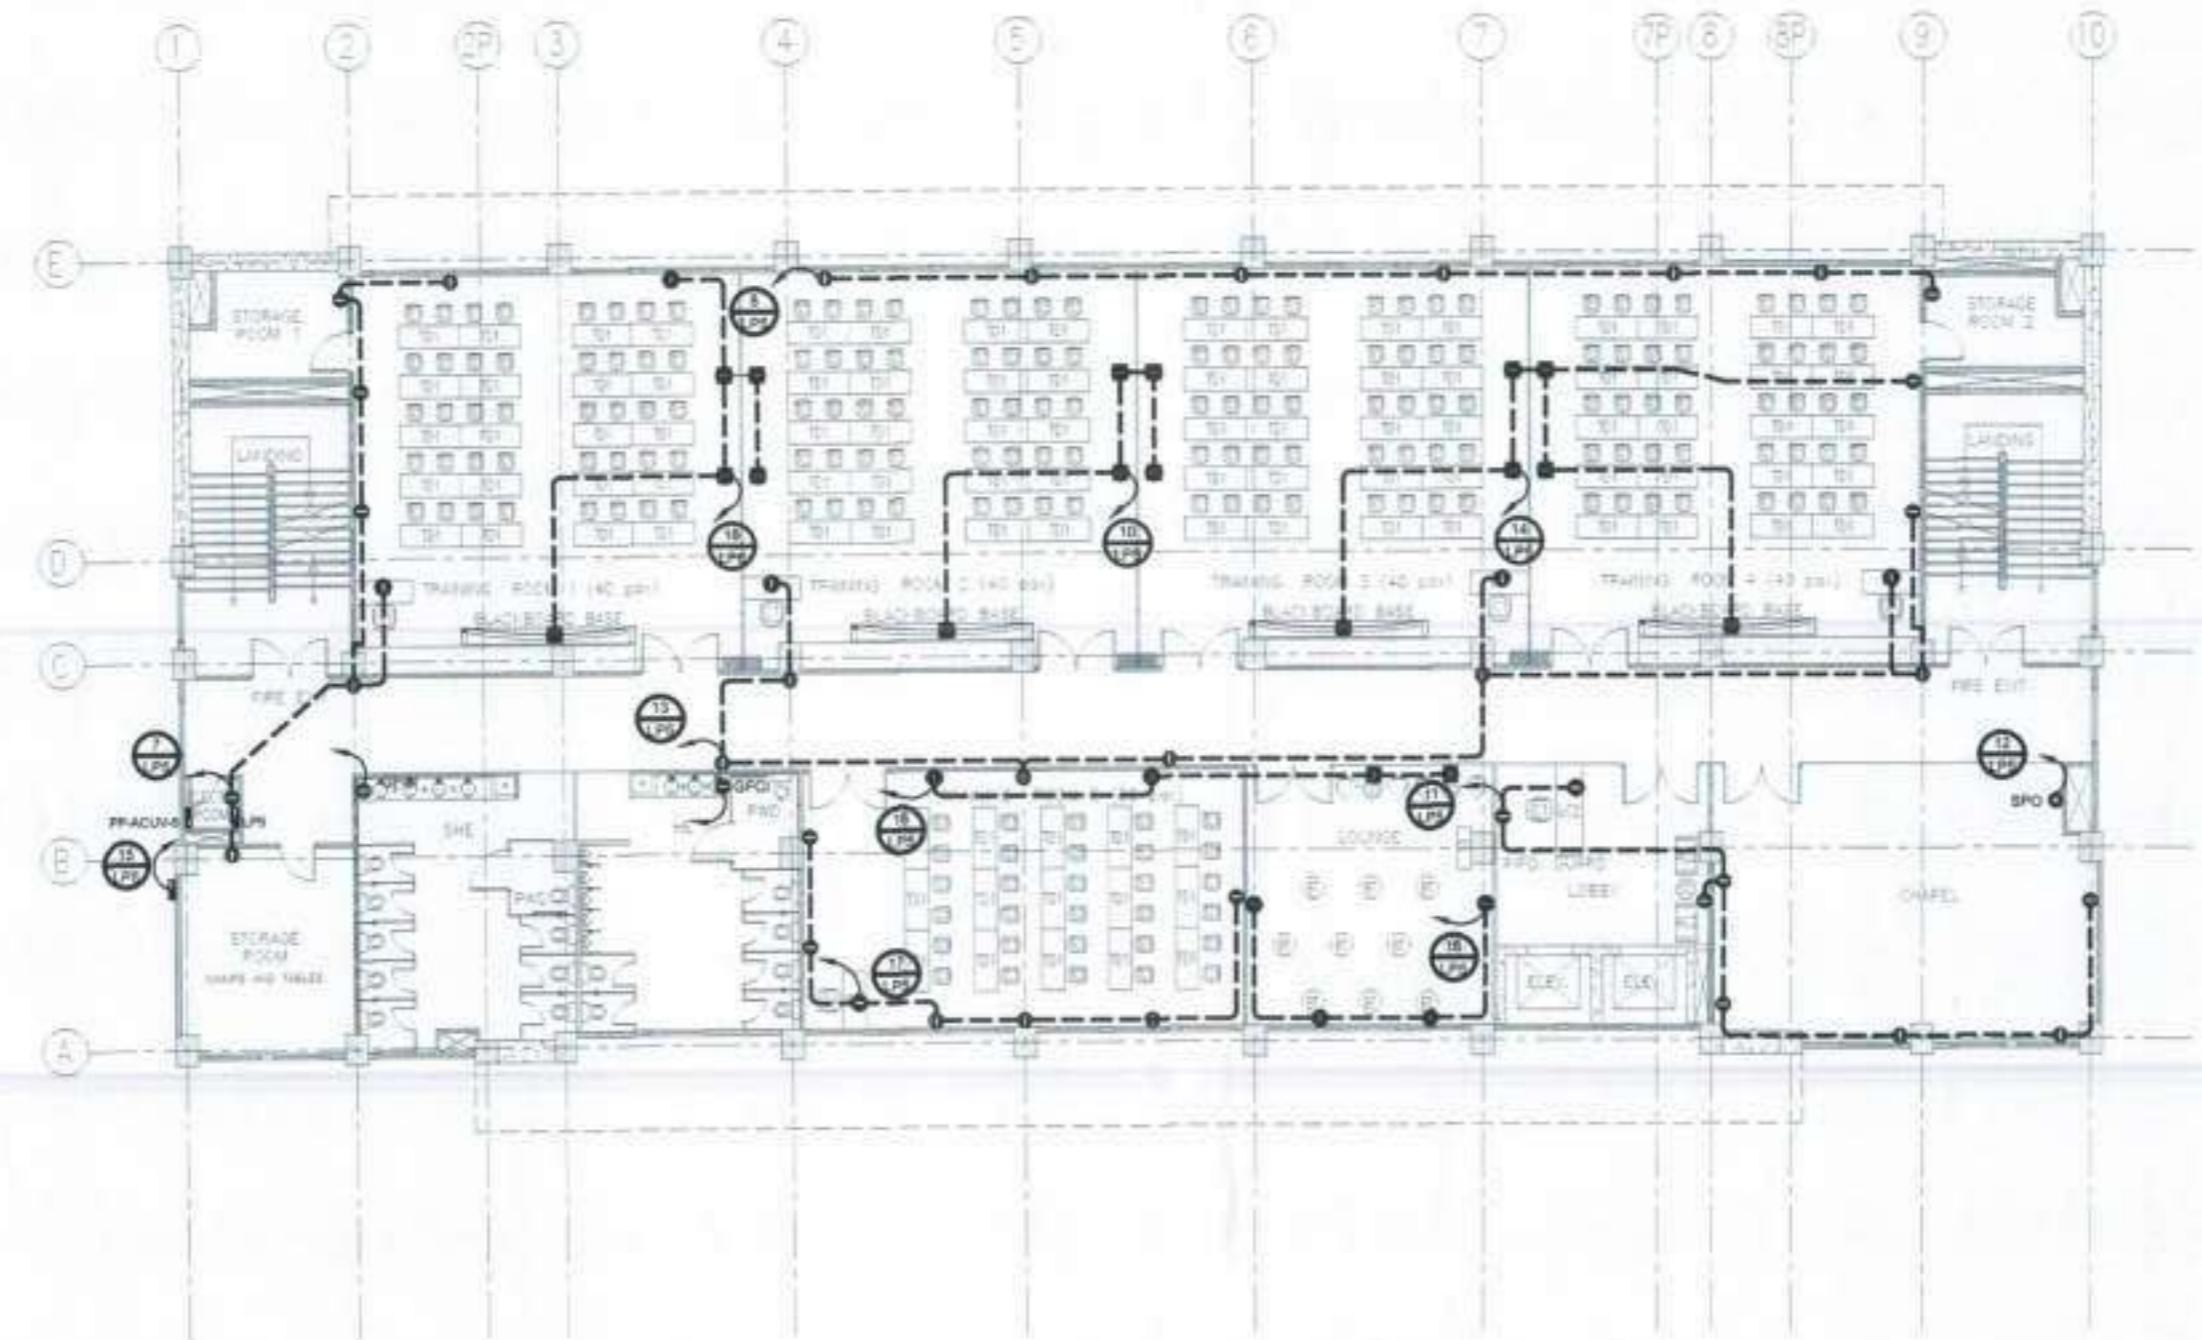

REVISED FIFTH FLOOR POWER LAYOUT PLAN

SCALE:


1:100 M

NOTE:
PURSUANT TO SECTION 4 OF ANNEX 'N' OF THE
REvised Implementing Rules and Regulation of RA. 9123,
APPROVAL OF THE AUTHORIZED DPPM OFFICIALS OF DETAILED
ENGINEERING SURVEYS AND DESIGN INVESTIGATION BY CONSULTANTS
NEITHER DIMINISHES THE RESPONSIBILITY OF THE LATTER
FOR THE RESPONSIBILITY TO APPROVING OFFICIALS.

THE DESIGN CONSULTANT SHALL BE HELD FULLY RESPONSIBLE
FOR THE FAILURE OF THE FACILITY DUE TO FAULTY
DESIGN EXCEPT FOR THE CHANGES MADE WITHOUT THE
OF THE DESIGNER.

ORVILLE R. SINGSON

ELECTRICAL DESIGN
POSITION: ELECTRICAL ENGINEER
PRC No.: 005417PTR TIN No.: 118-438-103
PTIN No.: T2208181-01-02-18, MARINA CITY

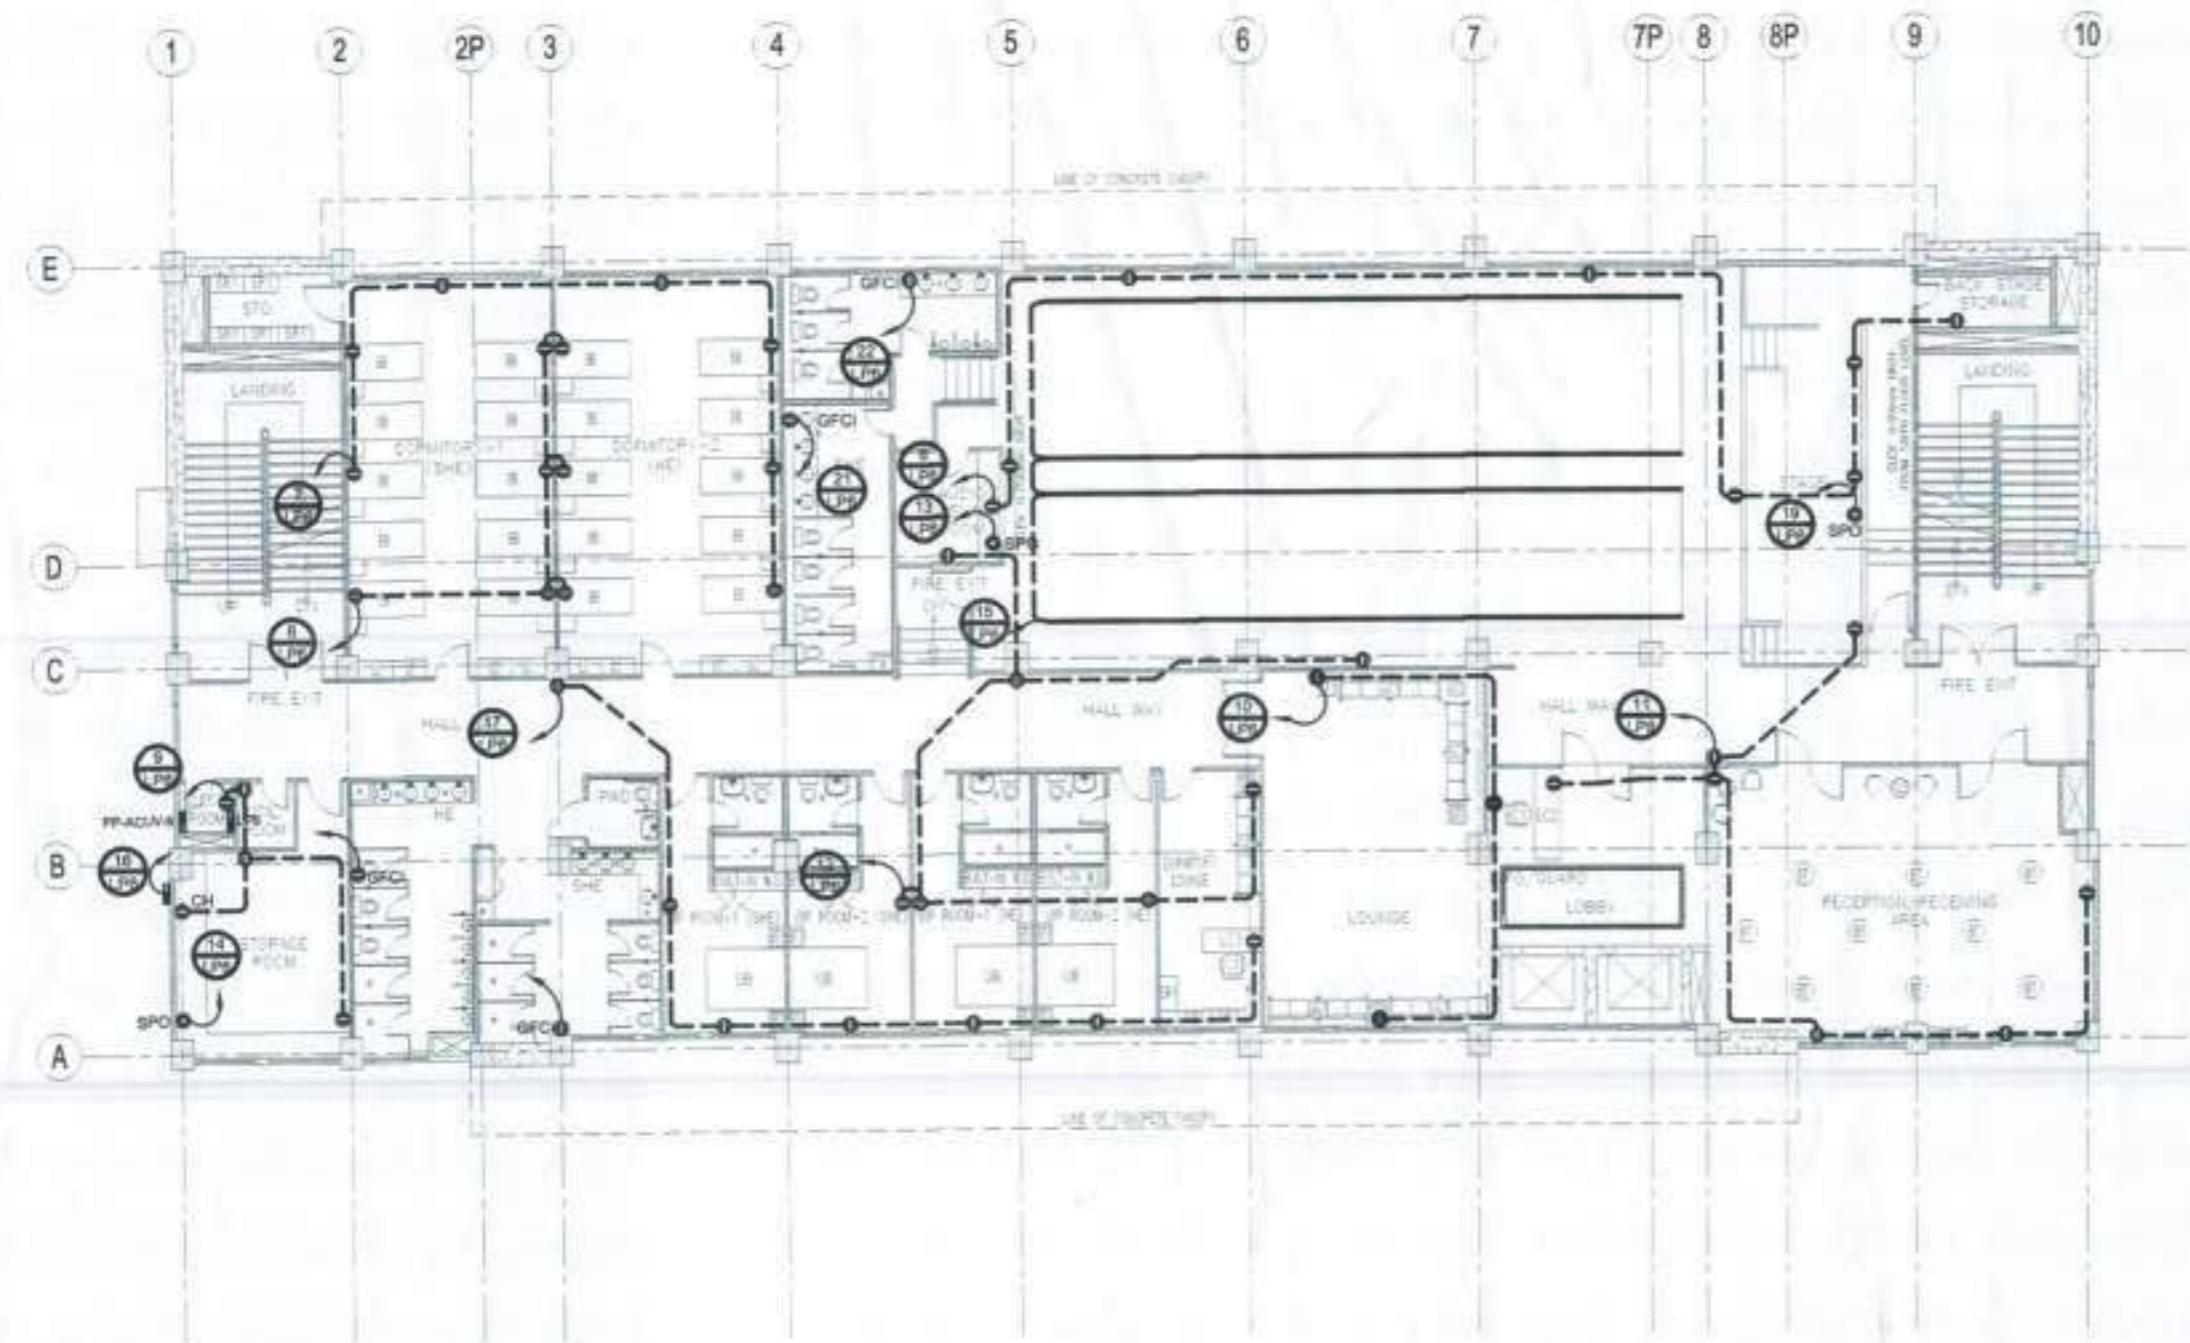

REVISED SIXTH FLOOR POWER LAYOUT PLAN


SCALE:

1:100 M.

NOTE:
PURSUANT TO SECTION 4 OF ANNEX "D" OF THE
REVISED IMPLEMENTING RULES AND REGULATIONS OF RA. 9163,
APPROVAL BY THE AUTHORIZED OFICIALS OF DEDICATED
DESIGNING SERVICES AND DESIGN INTEGRATION BY CONSULTANTS
HEREIN DIMINISHES THE RESPONSIBILITY OF THE LATTER
FOR THE RESPONSIBILITY TO APPROVING OFFICIALS.

THE DESIGN CONSULTANT SHALL BE HELD FULLY RESPONSIBLE
FOR THE FAILURE OF THE FACILITY DUE TO FAULTY
DESIGN EXCEPT FOR THE CHANGES MADE WITHOUT THE
OF THE DESIGNER.

ORVILLE R. SINGSON
ELECTRICAL DESIGN
POSITION: ELECTRICAL ENGINEER
PRC No.: 020401TPRS TN No.: 105-426-102
PTB No.: T222061 21-03-18, MARINA CITY

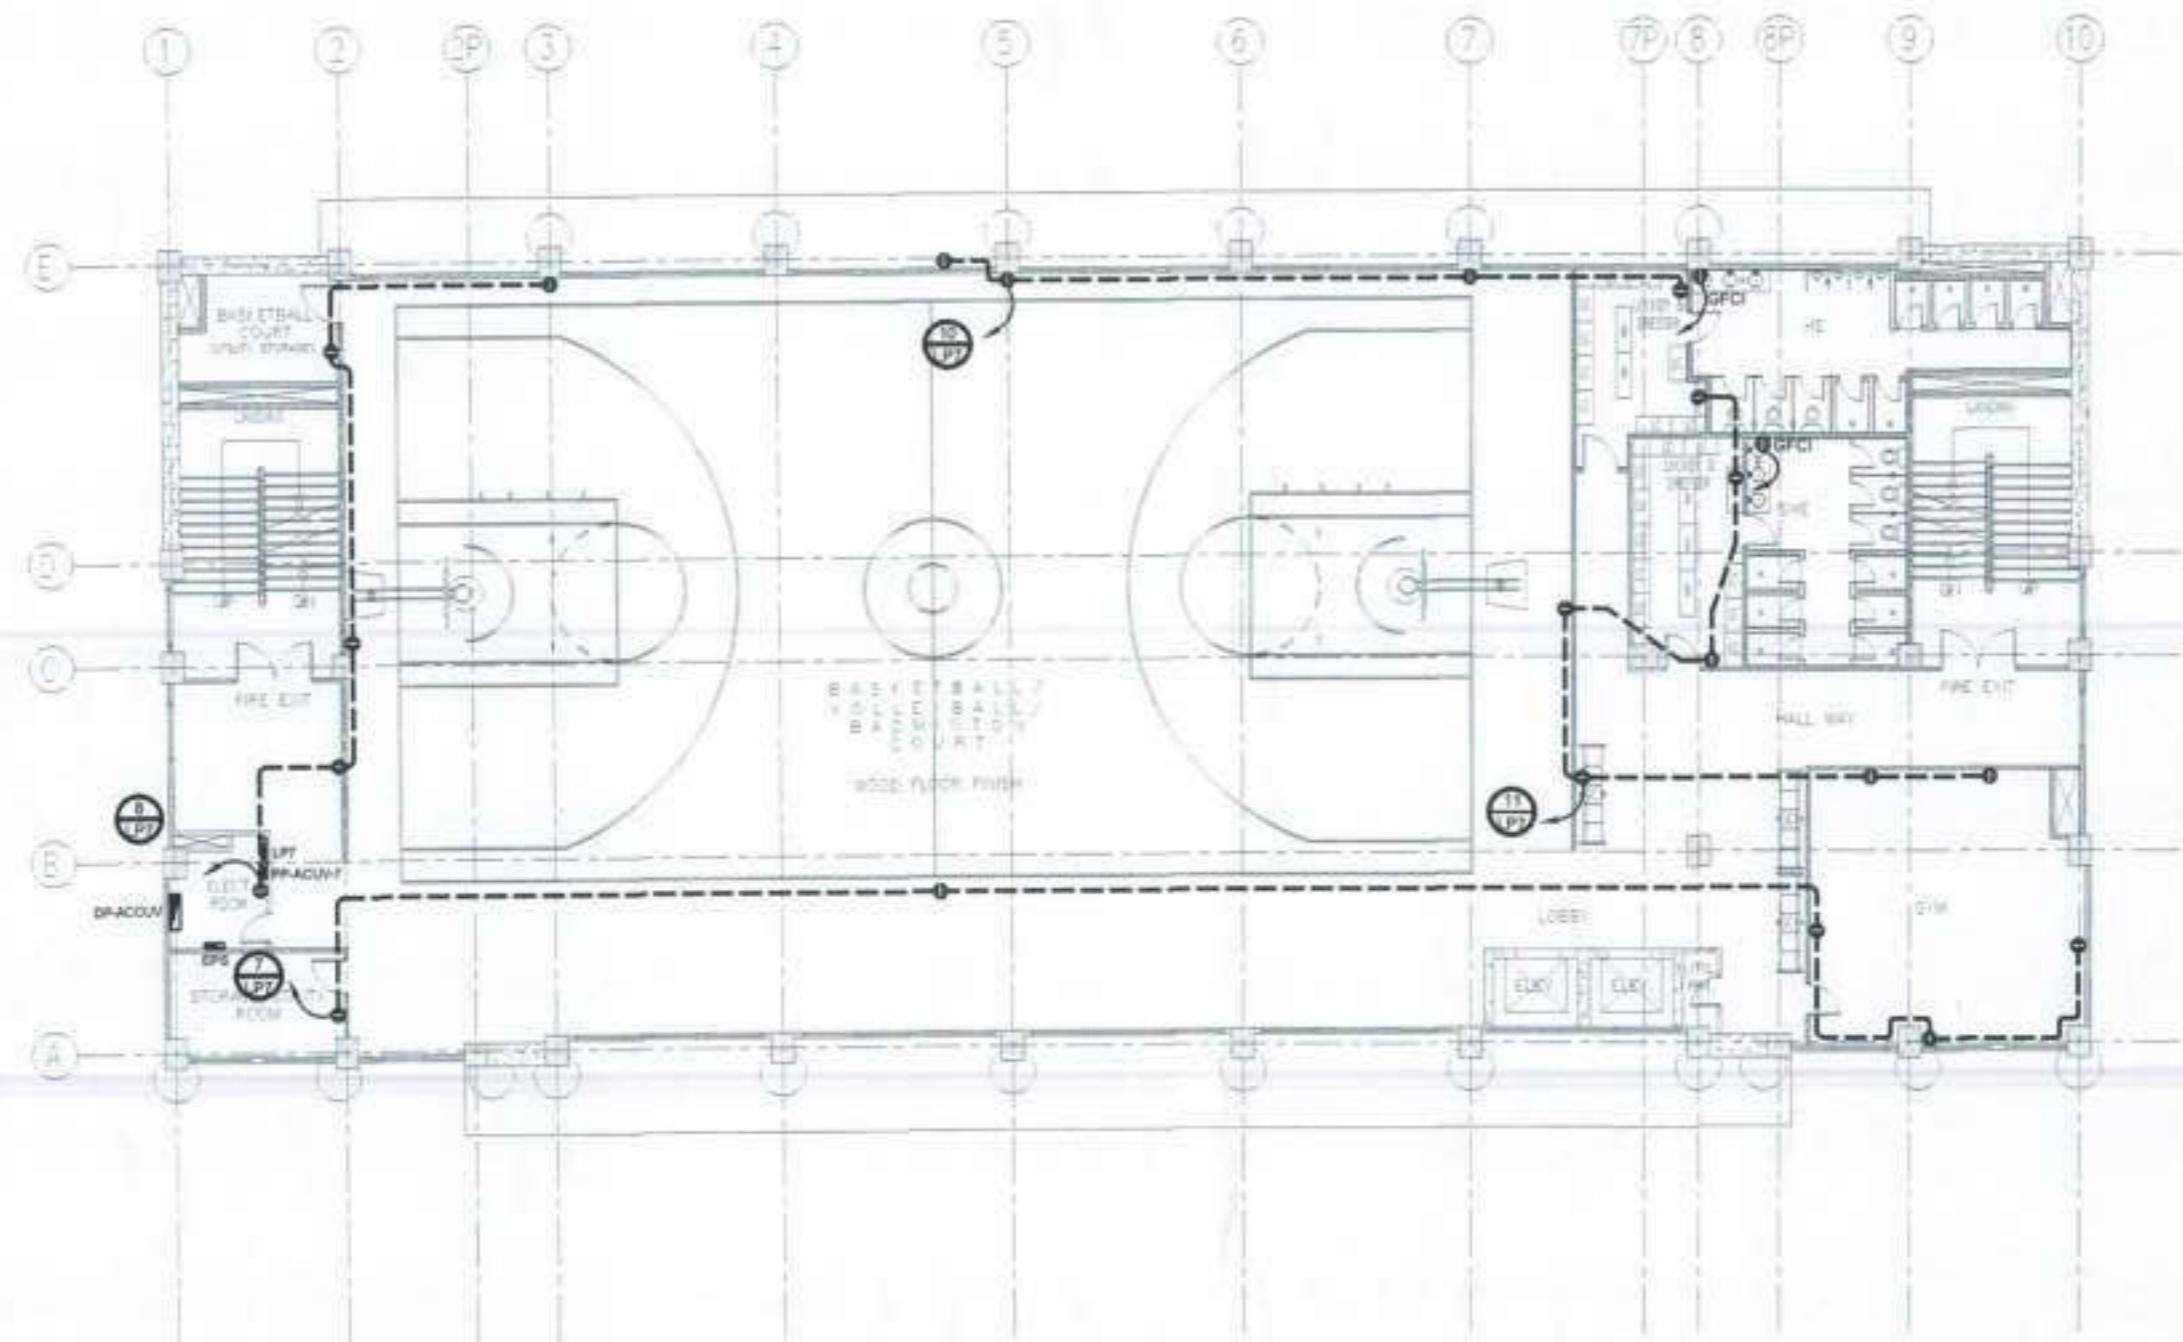

REVISED SEVENTH FLOOR POWER LAYOUT PLAN

SCALE:

1:100 M.

NOTE:
PURSUANT TO SECTION 4 OF ANNEX "D" OF THE
POWER IMPLEMENTING RULES AND REGULATIONS OF RA. 9196,
APPROVAL BY THE AUTHORIZED SPAN OFFICIALS OF DETAILED
ENGINEERING SURVEYS AND DESIGN INTEGRITY BY CONTRACTORS
MAY NOT DIMINISH THE RESPONSIBILITY OF THE LATTER
FOR THE RESPONSIBILITY TO APPROVE OFFICIALS.


THE DESIGN CONSULTANT SHALL BE HELD FULLY RESPONSIBLE
FOR THE FAILURE OF THE FACILITY TO MEET
DESIGN EXCEPT FOR THE CHANGES MADE DURING THE
PROCESS.

ORVILLE R. SINGSON

ELECTRICAL DESIGN
POSITION: ELECTRICAL ENGINEER
PRNC No.: 0004611PTPR TIN No.: 100-028-102
PTB No.: 7222982, DI-43-14, MARINA CITY

NOTE:

ALL MCCB'S WITH 225A AND UP SHALL BE OF INTERCHANGEABLE THERMAL MAGNETIC TRIP UNIT TYPE.

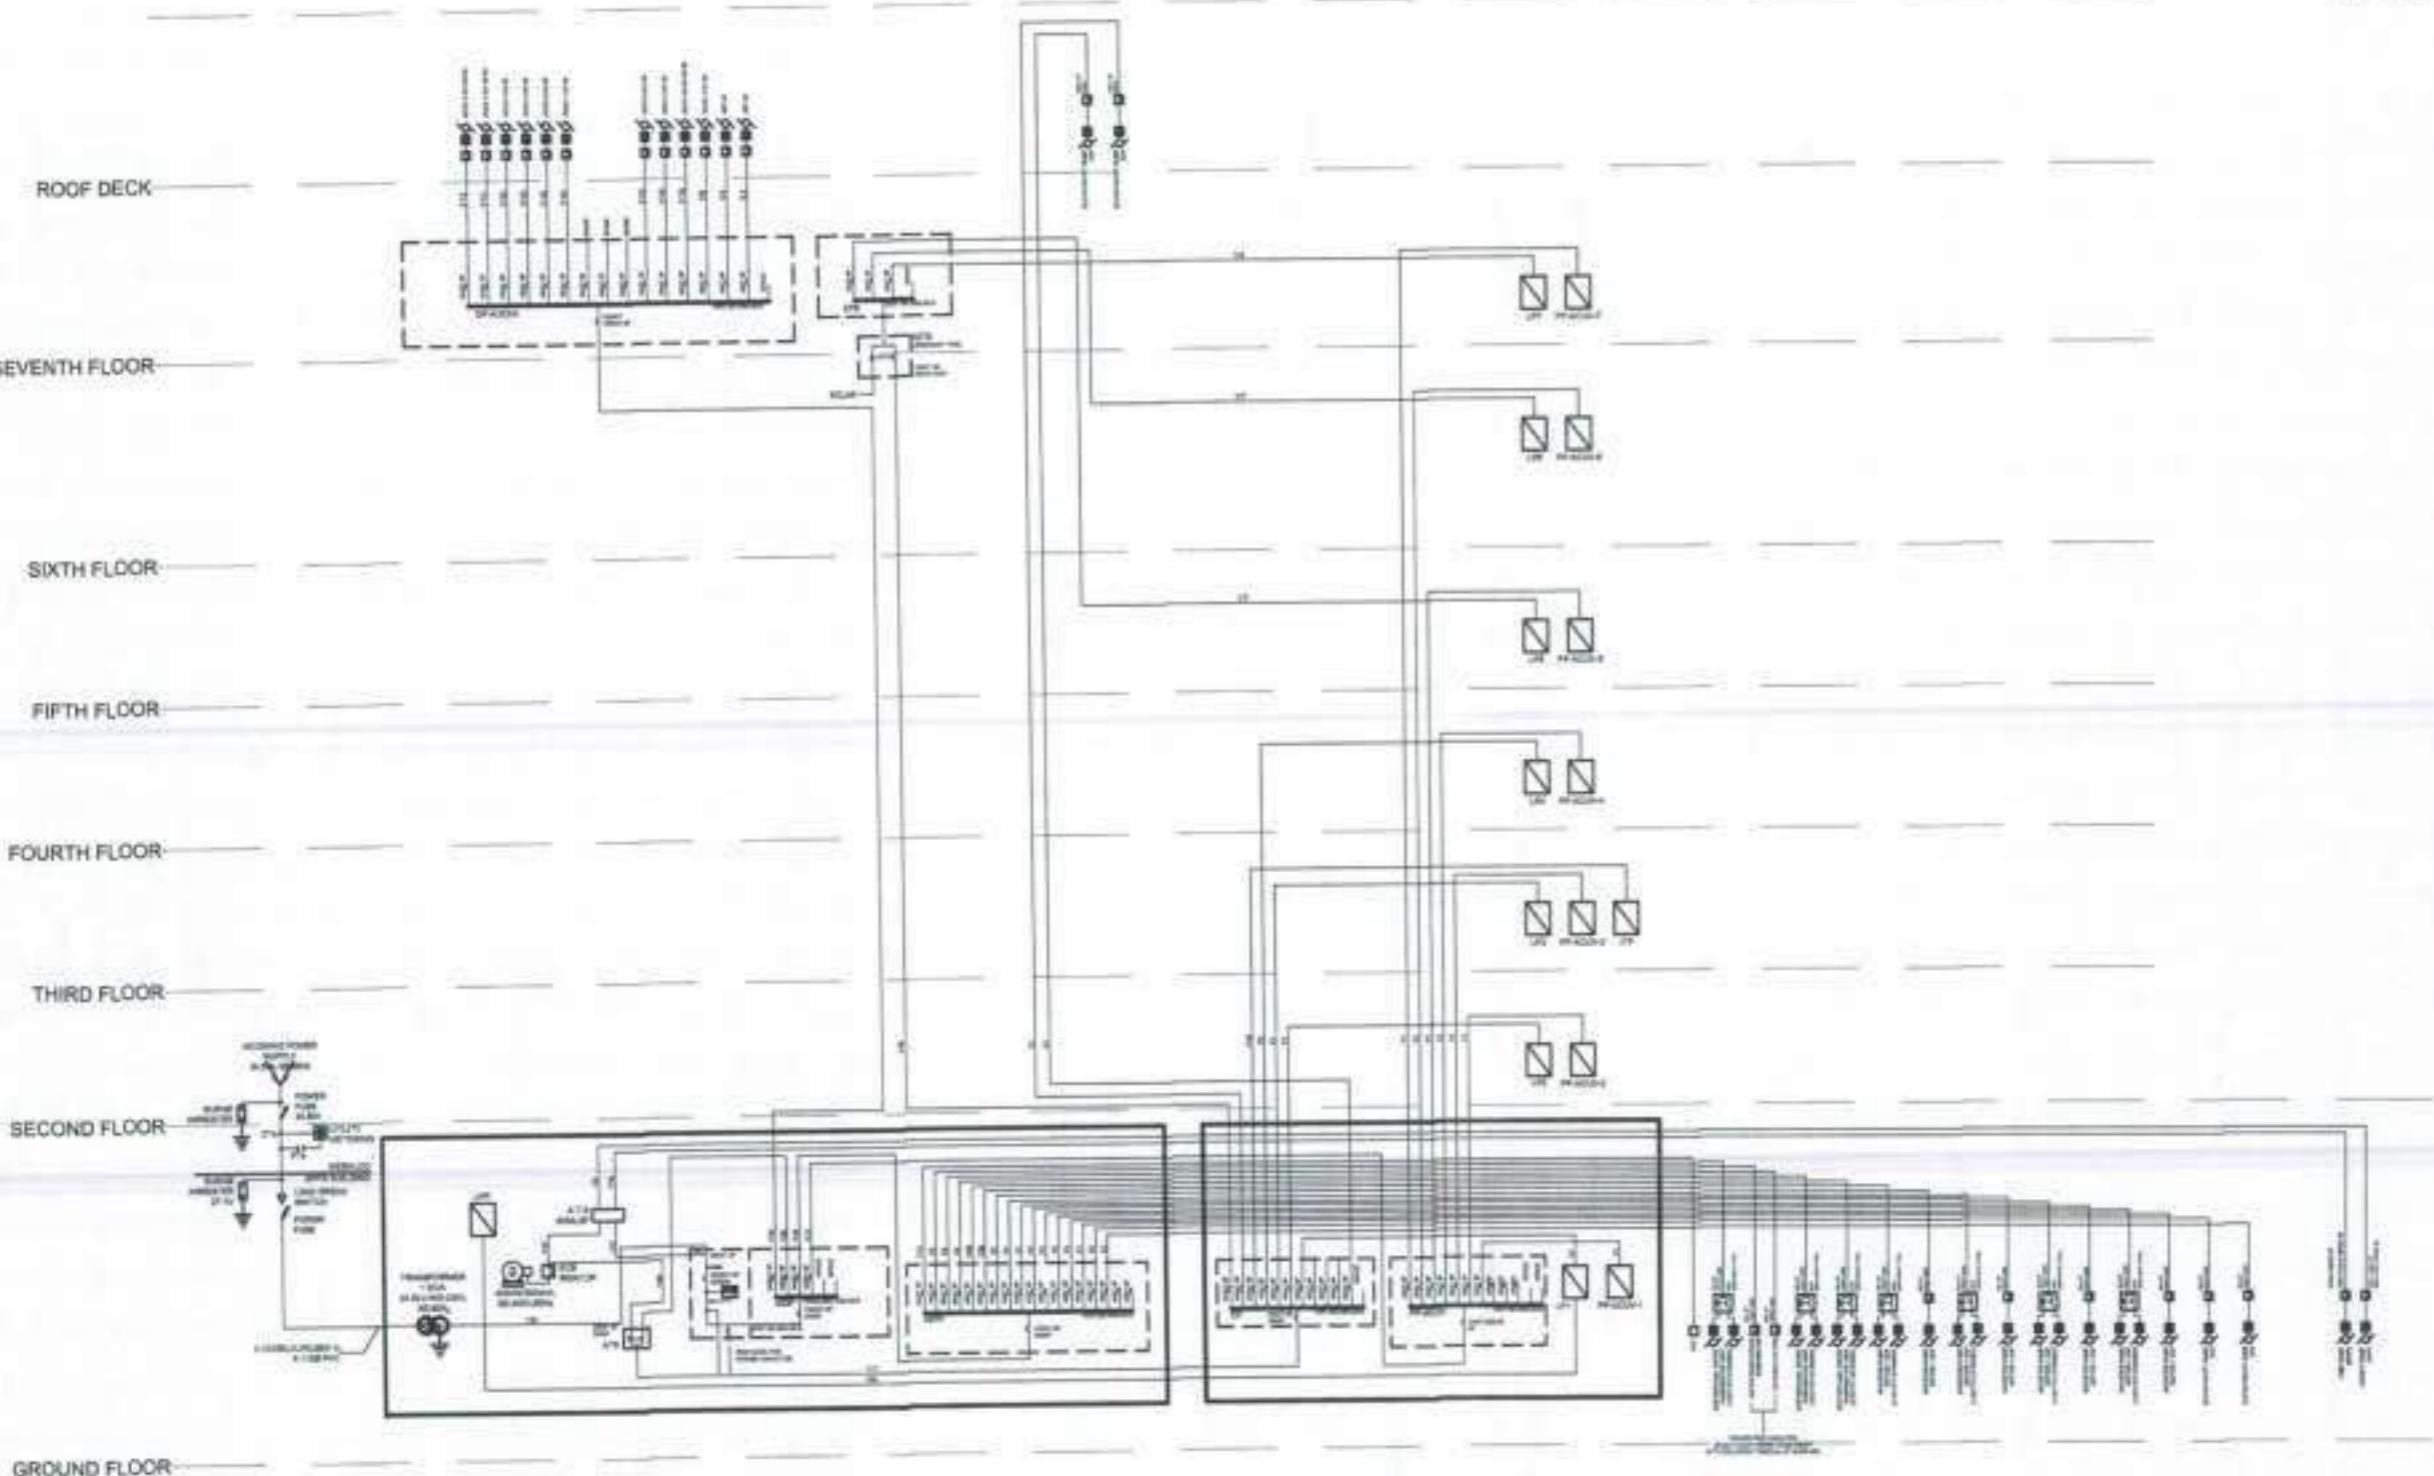

SYMBOL	SIZES OF WIRES & CONDUIT
Y1	8.0mm ² THHN, 1.0mm ² TW in 20mm PVC
Y2	8.0mm ² THHN, 1.0mm ² TW in 20mm PVC
Y3	24.0mm ² THHN, 1.0mm ² TW in 20mm PVC
Y4	24.0mm ² THHN, 1.0mm ² TW in 20mm PVC
Y5	24.0mm ² THHN, 1.0mm ² TW in 20mm PVC
Y6	4.0mm ² THHN, 1.0mm ² TW in 20mm PVC
Y7	8.0mm ² TW, 1.0mm ² TW in 20mm PVC
Y8	8.0mm ² TW, 1.0mm ² TW in 20mm PVC
Y9	8.0mm ² TW, 1.0mm ² TW in 20mm PVC
Y10	8.0mm ² TW, 1.0mm ² TW in 20mm PVC
Y11	8.0mm ² TW, 1.0mm ² TW in 20mm PVC
Y12	8.0mm ² TW, 1.0mm ² TW in 20mm PVC
Y13	8.0mm ² TW, 1.0mm ² TW in 20mm PVC
Y14	8.0mm ² TW, 1.0mm ² TW in 20mm PVC
Y15	8.0mm ² TW, 1.0mm ² TW in 20mm PVC
Y16	8.0mm ² TW, 1.0mm ² TW in 20mm PVC
Y17	8.0mm ² TW, 1.0mm ² TW in 20mm PVC
Y18	8.0mm ² TW, 1.0mm ² TW in 20mm PVC
Y19	8.0mm ² TW, 1.0mm ² TW in 20mm PVC
Y20	8.0mm ² TW, 1.0mm ² TW in 20mm PVC
Y21	8.0mm ² TW, 1.0mm ² TW in 20mm PVC

NOTE: PURSUANT TO SECTION 4 OF ANNEX "K" OF THE REVISED IMPLEMENTING RULES AND REGULATIONS OF RA. 9163, APPROVAL BY THE AUTHORIZED OFFICIALS OF DETAINED ENGINEERING BUREAU AND DESIGN INSTITUTION BY CONSULTANTS NEITHER DIMINISHES THE RESPONSIBILITY OF THE LATTER FOR THE RESPONSIBILITY TO APPROVE OFFICIALS.

THE DESIGN CONSULTING SHALL BE HELD FULLY RESPONSIBLE FOR THE FAILURE OF THE FACILITY DUE TO FAULTY DESIGN EXCEPT FOR THE CHANGES MADE WITHOUT THE OF THE DESIGNER.

ORVILLE R. SINGSON

ELECTRICAL DESIGNER
POSITION: ELECTRICAL ENGINEER
PTN NO.: 0200011PTN TRN NO.: 151-436-103
PTN NO.: 72202001 07-09-11, MARIKINA CITY

SINGLE LINE DIAGRAM
SCALE: NTS

SCHEDULE OF LOAD

PANEL UPS SURFACE MOUNTED, NEMA 1 ENCLOSURE WITH NEUTRAL AND GROUND TERMINAL

CAT NO.	LOAD DESCRIPTION	VA VOLTS	A	B	C	BRANCH CTR. BREAKER	SIZE OF WIRE AND CONDUIT	VA PER PHASE				
								AT AF POLE/AC	2.5mm ² THIN WIRE STRANDED + 2.5mm ² TW (S) WIRE STRANDED, 20mm ² DA PVC	2.5mm ² THIN WIRE STRANDED + 2.5mm ² TW (S) WIRE STRANDED, 20mm ² DA PVC	2.5mm ² THIN WIRE STRANDED + 2.5mm ² TW (S) WIRE STRANDED, 20mm ² DA PVC	
1 LIGHTING	1840 400/120	1440				12 50 IP 10						
2 LIGHTING	1811 400/120	2852				12 50 IP 10						
3 LIGHTING	1841 400/120	1244				12 50 IP 10						
4 LIGHTING	1129 400/120	1128				12 50 IP 10						
5 CONVENIENCE OUTLET (INTERNAL)	1625 400/120					12 50 30 50 SP 10						
6 CONVENIENCE OUTLET (INTERNAL)	2425 400/120					12 50 30 50 SP 10						
7 CONVENIENCE OUTLET (INTERNAL)	2805 400/120	1800				20 50 IP 10						
8 CONVENIENCE OUTLET (INTERNAL)	170 400/120	720				20 50 IP 10						
9 CONVENIENCE OUTLET (INTERNAL)	1440 400/120	3480				20 50 IP 10						
10 LIGHTING	1880 400/120	580				12 50 IP 10						
11 CONVENIENCE OUTLET (INTERNAL)	1880 400/120	1880				12 50 30 50 SP 10						
12 CONVENIENCE OUTLET (INTERNAL)	1340 400/120	1340				12 50 30 50 SP 10						
13 CONVENIENCE OUTLET (INTERNAL)	1380 400/120	1380				12 50 30 50 SP 10						
14 CONVENIENCE OUTLET (INTERNAL)	1380 400/120	1380				12 50 30 50 SP 10						
15 NDF	700 400/120	700				12 50 IP 10						
16 CONVENIENCE OUTLET (INTERNAL)	700 400/120	700				12 50 IP 10						
17 SPECIAL PURPOSE OUTLET	1300 400/120	1300				12 50 30 50 SP 10						
18 SPECIAL PURPOSE OUTLET	1300 400/120	1300				12 50 30 50 SP 10						
19 SPECIAL PURPOSE OUTLET	1300 400/120	1300				12 50 30 50 SP 10						
20 SPECIAL PURPOSE OUTLET	1300 400/120	1300				12 50 30 50 SP 10						
21 CONVENIENCE OUTLET (INTERNAL)	1300 400/120	1300				12 50 30 50 SP 10						
22 SPECIAL PURPOSE OUTLET	1300 400/120	1300				12 50 30 50 SP 10						
23 CONVENIENCE OUTLET (INTERNAL)	1300 400/120	1300				12 50 30 50 SP 10						
24 CONVENIENCE OUTLET (INTERNAL)	1300 400/120	1300				12 50 30 50 SP 10						
25 CONVENIENCE OUTLET (INTERNAL)	1300 400/120	1300				12 50 30 50 SP 10						
26 CONVENIENCE OUTLET (INTERNAL)	1300 400/120	1300				12 50 30 50 SP 10						
27 CONVENIENCE OUTLET (INTERNAL)	1300 400/120	1300				12 50 30 50 SP 10						
28 CONVENIENCE OUTLET (INTERNAL)	1300 400/120	1300				12 50 30 50 SP 10						
29 CONVENIENCE OUTLET (INTERNAL)	1300 400/120	1300				12 50 30 50 SP 10						
30 CONVENIENCE OUTLET (INTERNAL)	1300 400/120	1300				12 50 30 50 SP 10						
TOTAL		4804				12 50 30 50 10 100 IP 10						

SCHEDULE OF LOAD

PANEL UPS SURFACE MOUNTED, NEMA 1 ENCLOSURE WITH NEUTRAL AND GROUND TERMINAL

CAT NO.	LOAD DESCRIPTION	VA VOLTS	A	B	C	BRANCH CTR. BREAKER	SIZE OF WIRE AND CONDUIT	VA PER PHASE				
								AT AF POLE/AC	2.5mm ² THIN WIRE STRANDED + 2.5mm ² TW (S) WIRE STRANDED, 20mm ² DA PVC	2.5mm ² THIN WIRE STRANDED + 2.5mm ² TW (S) WIRE STRANDED, 20mm ² DA PVC	2.5mm ² THIN WIRE STRANDED + 2.5mm ² TW (S) WIRE STRANDED, 20mm ² DA PVC	
1 LIGHTING	1840 400/120	1440				12 50 IP 10						
2 LIGHTING	1811 400/120	2852				12 50 IP 10						
3 LIGHTING	1841 400/120	1244				12 50 IP 10						
4 LIGHTING	1129 400/120	1128				12 50 IP 10						
5 CONVENIENCE OUTLET (INTERNAL)	1625 400/120					12 50 30 50 SP 10						
6 CONVENIENCE OUTLET (INTERNAL)	2425 400/120					12 50 30 50 SP 10						
7 CONVENIENCE OUTLET (INTERNAL)	2805 400/120	1800				20 50 IP 10						
8 CONVENIENCE OUTLET (INTERNAL)	170 400/120	720				20 50 IP 10						
9 CONVENIENCE OUTLET (INTERNAL)	1440 400/120	3480				20 50 IP 10						
10 LIGHTING	1880 400/120	580				12 50 IP 10						
11 CONVENIENCE OUTLET (INTERNAL)	1880 400/120	1880				12 50 30 50 SP 10						
12 CONVENIENCE OUTLET (INTERNAL)	1340 400/120	1340				12 50 30 50 SP 10						
13 CONVENIENCE OUTLET (INTERNAL)	1380 400/120	1380				12 50 30 50 SP 10						
14 CONVENIENCE OUTLET (INTERNAL)	1380 400/120	1380				12 50 30 50 SP 10						
15 NDF	700 400/120	700				12 50 IP 10						
16 CONVENIENCE OUTLET (INTERNAL)	700 400/120	700				12 50 IP 10						
17 SPECIAL PURPOSE OUTLET	1300 400/120	1300				12 50 30 50 SP 10						
18 SPECIAL PURPOSE OUTLET	1300 400/120	1300				12 50 30 50 SP 10						
19 SPECIAL PURPOSE OUTLET	1300 400/120	1300				12 50 30 50 SP 10						
20 SPECIAL PURPOSE OUTLET	1300 400/120	1300				12 50 30 50 SP 10						
21 CONVENIENCE OUTLET (INTERNAL)	1300 400/120	1300				12 50 30 50 SP 10						
22 SPECIAL PURPOSE OUTLET	1300 400/120	1300				12 50 30 50 SP 10						
23 CONVENIENCE OUTLET (INTERNAL)	1300 400/120	1300				12 50 30 50 SP 10						
24 CONVENIENCE OUTLET (INTERNAL)	1300 400/120	1300				12 50 30 50 SP 10						
25 CONVENIENCE OUTLET (INTERNAL)	1300 400/120	1300				12 50 30 50 SP 10						
26 CONVENIENCE OUTLET (INTERNAL)	1300 400/120	1300				12 50 30 50 SP 10						
27 CONVENIENCE OUTLET (INTERNAL)	1300 400/120	1300				12 50 30 50 SP 10						
28 CONVENIENCE OUTLET (INTERNAL)	1300 400/120	1300				12 50 30 50 SP 10						
29 CONVENIENCE OUTLET (INTERNAL)	1300											

GENERAL NOTES

1. ALL INSTALLATION SHALL BE IN ACCORDANCE TO THE LATEST EDITION OF PHILIPPINE ELECTRICAL CODE AND REVISED FIRE CODE OF THE PHILIPPINES.
2. TELEPHONE INSTALLATIONS HEREIN SHALL BE DONE IN ACCORDANCE WITH THE LATEST EDITION OF THE BUILDING TELEPHONE FACILITIES STANDARD MANUAL AND RULES AND REGULATIONS OF LOCAL TELEPHONE COMPANY AND THE CITY HAVING JURISDICTION.
3. ELECTRONICS AND COMMUNICATION WORKS SHALL BE UNDER THE IMMEDIATE SUPERVISION OF A DULY LICENSED REGISTERED ELECTRONICS AND COMMUNICATION ENGINEER.
4. WIRING SYSTEM INSTALLATION SHALL BE DONE IN POLYVINYL CHLORIDE (uPVC) CONDUIT, SCHEDULE 40. MINIMUM SIZE FOR uPVC SHALL BE 20mm DIAMETER ELECTRICAL TRADE SIZE. WHERE IN CONDUIT MAY BE SUBJECT MECHANICAL DAMAGE, ELECTRICAL METAL TUBING (EMT) COMPRESSION TYPE SHALL BE USED,
5. THE CONTRACTOR SHALL VERIFY AND ORIENT ACTUAL LOCATION OF SERVICE ENTRANCE CONNECTION TO THE AUXILIARY SYSTEM ENTRANCE FOR CONNECTION TO LOCAL UTILITY COMPANIES.
6. ALL PIPE SLEEVES SHALL BE PROVIDED WITH PROPER SUPPORT OR ANCHORAGE NECESSARY FOR PERMANENT CONNECTION WITH CONCRETE WALLING OR BEAM.
7. CONTRACTOR SHALL BE RESPONSIBLE TO CONSULT, COORDINATE, SECURE AND PAY ALL FEES NECESSARY FOR THE TELEPHONE CONNECTION OF THIS PROJECT.
8. ANY DISCREPANCY IN LOCATION AND RATINGS OF EQUIPMENT AND APPARATUS SHALL BE VERIFIED WITH THE OWNER/ENGINEER OR ANY OF HIS REPRESENTATIVES SO CHANGES SHALL BE MADE ACCORDINGLY.
9. ALL MATERIALS TO BE USED AND EQUIPMENT TO BE INSTALLED SHALL BE BRAND NEW AND MUST BE OF THE APPROVED TYPE FOR THE PARTICULAR LOCATION AND PURPOSE INTENDED UNLESS OTHERWISE INDICATED.
10. THE MOUNTING HEIGHTS OF WIRING DEVICES SHALL BE AS FOLLOWS:

TELEPHONE & DATA OUTLETS.....	0.3m ABOVE FLOOR FINISH OR AS REQUIRED
PANELS & CABINETS.....	1.4m ABOVE FLOOR FINISH AT CENTER OR AS REQUIRED

ALL WIRING DEVICES PLATE COVER SHALL BE SUBJECT TO THE ARCHITECT'S APPROVAL PRIOR TO INSTALLATION.

11. PANELS AND CABINETS SHALL BE OF STANDARD GA 16, WITH CONTINUOUS HINGE AND PUSH-LOCK TYPE LOCK.
12. PROVIDE PULL WIRES GA.14(MIN) IN ALL EMPTY CONDUITS.
13. JUNCTION, PULLBOXES AND METAL ENCLOSURES SHALL BE GAUGE 16 FOR INDOOR AND GAUGE 14 STEEL SHEET WEATHERPROOF (NEMA 3R) TYPE FOR EXTERIOR INSTALLATION UNLESS OTHERWISE INDICATED TO BE STAINLESS STEEL NEMA 4X TYPE.
14. CONTRACTOR SHALL BE RESPONSIBLE TO CONSULT AND COORDINATE AND MAKE NECESSARY CORRECTION FOR THE DESIGN APPROVAL FROM THE BUILDING INDUSTRY CONSULTING SERVICE (BICS) PRIOR TO INSTALLATION.
15. DETAILS ARE FOR REFERENCE ONLY. CONTRACTOR TO PROVIDE SHOP DRAWING FOR APPROVAL

LEGEND

LEGENDS	DESCRIPTION
	UNIVERSAL INFORMATION OUTLET, DUAL PORT (VOICE & DATA) FLOOR MOUNTED
	UNIVERSAL INFORMATION OUTLET SINGLE PORT FLOOR MOUNTED (VOICE)
	UNIVERSAL INFORMATION OUTLET SINGLE PORT FLOOR MOUNTED (DATA)
	WIRELESS ACCESS POINT (WAP) CEILING MOUNTED
	UNIVERSAL INFORMATION OUTLET, DUAL PORT (VOICE & DATA) WALL MOUNTED
	UNIVERSAL INFORMATION OUTLET, SINGLE PORT (VOICE) WALL MOUNTED
	UNIVERSAL INFORMATION OUTLET, SINGLE PORT (DATA) WALL MOUNTED
	INTERMEDIATE DISTRIBUTION FRAME
	MAIN DISTRIBUTION FRAME

DRAWING INDEX

SHEET NO.	SHEET CONTENT
EC-01	LEGEND, GENERAL NOTES & DRAWING INDEX
EC-02	REVISED NETWORK CABLING RISER DIAGRAM
EC-03	REVISED GROUND FLOOR NETWORK CABLING LAYOUT
EC-04	REVISED SECOND FLOOR NETWORK CABLING LAYOUT
EC-05	REVISED THIRD FLOOR NETWORK CABLING LAYOUT
EC-06	REVISED FOURTH FLOOR NETWORK CABLING LAYOUT
EC-07	REVISED FIFTH FLOOR NETWORK CABLING LAYOUT
EC-08	REVISED SIXTH FLOOR NETWORK CABLING LAYOUT
EC-09	MISCELLANEOUS DETAILS

1
ECE-1 NTS

LEGENDS, GENERAL NOTES AND DRAWING INDEX


NOTE:
PURSUANT TO SECTION 4 OF ANNEX "A" OF THE REVISED IMPLEMENTING RULES AND REGULATION OF R.A. 9184, APPROVAL BY THE AUTHORIZED DPWH OFFICIALS OF DETAILED ENGINEERING SURVEYS AND DESIGN UNDERTAKEN BY CONSULTANTS NEITHER DIMINISHES THE RESPONSIBILITY OF THE LATTER FOR THE TECHNICAL INTEGRITY OF THE SURVEYS AND DESIGN NOR TRANSFER ANY PART OF THAT RESPONSIBILITY TO THE APPROVING OFFICIALS.

THE DESIGN CONSULTANT SHALL BE HELD FULLY RESPONSIBLE FOR THE FAILURE OF THE FACILITY/IES/STRUCTURES DUE TO FAULTY DESIGN EXCEPT FOR THE CHANGES MADE WITHOUT THE CONFORMITY OF THE CONSULTANTS.

ORVILLE R. SINGSON

ELECTRICAL DESIGN
POSITION: ELECTRICAL ENGINEER
PRC No.: 0004017PTR TIN No.: 155-838-103
PTR No.: 7222893, 01-03-18, MARIKINA CITY

REVIEWED & SUBMITTED BY:	PREPARED:	PROJECT NAME AND LOCATION:	SHEET CONTENTS:	REPUBLIC OF THE PHILIPPINES DEPARTMENT OF PUBLIC WORKS AND HIGHWAYS Unified Project Management Office Buildings and Special Projects Management Office 2nd Street DPWH-NCR Compound Port Area Manila	CHECKED:	SUBMITTED:	REVIEWED:	RECOMMENDED:	APPROVED:	SET NO.	SHEET NO.
WISMON CONSTRUCTION & DEVELOPMENT CORPORATION ARNULFO C. HERMOGENO PRC No.: 0009196 PTR No.: 7222893 PLACE ISSUED: MAKATI CITY TIN No.: 7125665 DATE: 10-09-18	DELWYN C. BALCOS PROJECT MANAGER DLCCC/WCDC DATE:	PROPOSED SEVEN (7)-STOREY GOVERNMENT PROCUREMENT POLICY BOARD TECHNICAL SUPPORT OFFICE (GPPB-TSO) BUILDING UP DILIMAN COMPOUND, DILIMAN, QUEZON CITY	LEGENDS, GENERAL NOTES AND DRAWING INDEX		VICTOR H. BADILLO PROJECT ENGINEER BSPMC-UPMO DATE:	ANGELINA B. MELCHOR PROJECT MANAGER III BSPMC-UPMO DATE:	ERIBERTO B. SIOSON CHIEF, BUILDINGS DIVISION BUREAU OF DESIGN DATE:	SOLEDAD R. FLORENCIO PROJECT DIRECTOR BSPMC-UPMO DATE:	EDWIN C. MATANGUIHAN OIC - DIRECTOR BUREAU OF DESIGN DATE:	MAXIMO L. CARVAJAL UNDERSECRETARY FOR TECHNICAL SERVICES DATE:	 ECE 1 8 1 8

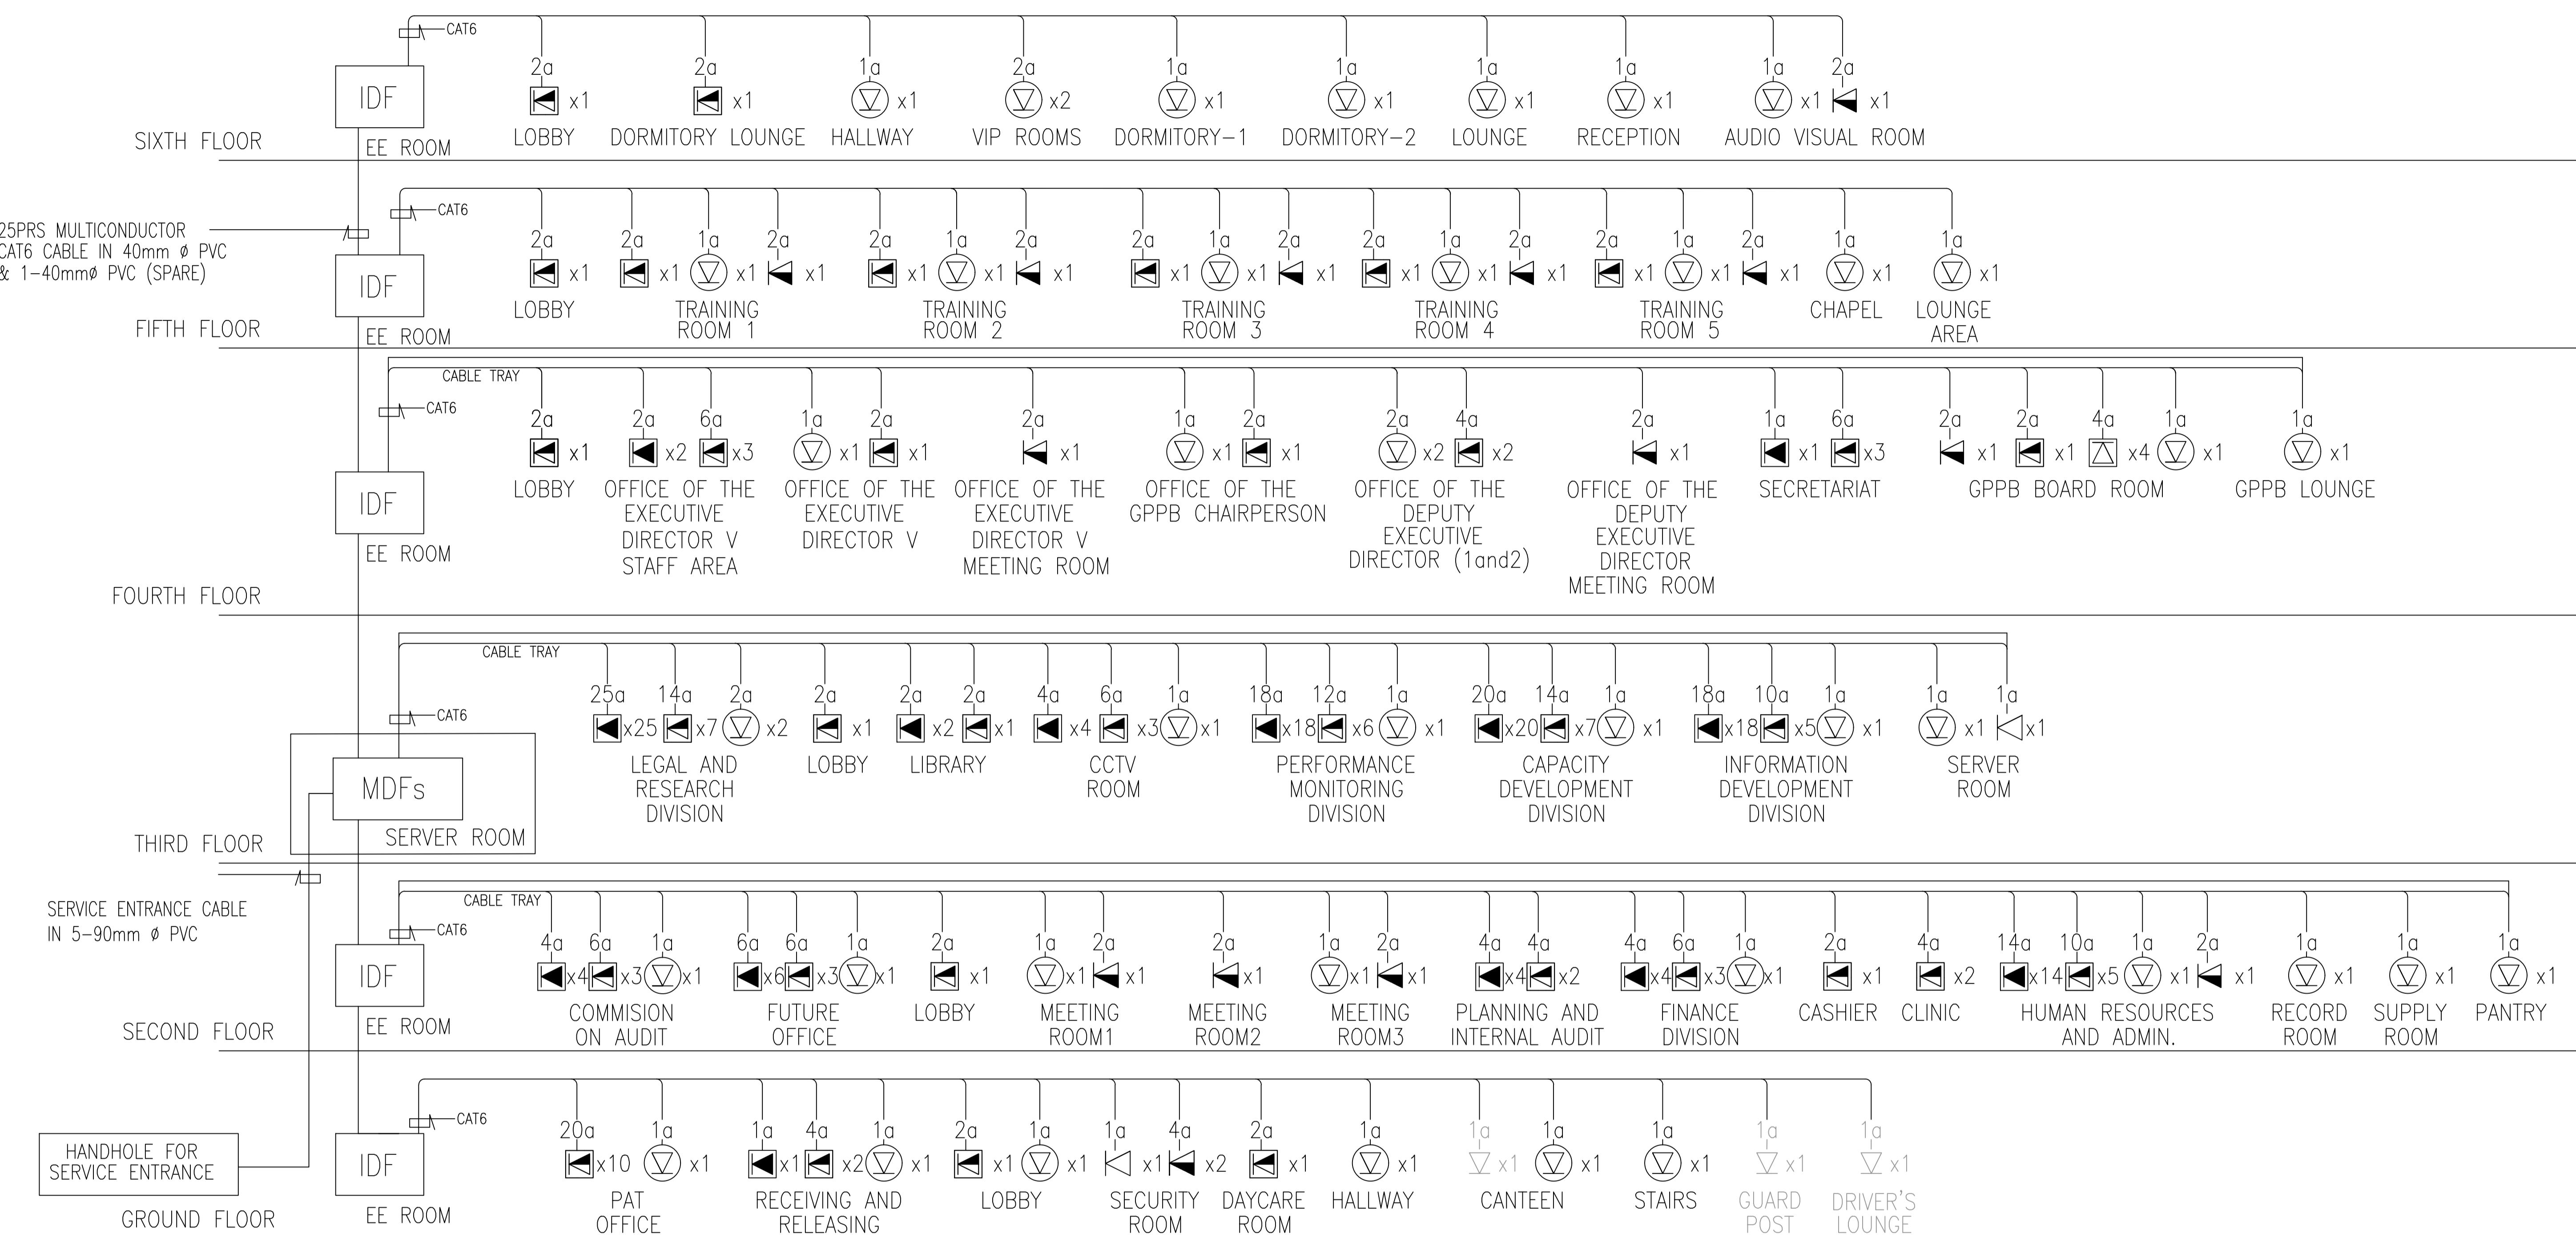

LEGENDS		DESCRIPTION	
<input checked="" type="checkbox"/>	UNIVERSAL INFORMATION OUTLET, DUAL PORT (VOICE & DATA) FLOOR MOUNTED		
<input checked="" type="checkbox"/>	UNIVERSAL INFORMATION OUTLET SINGLE PORT FLOOR MOUNTED (VOICE)		
<input checked="" type="checkbox"/>	UNIVERSAL INFORMATION OUTLET SINGLE PORT FLOOR MOUNTED (DATA)		
<input checked="" type="checkbox"/>	WIRELESS ACCESS POINT (WAP) CEILING MOUNTED		
<input checked="" type="checkbox"/>	UNIVERSAL INFORMATION OUTLET, DUAL PORT (VOICE & DATA) WALL MOUNTED		
<input checked="" type="checkbox"/>	UNIVERSAL INFORMATION OUTLET, SINGLE PORT (VOICE) WALL MOUNTED		
<input checked="" type="checkbox"/>	UNIVERSAL INFORMATION OUTLET, SINGLE PORT (DATA) WALL MOUNTED		
<input checked="" type="checkbox"/>	INTERMEDIATE DISTRIBUTION FRAME		
<input checked="" type="checkbox"/>	MAIN DISTRIBUTION FRAME		

CONDUIT SIZE	25mmØC	32mmØC	40mmØC
#24 AWG CAT 6	2-4	5-6	7-10

REVISED NETWORKCABLING RISER DIAGRAM


1
ECE-2
NTS

NOTE	DESCRIPTION
<input checked="" type="checkbox"/>	HIGHLIGHTED OUTLETS ARE UNDER REVISE PLANS
<input type="checkbox"/>	NOT HIGHLIGHTED OUTLETS ARE UNDER ORIGINAL PLANS

NOTE:
PURSUANT TO SECTION 4 OF ANNEX "A" OF THE REVISED IMPLEMENTING RULES AND REGULATION OF R.A. 9184, APPROVAL BY THE AUTHORIZED DPWH OFFICIALS OF DETAILED ENGINEERING SURVEYS AND DESIGN UNDERTAKEN BY CONSULTANTS NEITHER DIMINISHES THE RESPONSIBILITY OF THE LATTER FOR THE TECHNICAL INTEGRITY OF THE SURVEYS AND DESIGN NOR TRANSFER ANY PART OF THAT RESPONSIBILITY TO THE APPROVING OFFICIALS.

THE DESIGN CONSULTANT SHALL BE HELD FULLY RESPONSIBLE FOR THE FAILURE OF THE FACILITY/IES/STRUCTURES DUE TO FAULTY DESIGN EXCEPT FOR THE CHANGES MADE WITHOUT THE CONFORMITY OF THE CONSULTANTS.

ORVILLE R. SINGSON
ELECTRICAL DESIGN
POSITION: ELECTRICAL ENGINEER
PRC No.: 0004017PTR TIN No.: 155-838-103
PTR No.: 7222893, 01-03-18, MARIKINA CITY

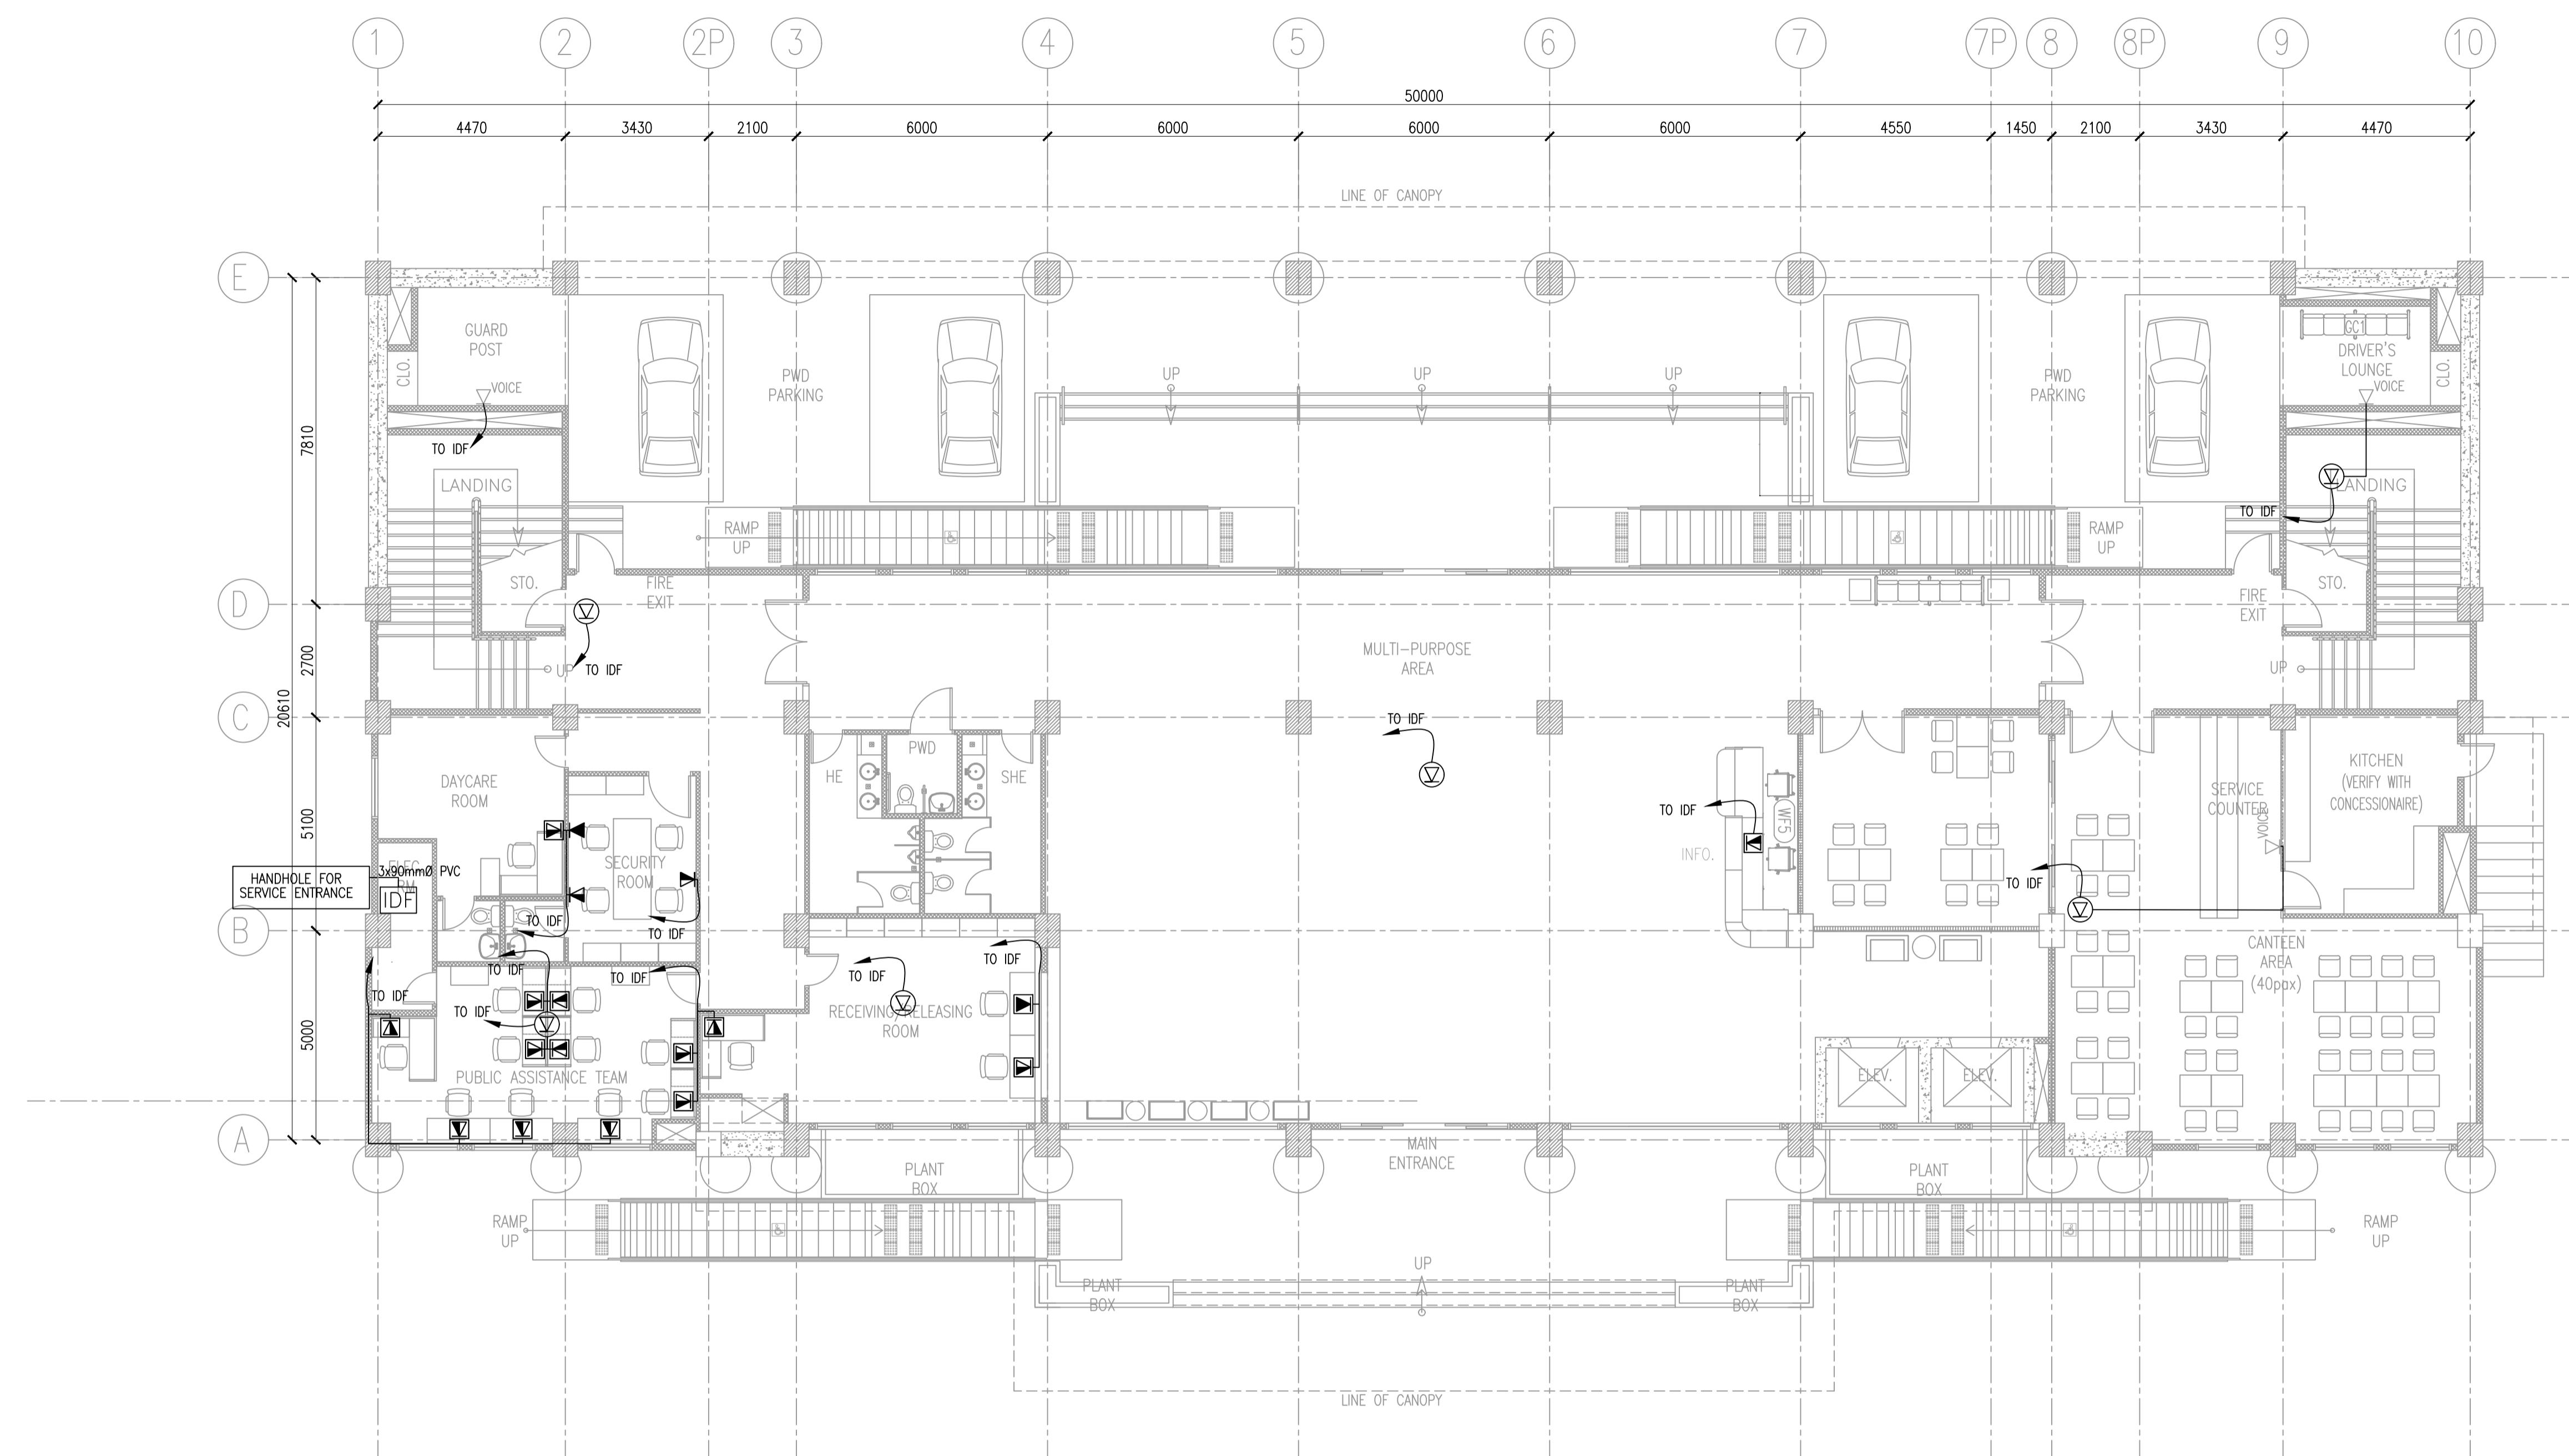

LEGENDS		DESCRIPTION			
	UNIVERSAL INFORMATION OUTLET, DUAL PORT (VOICE & DATA) FLOOR MOUNTED	CONDUIT SIZE	25mmØC	32mmØC	40mmØC
	UNIVERSAL INFORMATION OUTLET, SINGLE PORT FLOOR MOUNTED (VOICE)	#24 AWG CAT 6	2-4	5-6	7-10
	UNIVERSAL INFORMATION OUTLET, SINGLE PORT FLOOR MOUNTED (DATA)				
	WIRELESS ACCESS POINT (WAP) CEILING MOUNTED				
	UNIVERSAL INFORMATION OUTLET, DUAL PORT (VOICE & DATA) WALL MOUNTED				
	UNIVERSAL INFORMATION OUTLET, SINGLE PORT (VOICE) WALL MOUNTED				
	UNIVERSAL INFORMATION OUTLET, SINGLE PORT (DATA) WALL MOUNTED				
	INTERMEDIATE DISTRIBUTION FRAME				

CONDUIT SIZE	25mmØC	32mmØC	40mmØC
#24 AWG CAT 6	2-4	5-6	7-10

NOTE	DESCRIPTION
	HIGHLIGHTED OUTLETS ARE UNDER REVISE PLANS
	NOT HIGHLIGHTED OUTLETS ARE UNDER ORIGINAL PLANS


1
ECE-3
REVISED GROUND FLOOR PLAN
SCALE: 200 MTS

NOTE:
PURSUANT TO SECTION 4 OF ANNEX "A" OF THE REVISED IMPLEMENTING RULES AND REGULATION OF R.A. 9184, APPROVED BY THE AUTHORIZED DPWH OFFICIALS OF DETAILED ENGINEERING SURVEYS AND DESIGN UNDERTAKEN BY CONSULTANTS NEITHER DIMINISHES THE RESPONSIBILITY OF THE LATTER FOR THE TECHNICAL INTEGRITY OF THE SURVEYS AND DESIGN NOR TRANSFER ANY PART OF THAT RESPONSIBILITY TO THE APPROVING OFFICIALS.

THE DESIGN CONSULTANT SHALL BE HELD FULLY RESPONSIBLE FOR THE FAILURE OF THE FACILITY/IES/STRUCTURES DUE TO FAULTY DESIGN EXCEPT FOR THE CHANGES MADE WITHOUT THE CONFORMITY OF THE CONSULTANTS.

ORVILLE R. SINGSON

ELECTRICAL DESIGN
POSITION: ELECTRICAL ENGINEER
PRC No.: 0004017PTR TIN No.: 155-838-103
PTR No.: 7222893, 01-03-18, MARIKINA CITY

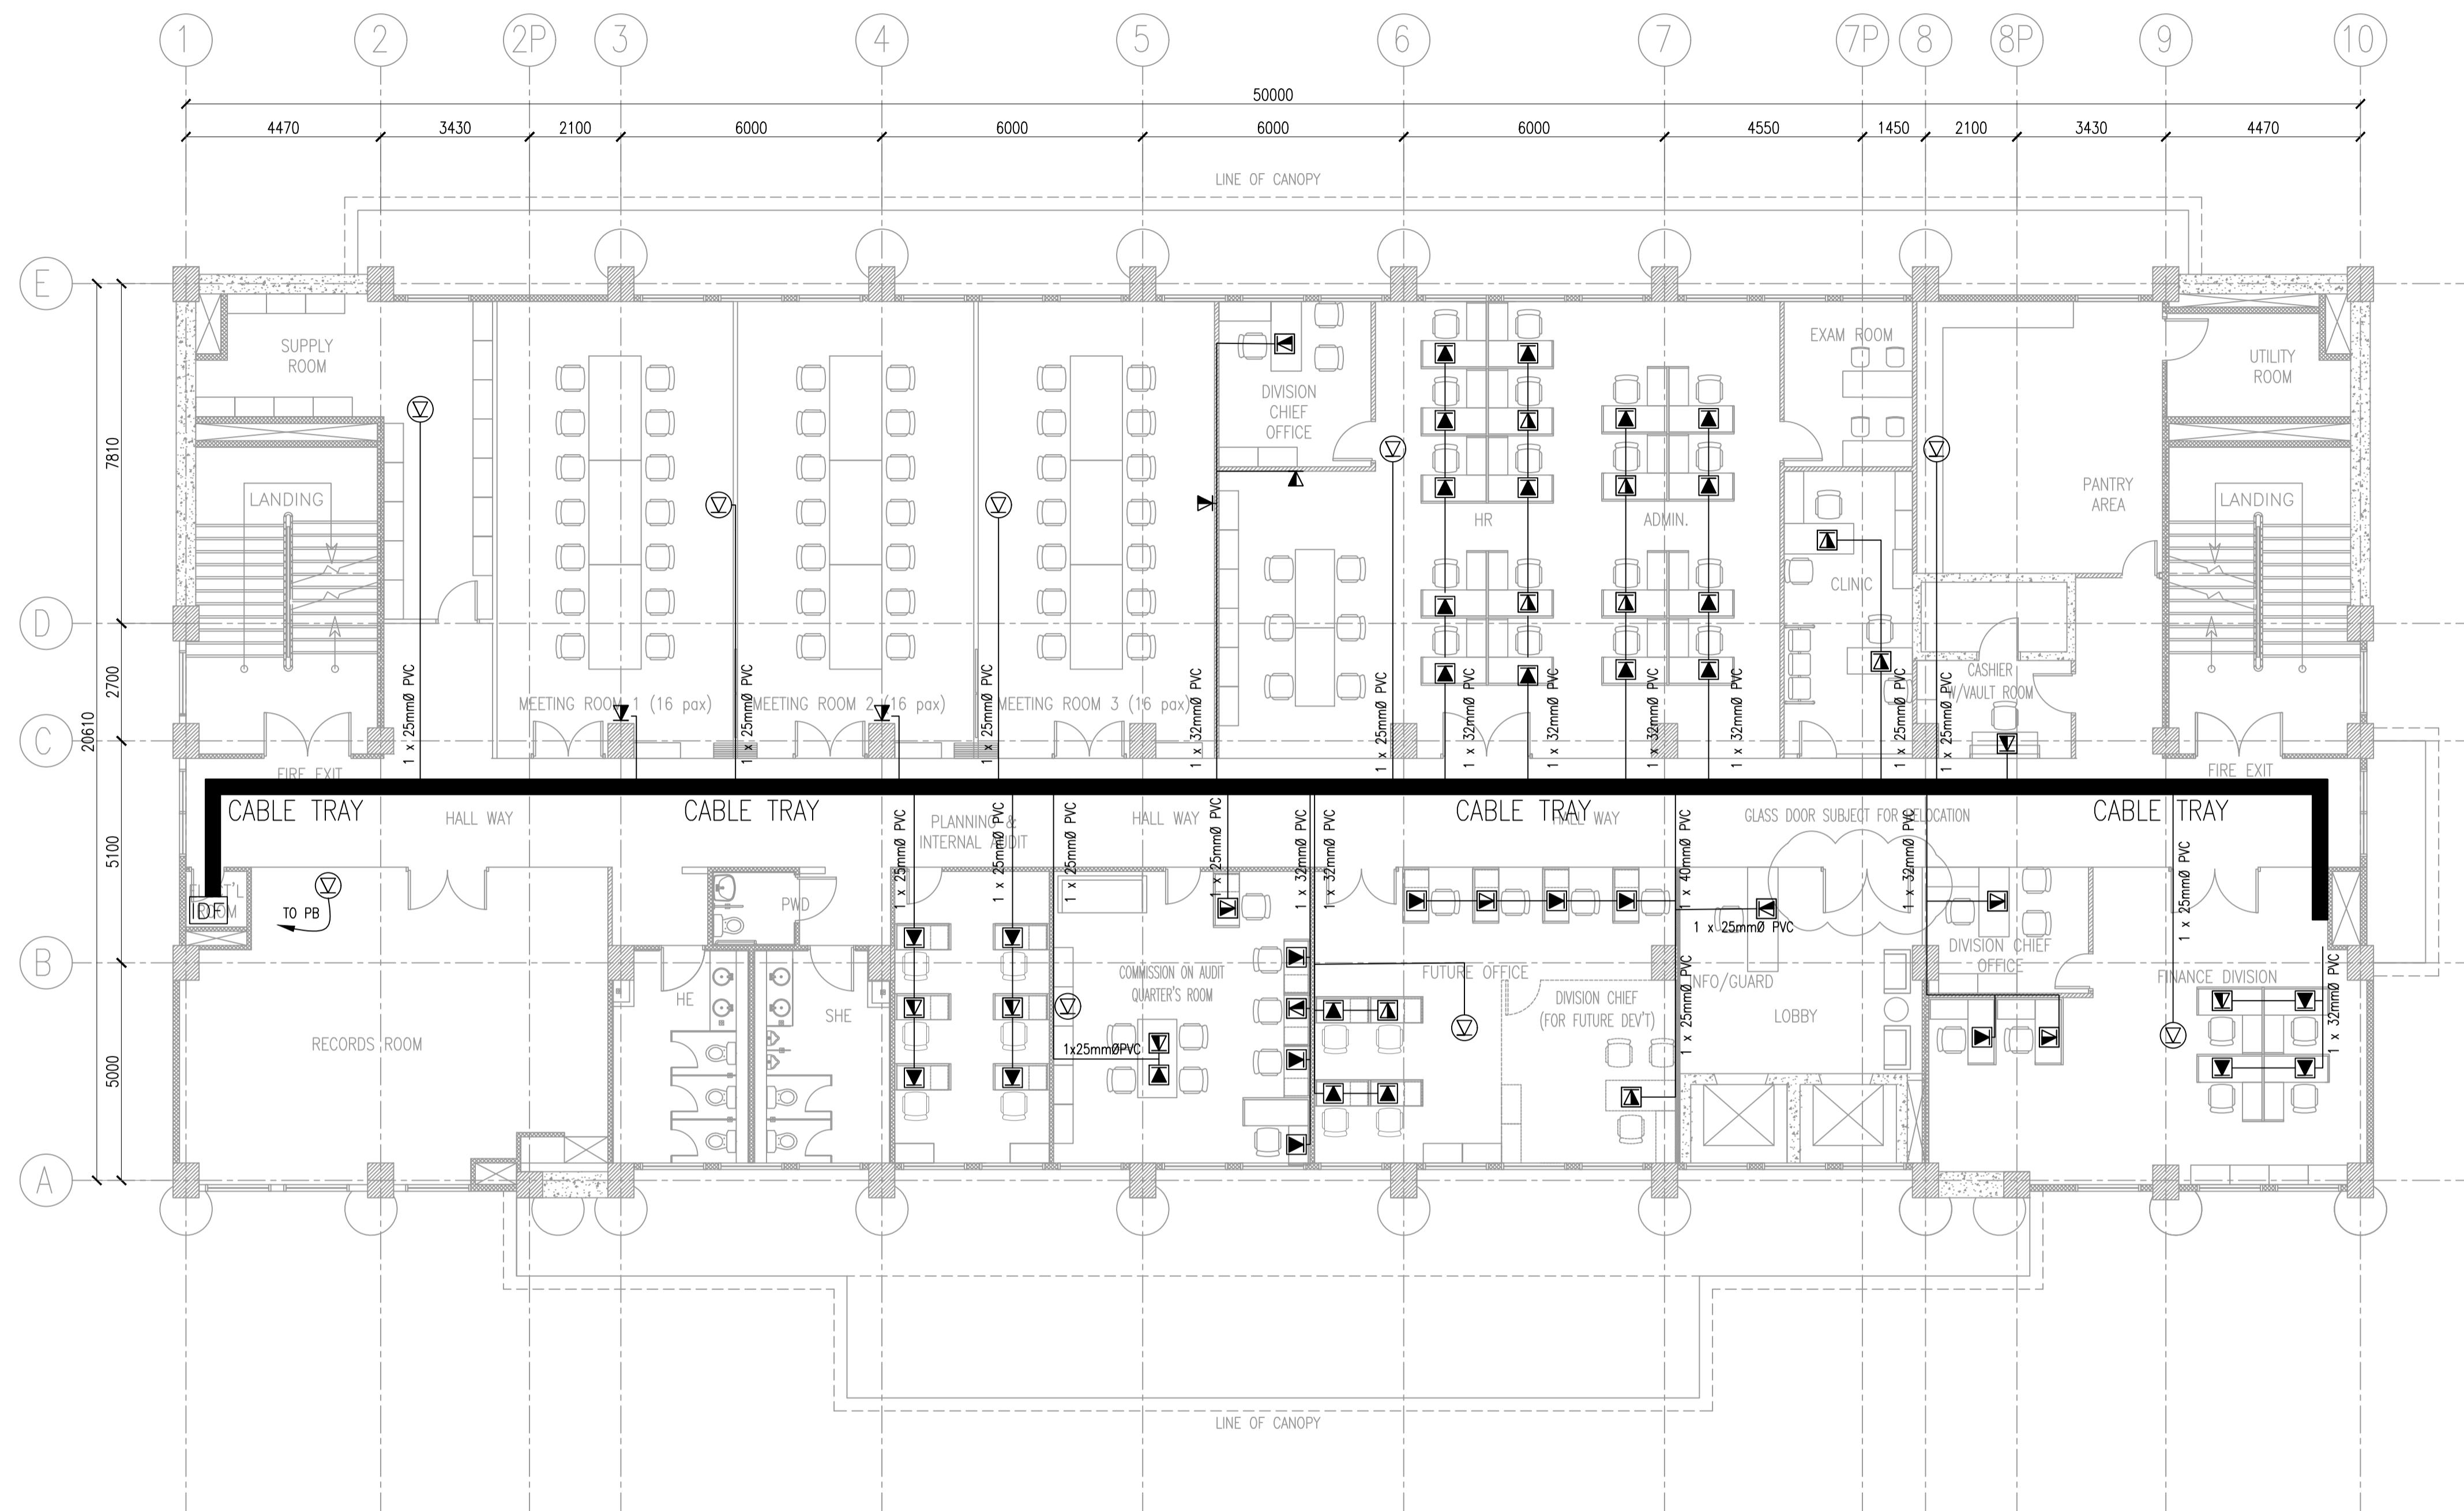

LEGENDS		DESCRIPTION		
<input checked="" type="checkbox"/>		UNIVERSAL INFORMATION OUTLET, DUAL PORT (VOICE & DATA) FLOOR MOUNTED	CONDUIT SIZE	25mmØC 32mmØC 40mmØC
<input checked="" type="checkbox"/>		UNIVERSAL INFORMATION OUTLET SINGLE PORT FLOOR MOUNTED (VOICE)	#24 AWG CAT 6	2-4 5-6 7-10
<input checked="" type="checkbox"/>		UNIVERSAL INFORMATION OUTLET SINGLE PORT FLOOR MOUNTED (DATA)		
<input checked="" type="checkbox"/>		WIRELESS ACCESS POINT (WAP) CEILING MOUNTED		
<input checked="" type="checkbox"/>		UNIVERSAL INFORMATION OUTLET, DUAL PORT (VOICE & DATA) WALL MOUNTED		
<input checked="" type="checkbox"/>		UNIVERSAL INFORMATION OUTLET, SINGLE PORT (VOICE) WALL MOUNTED		
<input checked="" type="checkbox"/>		UNIVERSAL INFORMATION OUTLET, SINGLE PORT (DATA) WALL MOUNTED		
<input checked="" type="checkbox"/>	IDF	INTERMEDIATE DISTRIBUTION FRAME		

CONDUIT SIZE	25mmØC	32mmØC	40mmØC
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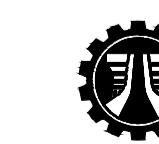
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ECE-4 REVISED SECOND FLOOR PLAN
SCALE: 200 MTS


NOTE:
PURSUANT TO SECTION 4 OF ANNEX "A" OF THE REVISED IMPLEMENTING RULES AND REGULATION OF R.A. 9184, APPROVAL BY THE AUTHORIZED DPWH OFFICIALS OF DETAILED ENGINEERING SURVEYS AND DESIGN UNDERTAKEN BY CONSULTANTS NEITHER DIMINISHES THE RESPONSIBILITY OF THE LATTER FOR THE TECHNICAL INTEGRITY OF THE SURVEYS AND DESIGN NOR TRANSFER ANY PART OF THAT RESPONSIBILITY TO THE APPROVING OFFICIALS.

THE DESIGN CONSULTANT SHALL BE HELD FULLY RESPONSIBLE FOR THE FAILURE OF THE FACILITY/IES/STRUCTURES DUE TO FAULTY DESIGN EXCEPT FOR THE CHANGES MADE WITHOUT THE CONFORMITY OF THE CONSULTANTS.

ORVILLE R. SINGSON

ELECTRICAL DESIGN
POSITION: ELECTRICAL ENGINEER
PRC No.: 0004017PTR TIN No.: 155-838-103
PTR No.: 7222893, 01-03-18, MARIKINA CITY



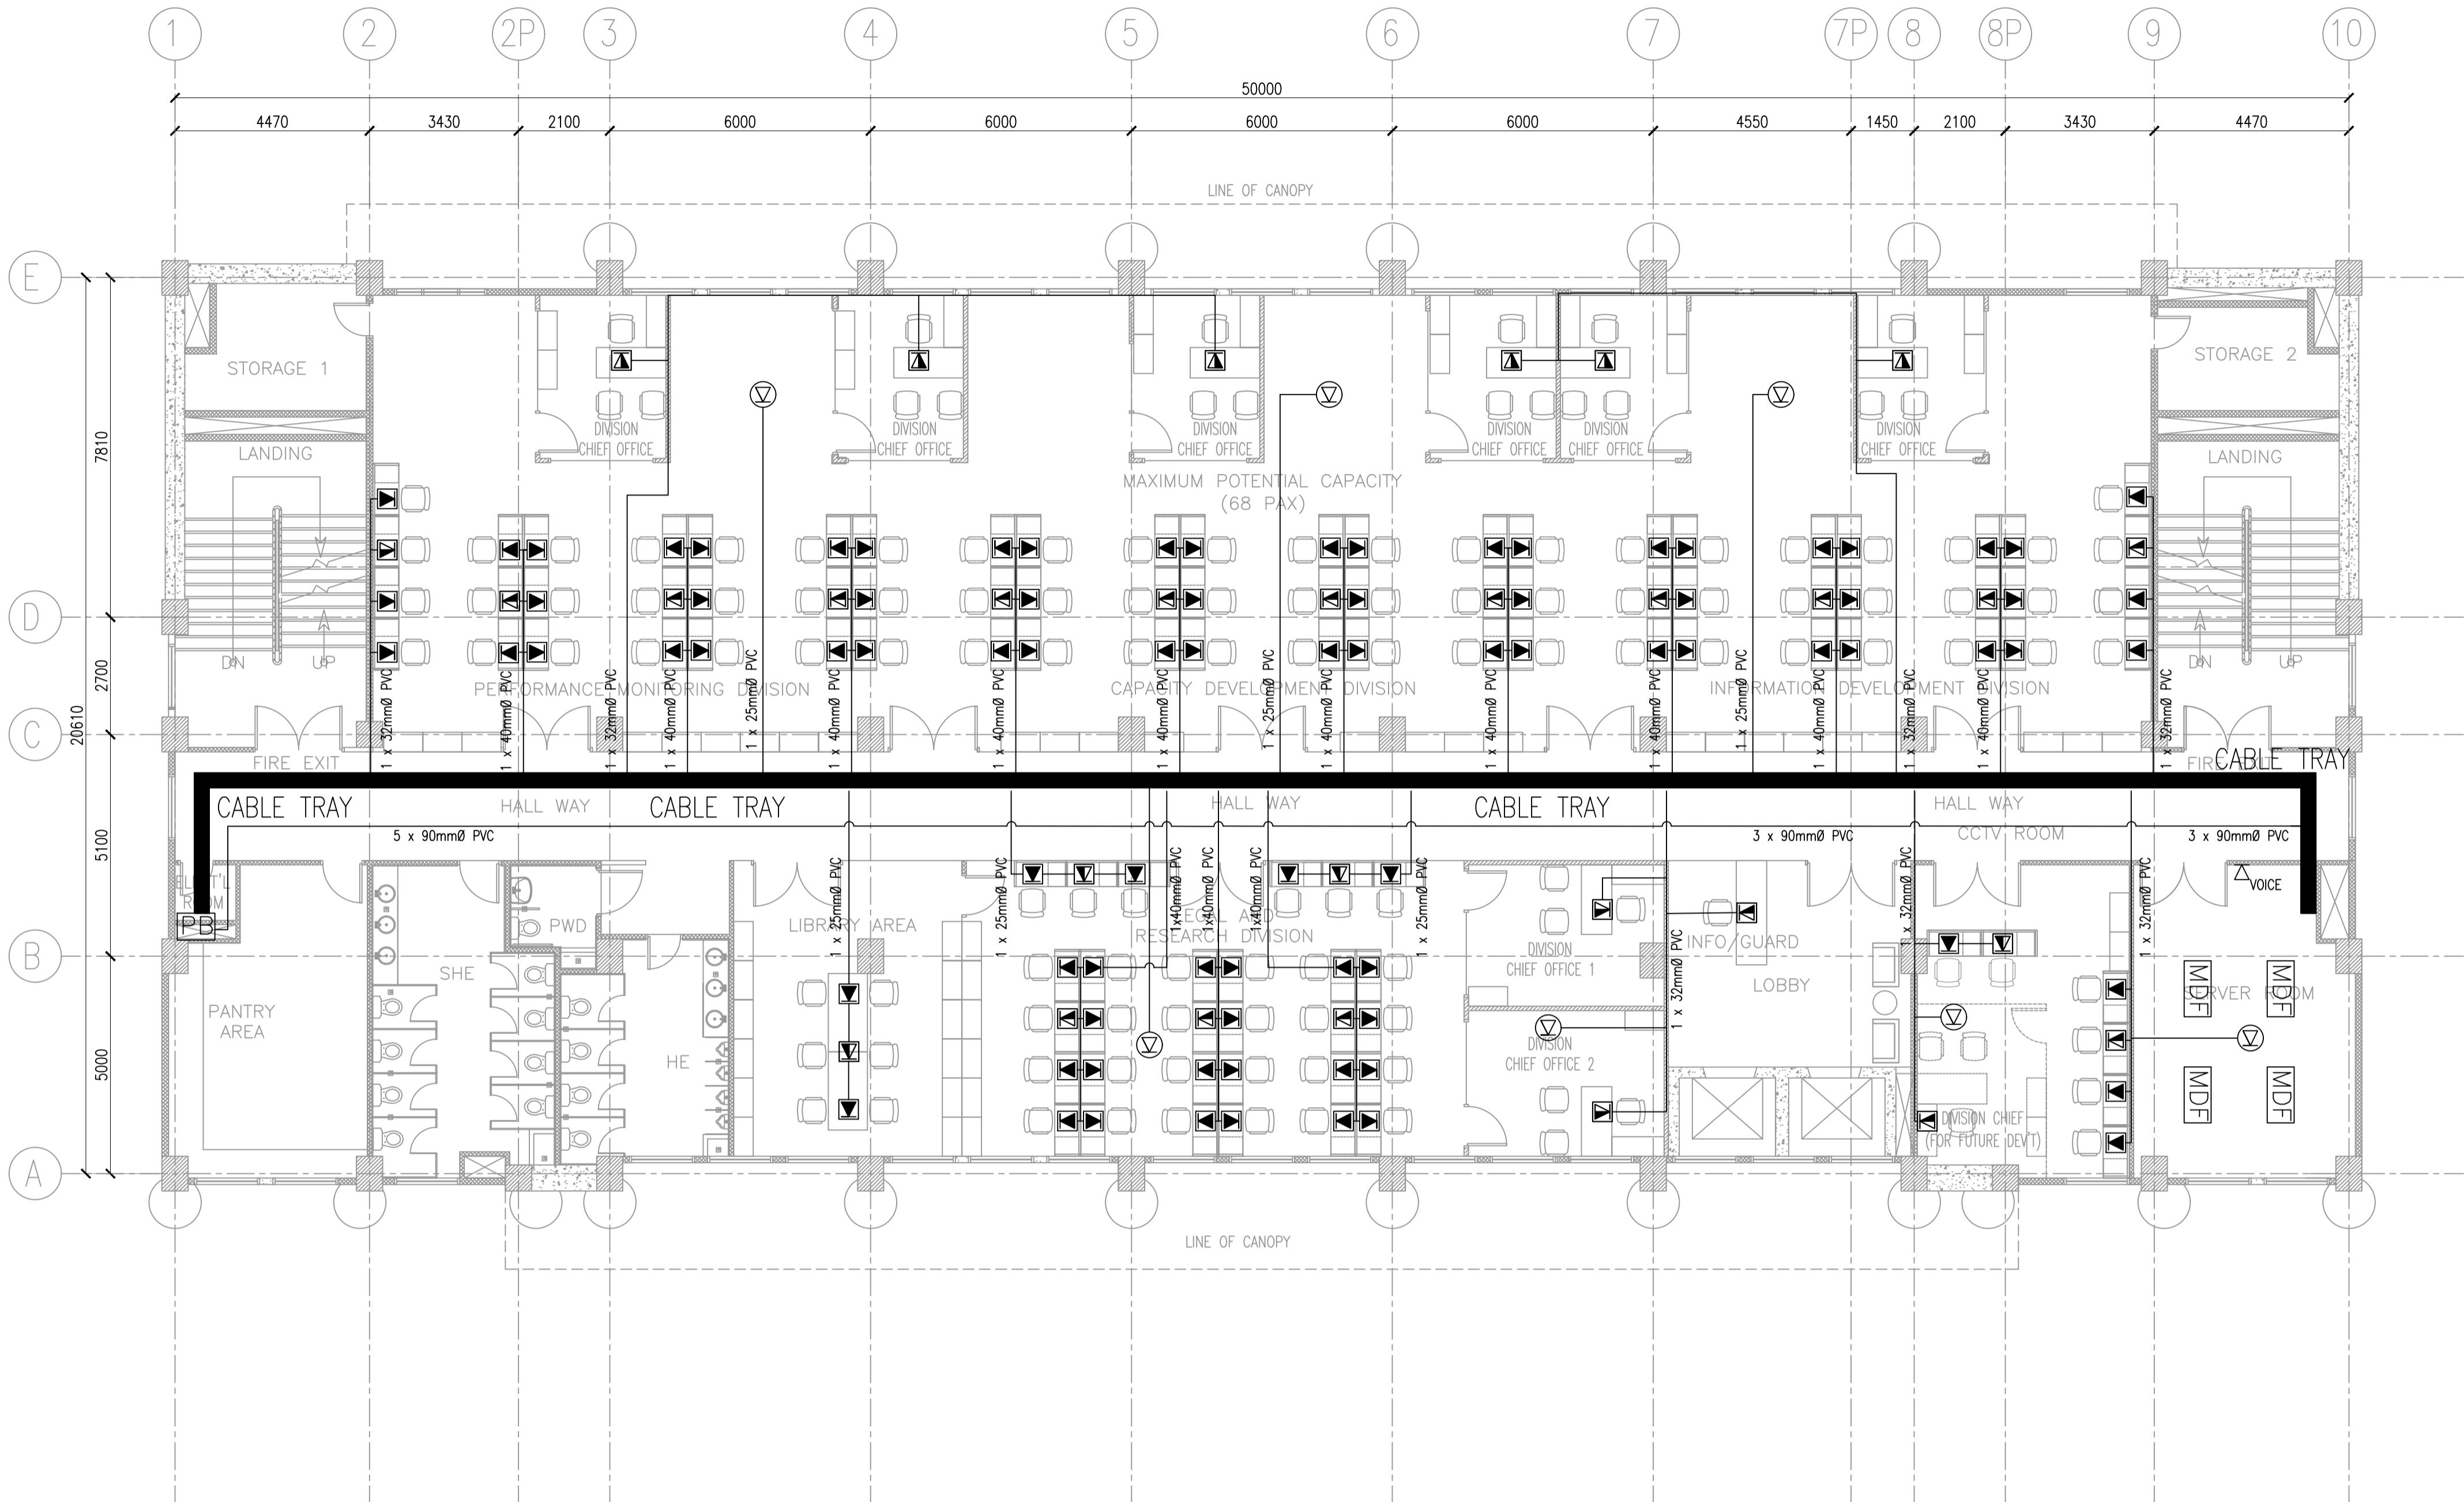

LEGENDS		DESCRIPTION
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<input checked="" type="checkbox"/>	UNIVERSAL INFORMATION OUTLET, SINGLE PORT FLOOR MOUNTED (VOICE)	
<input checked="" type="checkbox"/>	UNIVERSAL INFORMATION OUTLET, SINGLE PORT FLOOR MOUNTED (DATA)	
<input checked="" type="checkbox"/>	WIRELESS ACCESS POINT (WAP) CEILING MOUNTED	
<input checked="" type="checkbox"/>	UNIVERSAL INFORMATION OUTLET, DUAL PORT (VOICE & DATA) WALL MOUNTED	
<input checked="" type="checkbox"/>	UNIVERSAL INFORMATION OUTLET, SINGLE PORT (VOICE) WALL MOUNTED	
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<input checked="" type="checkbox"/>	INTERMEDIATE DISTRIBUTION FRAME	
<input checked="" type="checkbox"/>	MAIN DISTRIBUTION FRAME	


CONDUIT SIZE	25mm ² C	32mm ² C	40mm ² C
#24 AWG CAT 6	2-4	5-6	7-10


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ECE-5
REVISED THIRD FLOOR PLAN
SCALE: 200 MTS

NOTE:
PURSUANT TO SECTION 4 OF ANNEX "A" OF THE REVISED IMPLEMENTING RULES AND REGULATION OF R.A. 9184, APPROVAL BY THE AUTHORIZED DPWH OFFICIALS OF DETAILED ENGINEERING SURVEYS AND DESIGN UNDERTAKEN BY CONSULTANTS NEITHER DIMINISHES THE RESPONSIBILITY OF THE LATTER FOR THE TECHNICAL INTEGRITY OF THE SURVEYS AND DESIGN NOR TRANSFER ANY PART OF THAT RESPONSIBILITY TO THE APPROVING OFFICIALS.

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ORVILLE R. SINGSON
ELECTRICAL DESIGN
POSITION: ELECTRICAL ENGINEER
PRC No.: 0004017PTR TIN No.: 155-838-103
PTR No.: 7222893, 01-03-18, MARIKINA CITY



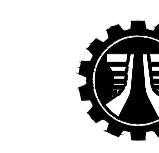

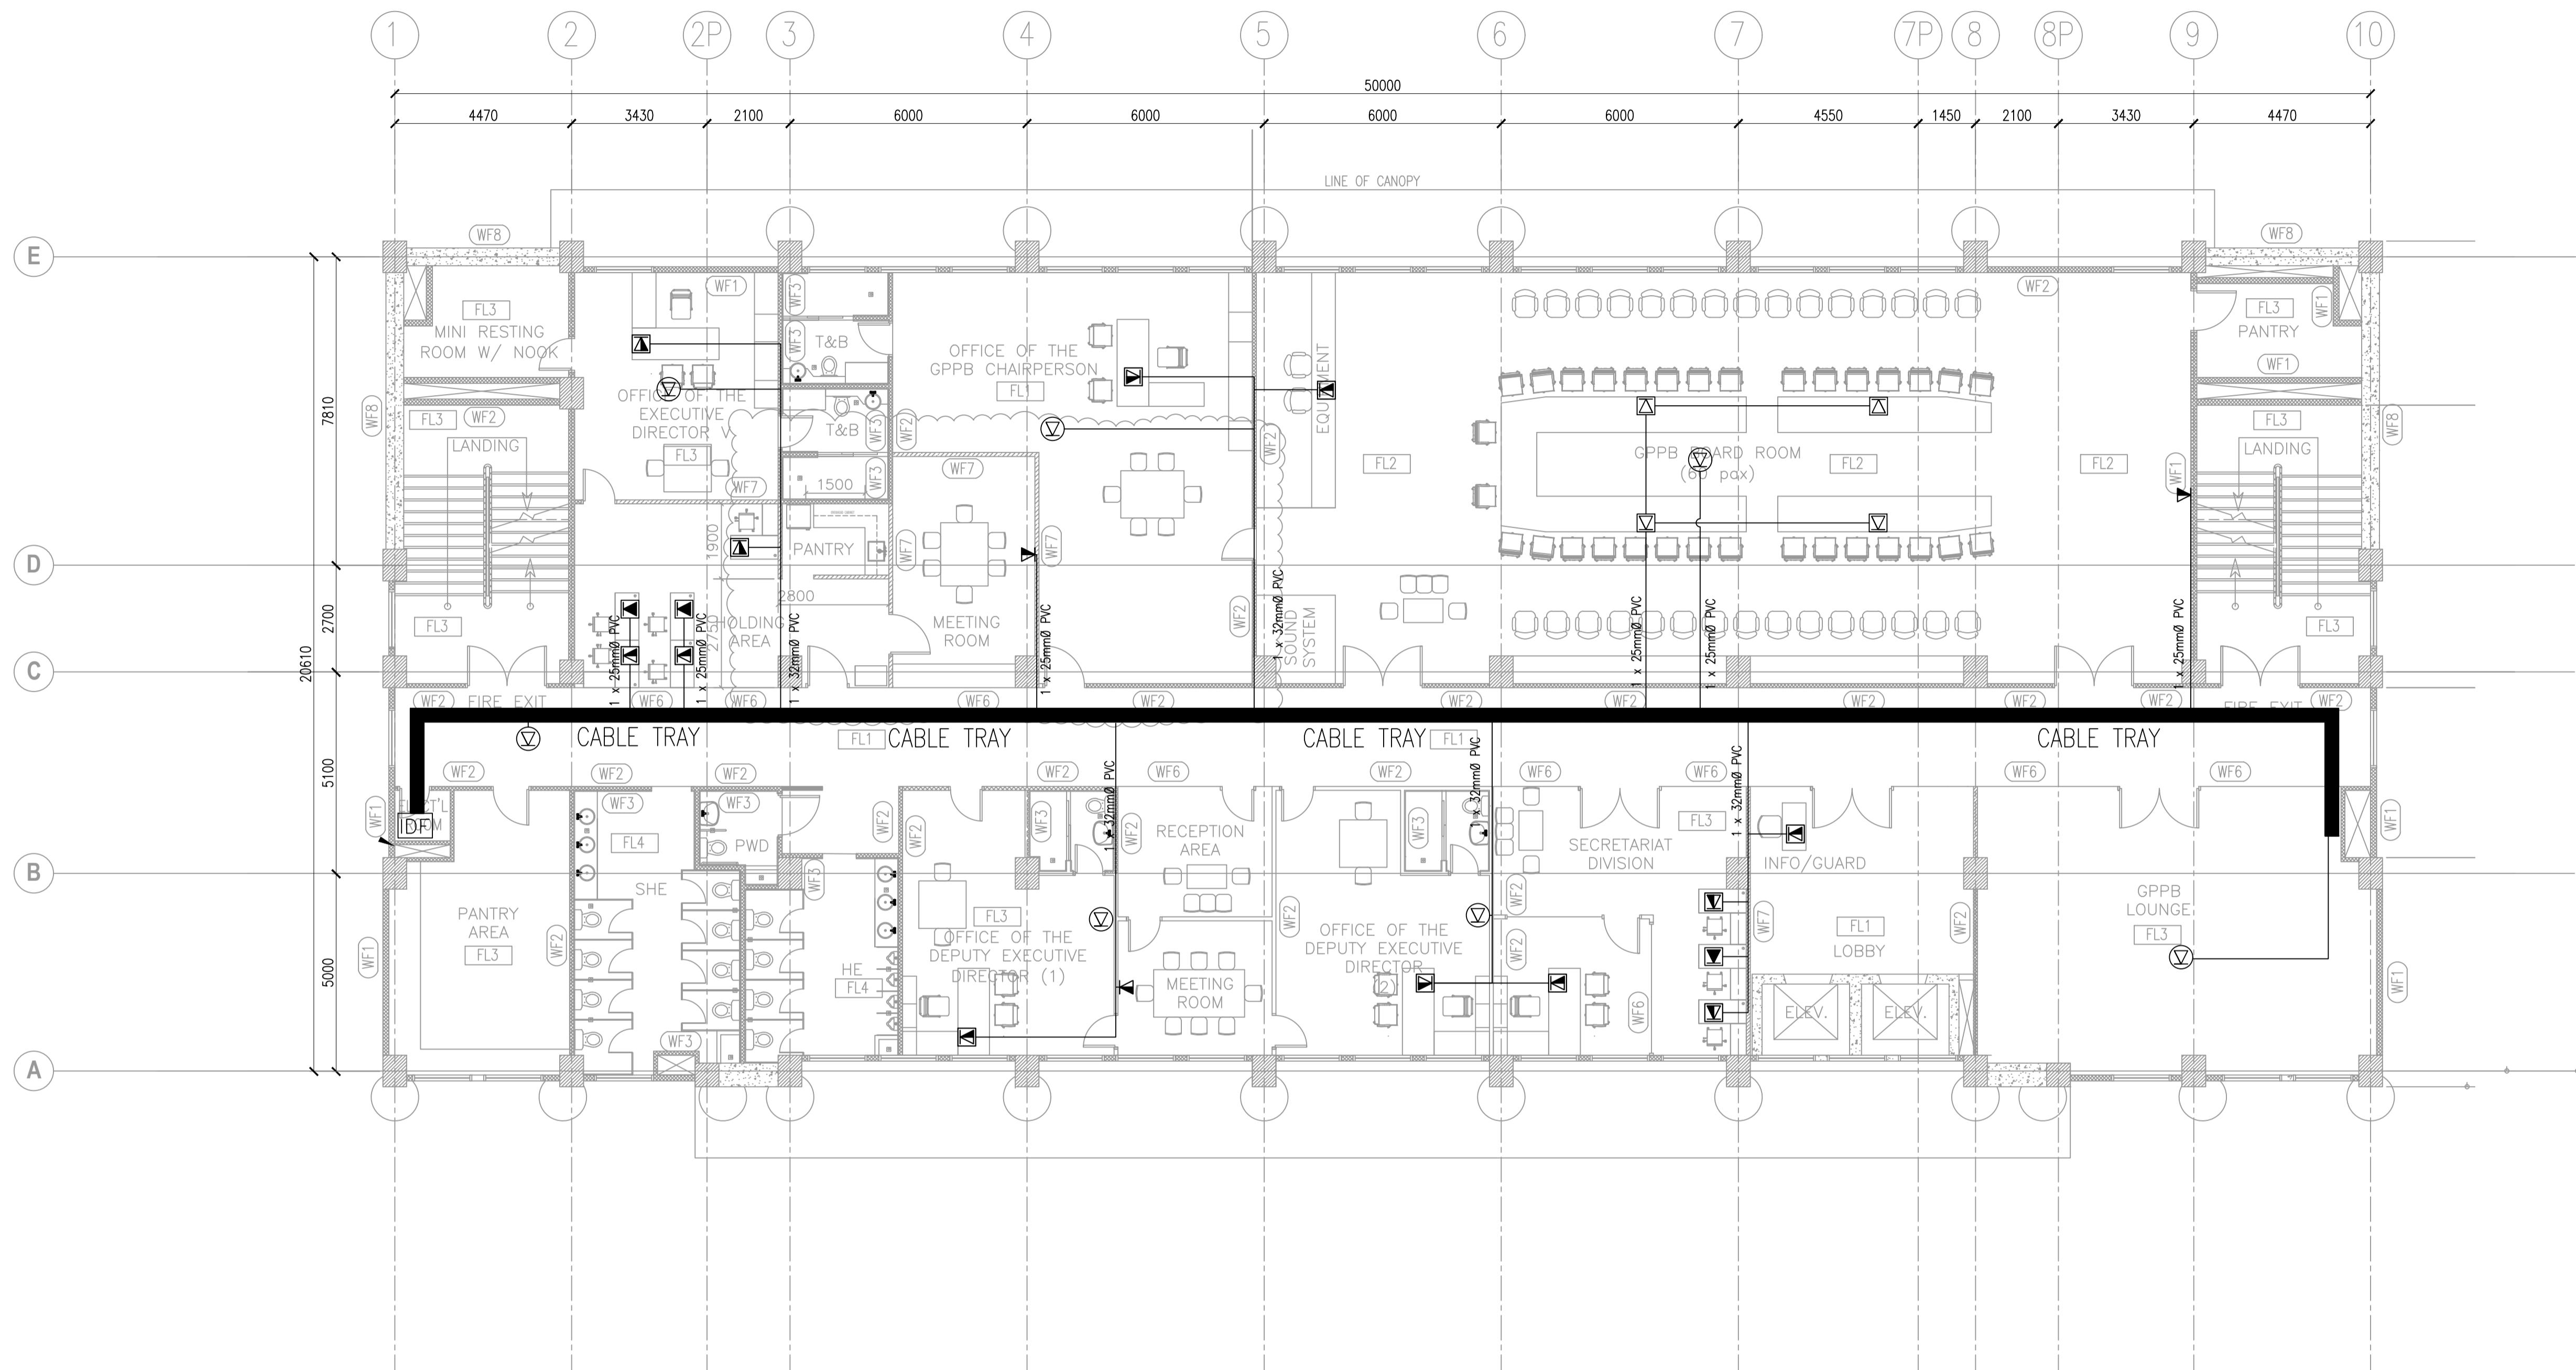LEGENDS		DESCRIPTION
<input checked="" type="checkbox"/>		UNIVERSAL INFORMATION OUTLET, DUAL PORT (VOICE & DATA) FLOOR MOUNTED
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<input checked="" type="checkbox"/>		WIRELESS ACCESS POINT (WAP), CEILING MOUNTED
<input checked="" type="checkbox"/>		UNIVERSAL INFORMATION OUTLET, DUAL PORT (VOICE & DATA) WALL MOUNTED
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IDF		INTERMEDIATE DISTRIBUTION FRAME


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#24 AWG CAT 6	2-4	5-6	7-10

1
ECE-6
REVISED FOURTH FLOOR PLAN
SCALE: 200 MTS

NOTE:
PURSUANT TO SECTION 4 OF ANNEX "A" OF THE REVISED IMPLEMENTING RULES AND REGULATION OF R.A. 9184, APPROVAL BY THE AUTHORIZED DPWH OFFICIALS OF DETAILED ENGINEERING SURVEYS AND DESIGN UNDERTAKEN BY CONSULTANTS NEITHER DIMINISHES THE RESPONSIBILITY OF THE LATTER FOR THE TECHNICAL INTEGRITY OF THE SURVEYS AND DESIGN NOR TRANSFER ANY PART OF THAT RESPONSIBILITY TO THE APPROVING OFFICIALS.

THE DESIGN CONSULTANT SHALL BE HELD FULLY RESPONSIBLE FOR THE FAILURE OF THE FACILITY/IES/STRUCTURES DUE TO FAULTY DESIGN EXCEPT FOR THE CHANGES MADE WITHOUT THE CONFORMITY OF THE CONSULTANTS.

ORVILLE R. SINGSON
ELECTRICAL DESIGN
POSITION: ELECTRICAL ENGINEER
PRC No.: 0004017PTR TIN No.: 155-838-103
PTR No.: 7222893, 01-03-18, MARIKINA CITY

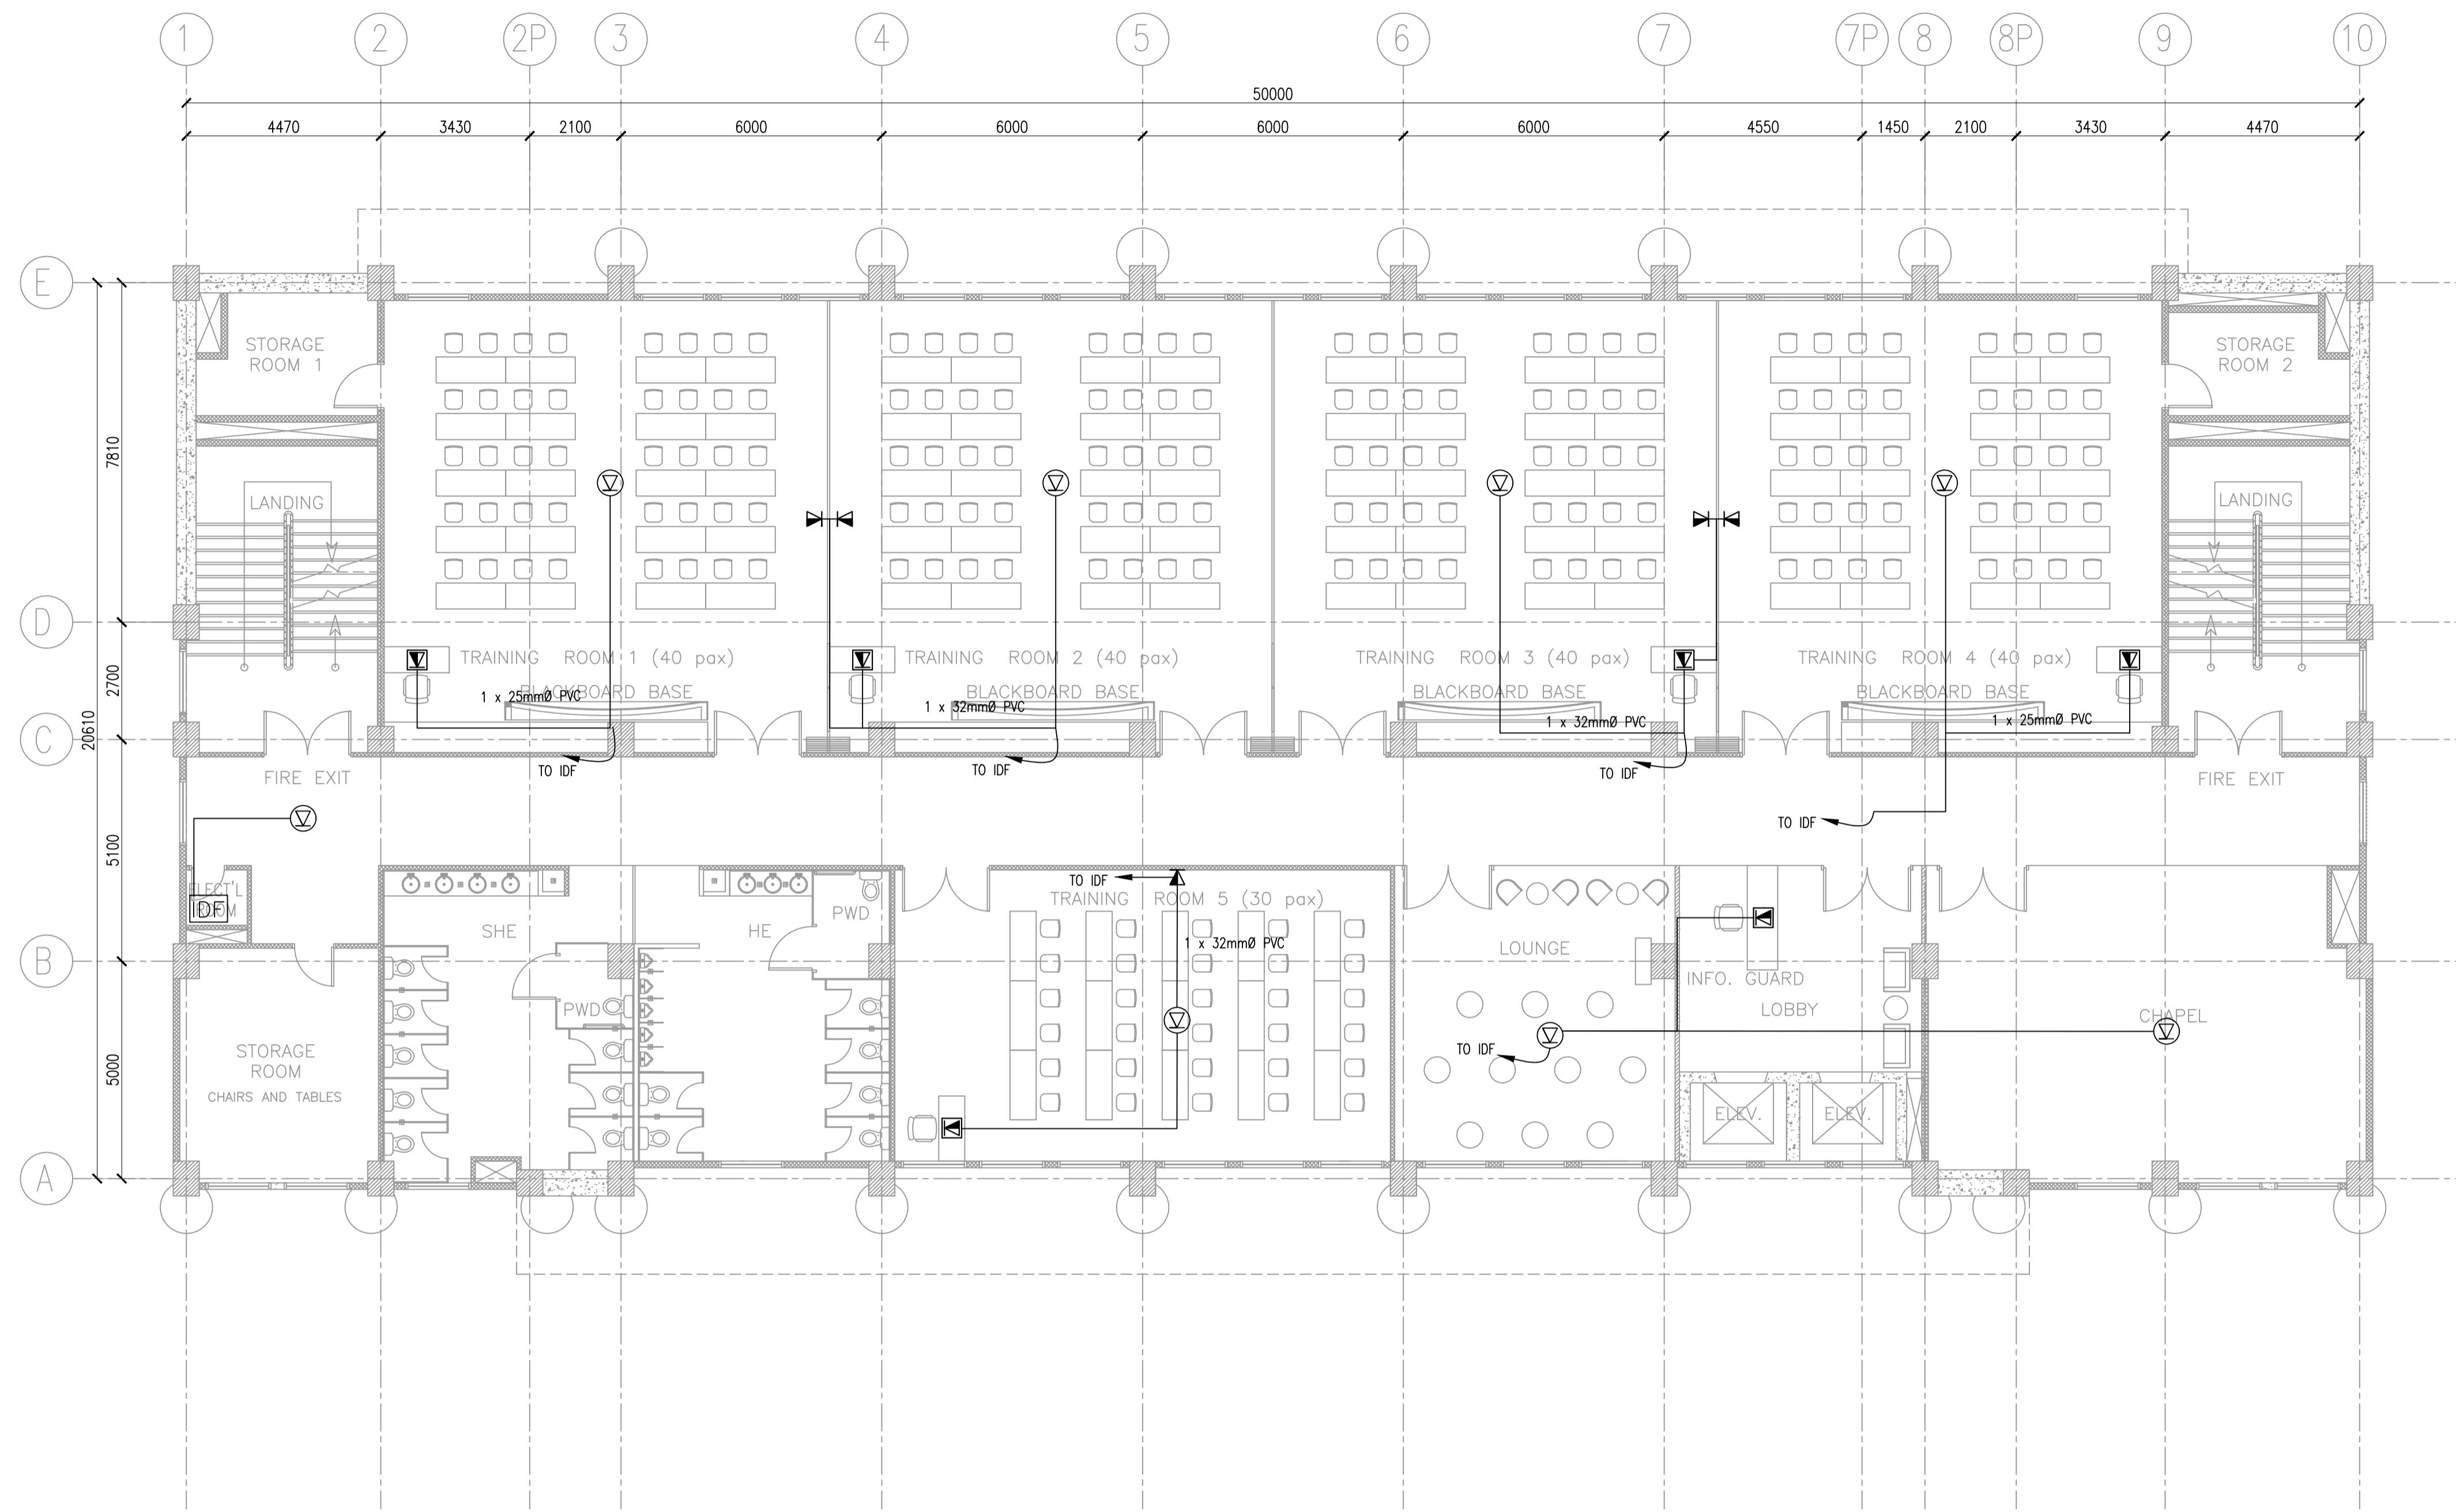

LEGENDS		DESCRIPTION		
<input checked="" type="checkbox"/>	UNIVERSAL INFORMATION OUTLET, DUAL PORT (VOICE & DATA) FLOOR MOUNTED			
<input checked="" type="checkbox"/>	UNIVERSAL INFORMATION OUTLET, SINGLE PORT FLOOR MOUNTED (VOICE)			
<input checked="" type="checkbox"/>	UNIVERSAL INFORMATION OUTLET, SINGLE PORT FLOOR MOUNTED (DATA)			
<input checked="" type="checkbox"/>	WIRELESS ACCESS POINT (WAP)			
<input checked="" type="checkbox"/>	CEILING MOUNTED			
<input checked="" type="checkbox"/>	UNIVERSAL INFORMATION OUTLET, DUAL PORT (VOICE & DATA) WALL MOUNTED			
<input checked="" type="checkbox"/>	UNIVERSAL INFORMATION OUTLET, SINGLE PORT (VOICE) WALL MOUNTED			
<input checked="" type="checkbox"/>	UNIVERSAL INFORMATION OUTLET, SINGLE PORT (DATA) WALL MOUNTED			
<input checked="" type="checkbox"/>	IDF			
CONDUIT SIZE		25mm ² C	32mm ² C	40mm ² C
#24 AWG		2-4	5-6	7-10
CAT 6				


CONDUIT SIZE	25mm ² C	32mm ² C	40mm ² C
#24 AWG	2-4	5-6	7-10

1
ECE-7
REVISED FIFTH FLOOR PLAN
SCALE: 200 MTS

NOTE:
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ORVILLE R. SINGSON
ELECTRICAL DESIGN
POSITION: ELECTRICAL ENGINEER
PRC No.: 0004017PTR TIN No.: 155-838-103
PTR No.: 7222893, 01-03-18, MARIKINA CITY



LEGENDS		DESCRIPTION
<input checked="" type="checkbox"/>		UNIVERSAL INFORMATION OUTLET, DUAL PORT (VOICE & DATA) FLOOR MOUNTED
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<input checked="" type="checkbox"/>		WIRELESS ACES POINT (WAP) CEILING MOUNTED
<input checked="" type="checkbox"/>		UNIVERSAL INFORMATION OUTLET, DUAL PORT (VOICE & DATA) WALL MOUNTED
<input checked="" type="checkbox"/>		UNIVERSAL INFORMATION OUTLET, SINGLE PORT (VOICE) WALL MOUNTED
<input checked="" type="checkbox"/>		UNIVERSAL INFORMATION OUTLET, SINGLE PORT (DATA) WALL MOUNTED
<input checked="" type="checkbox"/>	IDF	INTERMEDIATE DISTRIBUTION FRAME

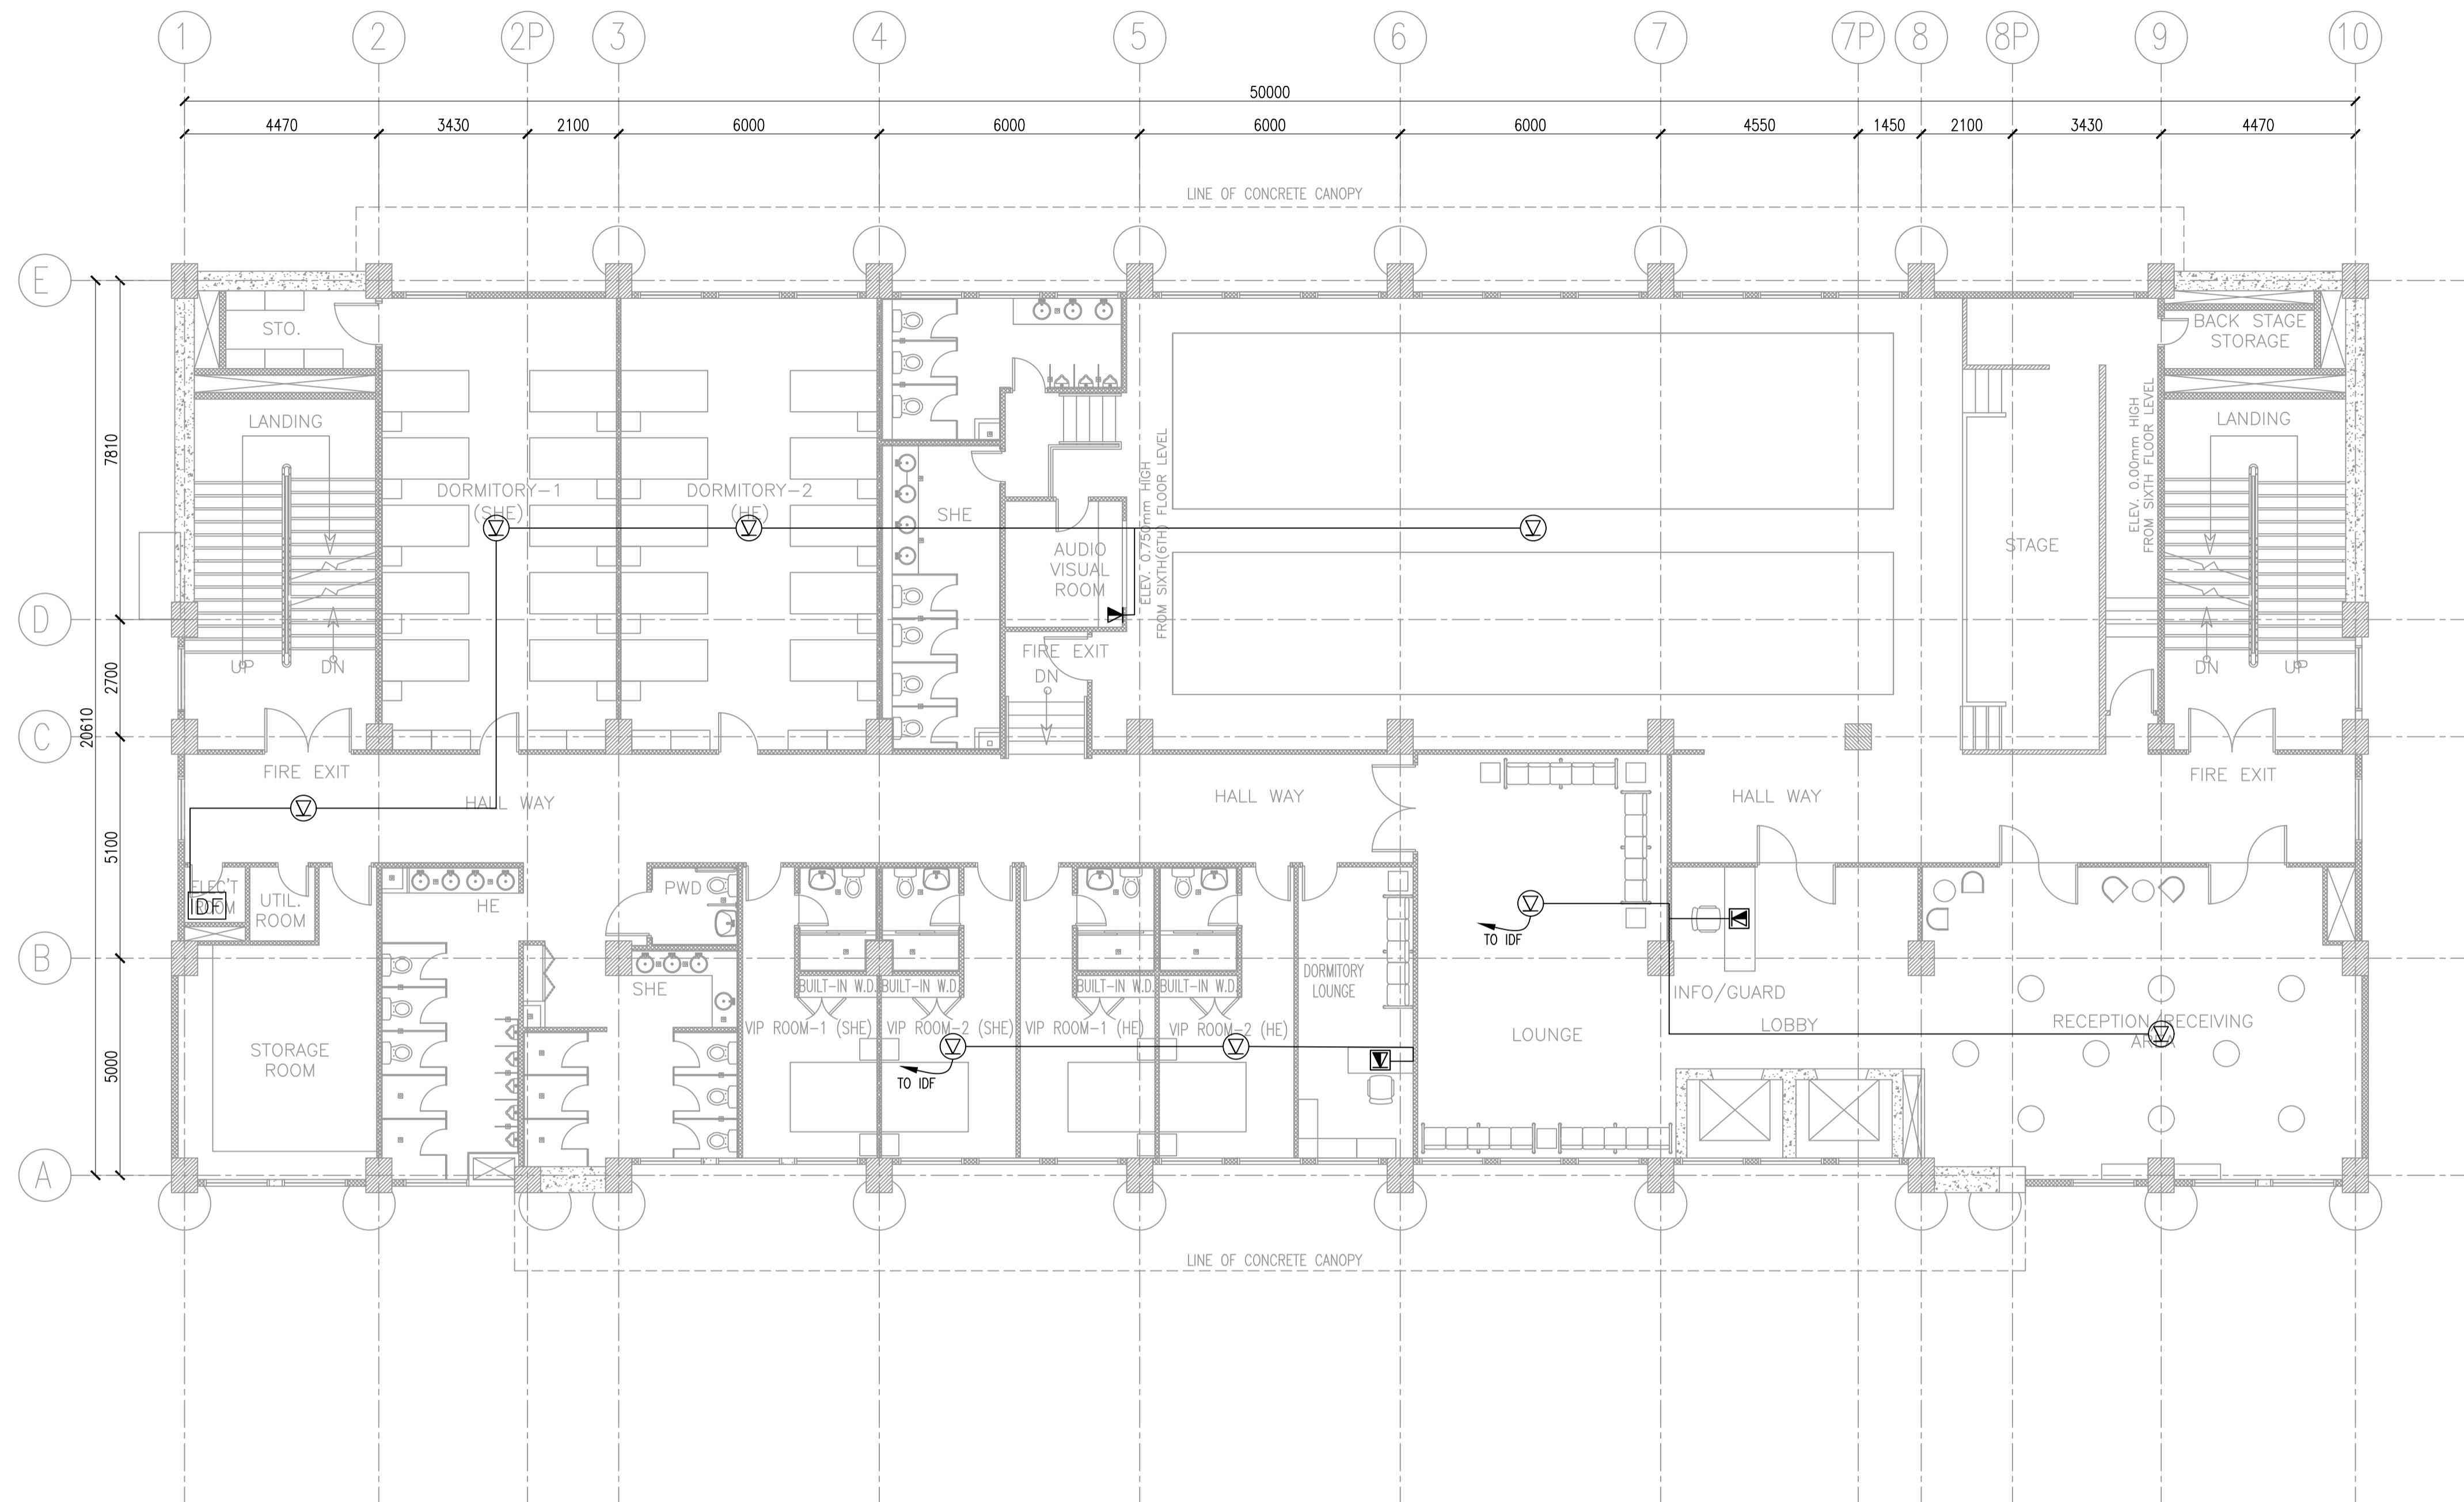CONDUIT SIZE	25mmØC	32mmØC	40mmØC
#24 AWG CAT 6	2-4	5-6	7-10

1
ECE-8
REVISED SIXTH FLOOR PLAN
SCALE: 200 MTS

NOTE:
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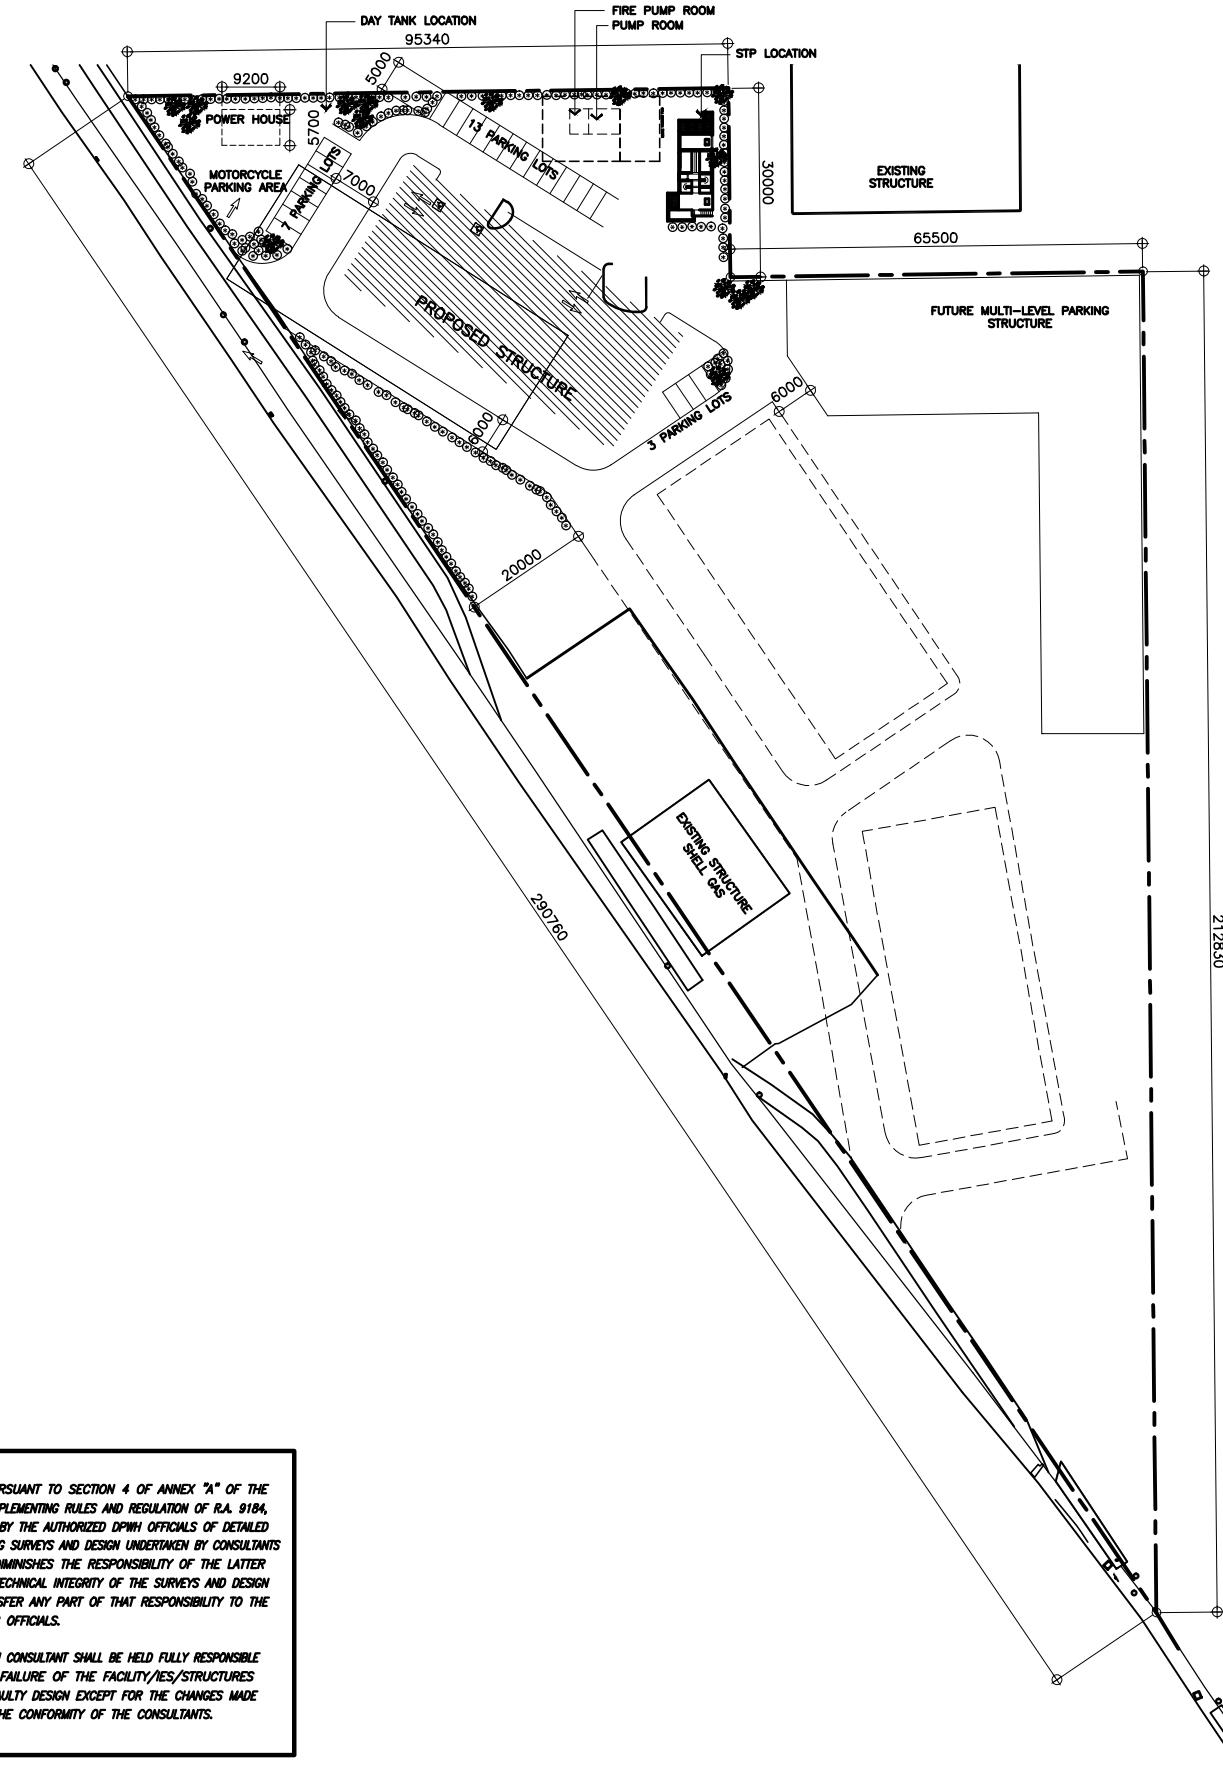
ORVILLE R. SINGSON
ELECTRICAL DESIGN
POSITION: ELECTRICAL ENGINEER
PRC No.: 0004017PTR TIN No.: 155-838-103
PTR No.: 7222893, 01-03-18, MARIKINA CITY



FRONT VIEW



REAR VIEW



1
A-1
SCALE
NTS.

2
A-1
SCALE
1:600M

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		SANITARY/PLUMBING									
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			ELECTRONICS COMMUNICATION								
UNITED TECHNOLOGIES CONSOLIDATED PARTNERSHIP	PREPARED BY: ARMAN U. CUEVAS	SUBMITTED BY: CYNTHIA CLEMEN A. YU	 REPUBLIC OF THE PHILIPPINES DEPARTMENT OF PUBLIC WORKS AND HIGHWAYS BUREAU OF DESIGN BUILDINGS DIVISION BONIFACIO DRIVE PORT AREA, MANILA	REVIEWED AS TO DESIGN CONCEPT: JOSEPHINE P. ISTURIS CHIEF BUILDINGS DIVISION, BOD	RECOMMENDING APPROVAL: (SEE COVER SHEET) LEA N. DELFINADO, CESO IV OFFICER-IN-CHARGE	APPROVED: (SEE COVER SHEET) EMIL K. SADAIN, CESO I UNDERSECRETARY FOR UPMO OPERATIONS & TECHNICAL SERVICES	CONCURRED: (SEE COVER SHEET) ROWENA CANDICE M. RUIZ EXECUTIVE DIRECTOR	PROJECT & LOCATION / BARANGAY: PROPOSED: PROPOSED SEVEN (7) STOREY GOVERNMENT PROCUREMENT POLICY BOARD (GPPB) UP DILIMAN COMPOUND, DILIMAN, QUEZON CITY	SHEET CONTENTS: TABLE OF CONTENTS	SET NO. BOD-A-2	SET NO. 4 216

NOTE:
PURSUANT TO SECTION 4 OF ANNEX "A" OF THE REVISED IMPLEMENTING RULES AND REGULATION OF RA. 9184, APPROVAL BY THE AUTHORIZED DPMH OFFICIALS OF DETAILED ENGINEERING SURVEYS AND DESIGN UNDERTAKEN BY CONSULTANTS NEITHER DIMINISHES THE RESPONSIBILITY OF THE LATTER FOR THE TECHNICAL INTEGRITY OF THE SURVEYS AND DESIGN NOR TRANSFER ANY PART OF THAT RESPONSIBILITY TO THE APPROVING OFFICIALS.


THE DESIGN CONSULTANT SHALL BE HELD FULLY RESPONSIBLE FOR THE FAILURE OF THE FACILITY/ES/STRUCTURES DUE TO FAULTY DESIGN EXCEPT FOR THE CHANGES MADE WITHOUT THE CONFORMITY OF THE CONSULTANTS.

SCHEDULE OF WALL FINISHES:

SCHEDULE OF FLOOR FINISHES:

- [FL1] 900 x 900mm POLISHED SYNTHETIC GRANITE TILE FLOOR FINISH
- [FL2] 600 x 600mm TEXTURED CERAMIC TILE (NON-SKID) FLOOR FINISH-OUTDOOR TYPE (SUBMIT SAMPLE FOR APPROVAL)-PROVIDE WATER BASE WATERPROOFING FOR TERRACE
- [FL3] 600 x 600mm CERAMIC TILE FLOOR FINISH (SUBMIT SAMPLE FOR APPROVAL)
 - (NOTE: USE 600 x 600mm CERAMIC TILE (NON-SKID) FLOOR FINISH FOR MAIN ENTRANCE STAIR/FIRE EXIT STAIR - TREADS & RISERS)
- [FL4] 600 x 600mm UNGLAZED VITRIFIED CERAMIC TILE FLOOR FINISH (SIZE & COLOR BY END-USER'S APPROVAL)-PROVIDE WATER BASE WATERPROOFING
- [FL5] NON-SKID CEMENT FLOOR FINISH WITH GROOVE LINES (PROVIDE FLOOR HARDENER)
- [FL6] PLAIN CEMENT FLOOR FINISH (PROVIDE FLOOR HARDENER)
- [FL7] 1820 x 190 x 19mm THK. LAMINATE FLOORING
- [FL8] CARPET MAD RIBBED FLOORING

	WF1	150mm THK. CHB W/ PLAIN CEMENT PLASTER (PAINTED FINISH)
	WF2	100mm THK. CHB W/ PLAIN CEMENT PLASTER (PAINTED FINISH)
	WF3	100mm THK. CHB W/ 600x600mm VITRIFIED WALL TILES (GLAZED)
	WF4	150mm THK. CHB W/ 600x600mm VITRIFIED WALL TILES (GLAZED)
	WF5	100mm THK. CHB W/ 1820x190x19mm THK. WALL PANELS
	WF6	12mm THK. TEMPERED GLASS
	WF7	DRYWALL PAINTED FINISH
	WF8	REINFORCED CONCRETE WALL
		REINFORCED CONCRETE COLUMN

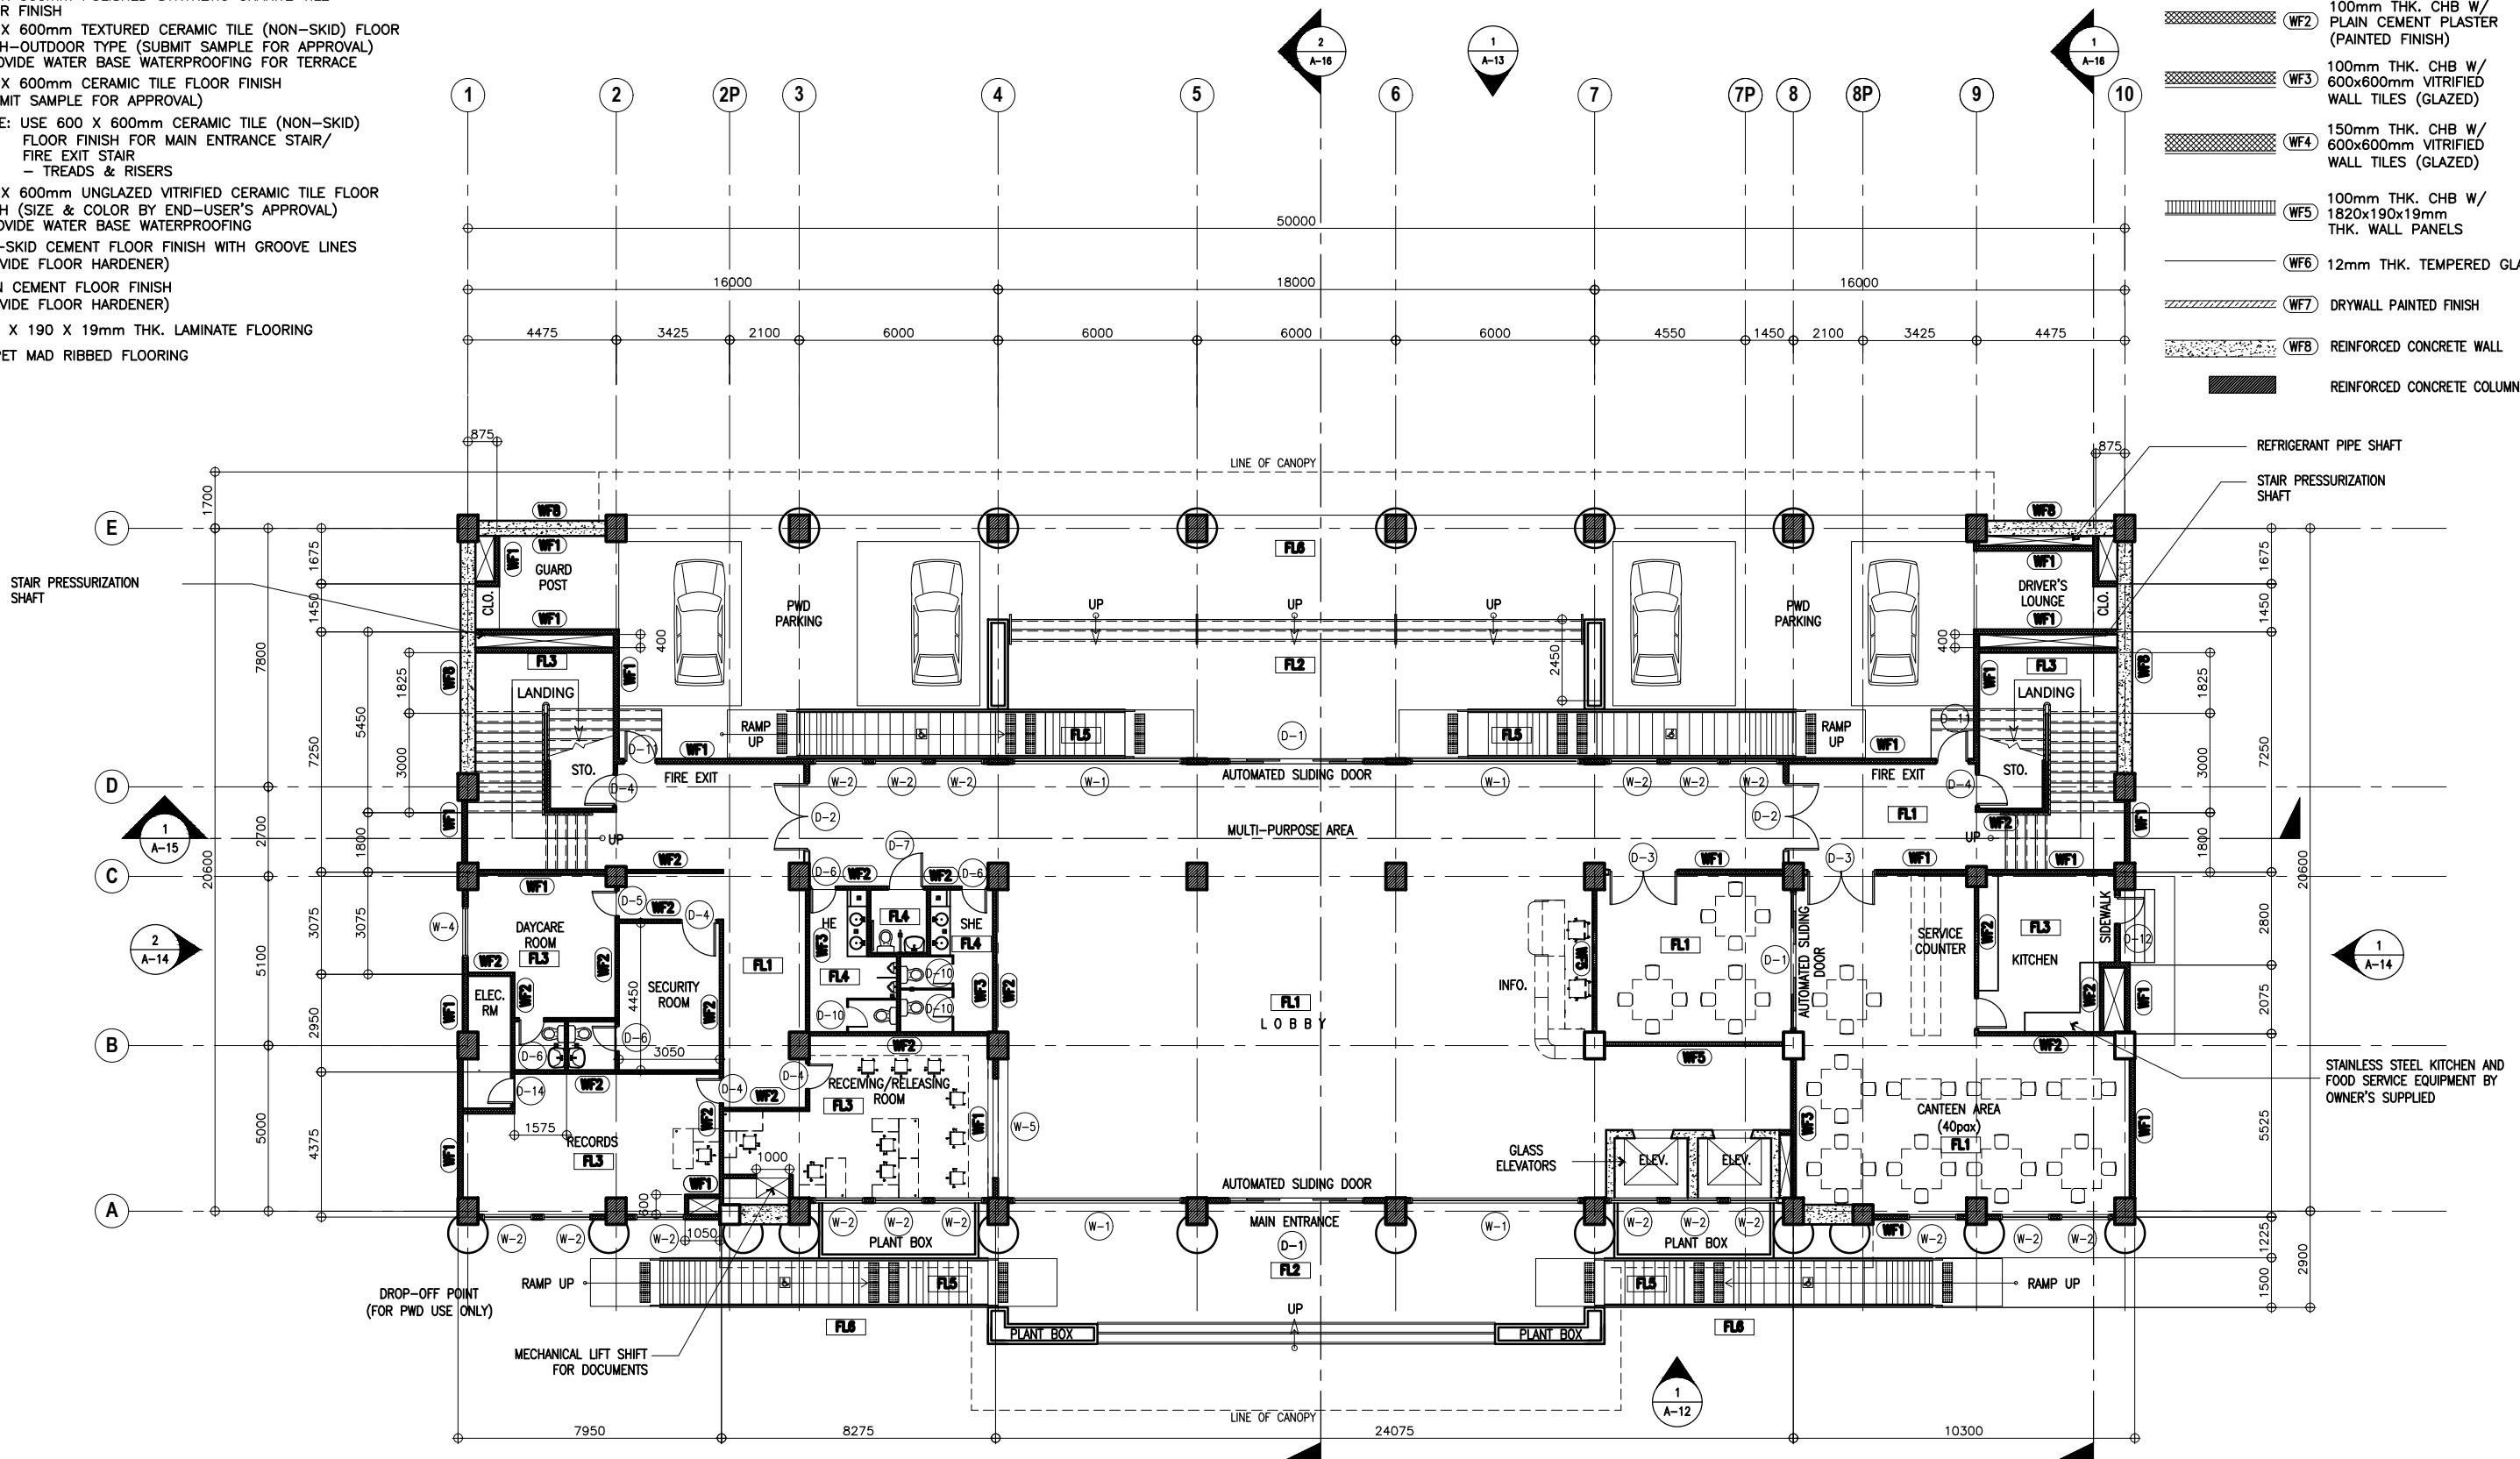

1 GROUND FLOOR PLAN
A-3 SCALE 1:100M


UNITED TECHNOLOGIES CONSOLIDATED PARTNERSHIP	PREPARED BY:	SUBMITTED BY:	REPUBLIC OF THE PHILIPPINES DEPARTMENT OF PUBLIC WORKS AND HIGHWAYS BUREAU OF DESIGN BUILDINGS DIVISION BONIFACIO DRIVE PORT AREA, MANILA	REVIEWED AS TO DESIGN CONCEPT:	RECOMMENDING APPROVAL:	APPROVED:	CONCURRED:	PROJECT & LOCATION / BARANGAY:	HEET CONTENTS:	SET NO.	HEET NO.
	ARMAN U. CUEVAS ARCHITECTURAL DESIGN POSITION ARCHITECT PRC No.: 0018676 TIN No.: 907-359-364 PTR No.: 4020896	CYNTHIA CLEMEN A. YU ARCHITECT/TEAM LEADER 	JOSEPHINE P. ISTURIS CHIEF, BUILDINGS DIVISION, BOD	(SEE COVER SHEET) LEA N. DELFINADO, CESO IV OFFICER-IN-CHARGE	(SEE COVER SHEET) EMIL K. SADAIN, CESO I UNDERSECRETARY FOR UPMO OPERATIONS & TECHNICAL SERVICES	(SEE COVER SHEET) ROWENA CANDICE M. RUIZ EXECUTIVE DIRECTOR	PROPOSED: PROPOSED SEVEN (7) STOREY GOVERNMENT PROCUREMENT POLICY BOARD (GPB) UP DILIMAN COMPOUND, DILIMAN, QUEZON CITY	GROUND FLOOR PLAN	BOD-A-3	5 216	

SCHEDULE OF FLOOR FINISHES:

- [FL1] 900 X 900mm POLISHED SYNTHETIC GRANITE TILE FLOOR FINISH
- [FL2] 600 X 600mm TEXTURED CERAMIC TILE (NON-SKID) FLOOR FINISH—OUTDOOR TYPE (SUBMIT SAMPLE FOR APPROVAL)
—PROVIDE WATER BASE WATERPROOFING FOR TERRACE
- [FL3] 600 X 600mm CERAMIC TILE FLOOR FINISH (SUBMIT SAMPLE FOR APPROVAL)
(NOTE: USE 600 X 600mm CERAMIC TILE (NON-SKID) FLOOR FINISH FOR MAIN ENTRANCE STAIR/FIRE EXIT STAIR
—TREADS & RISERS)
- [FL4] 600 X 600mm UNGLAZED VITRIFIED CERAMIC TILE FLOOR FINISH (SIZE & COLOR BY END-USER'S APPROVAL)
—PROVIDE WATER BASE WATERPROOFING
- [FL5] NON-SKID CEMENT FLOOR FINISH WITH GROOVE LINES (PROVIDE FLOOR HARDENER)
- [FL6] PLAIN CEMENT FLOOR FINISH (PROVIDE FLOOR HARDENER)
- [FL7] 1820 X 190 X 19mm THK. LAMINATE FLOORING
- [FL8] CARPET MAD RIBBED FLOORING

SCHEDULE OF WALL FINISHES:


- [WF1] 150mm THK. CHB W/ PLAIN CEMENT PLASTER (PAINTED FINISH)
- [WF2] 100mm THK. CHB W/ PLAIN CEMENT PLASTER (PAINTED FINISH)
- [WF3] 100mm THK. CHB W/ 600x600mm VITRIFIED WALL TILES (GLAZED)
- [WF4] 150mm THK. CHB W/ 600x600mm VITRIFIED WALL TILES (GLAZED)
- [WF5] 100mm THK. CHB W/ 1820x190x19mm THK. WALL PANELS
- [WF6] 12mm THK. TEMPERED GLASS
- [WF7] DRYWALL PAINTED FINISH
- [WF8] REINFORCED CONCRETE WALL
- REINFORCED CONCRETE COLUMN**

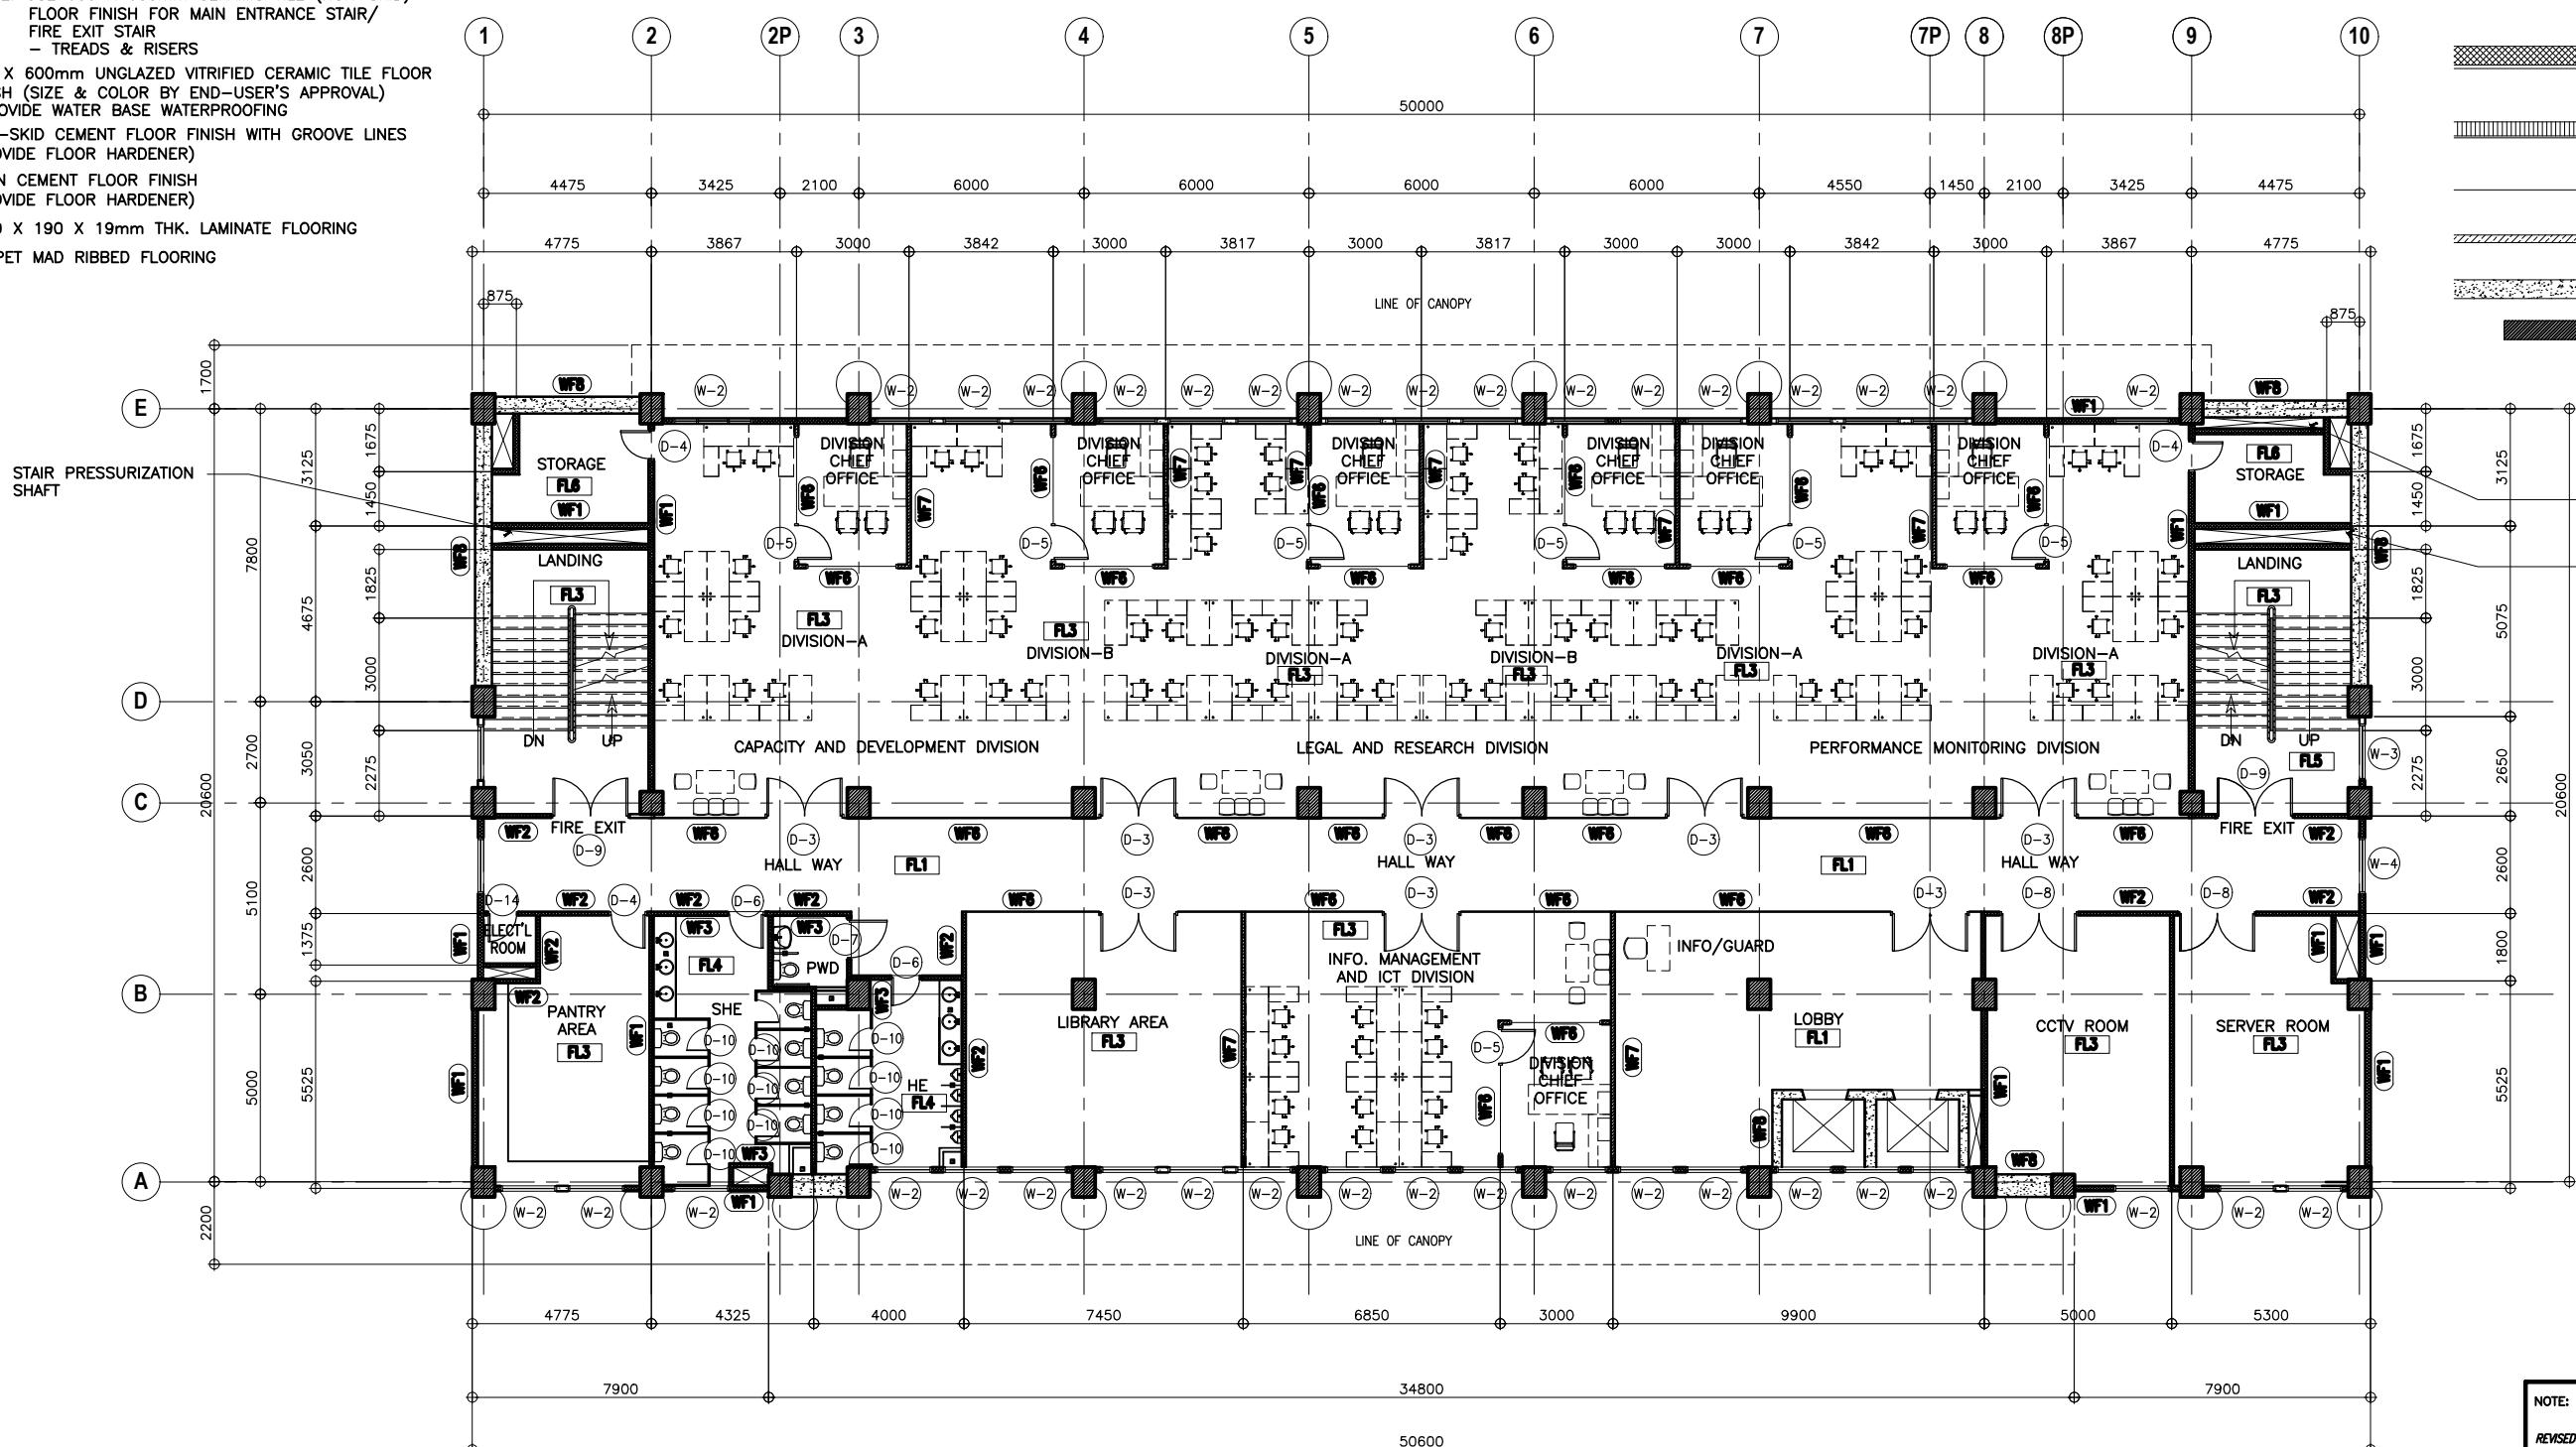

1
A-5 THIRD FLOOR PLAN
SCALE 1:100M

NOTE:
PURSUANT TO SECTION 4 OF ANNEX "A" OF THE REVISED IMPLEMENTING RULES AND REGULATION OF RA. 9184, APPROVAL BY THE AUTHORIZED DPWH OFFICIALS OF DETAILED ENGINEERING SURVEYS AND DESIGN UNDERTAKEN BY CONSULTANTS NEITHER DIMINISHES THE RESPONSIBILITY OF THE LATTER FOR THE TECHNICAL INTEGRITY OF THE SURVEYS AND DESIGN NOR TRANSFER ANY PART OF THAT RESPONSIBILITY TO THE APPROVING OFFICIALS.

THE DESIGN CONSULTANT SHALL BE HELD FULLY RESPONSIBLE FOR THE FAILURE OF THE FACILITY/IES/STRUCTURES DUE TO FAULTY DESIGN EXCEPT FOR THE CHANGES MADE WITHOUT THE CONFORMITY OF THE CONSULTANTS.

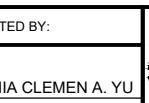


SCHEDULE OF FLOOR FINISHES:

- [FL1] 900 X 900mm POLISHED SYNTHETIC GRANITE TILE FLOOR FINISH
- [FL2] 600 X 600mm TEXTURED CERAMIC TILE (NON-SKID) FLOOR FINISH-OUTDOOR TYPE (SUBMIT SAMPLE FOR APPROVAL)
-PROVIDE WATER BASE WATERPROOFING FOR TERRACE
- [FL3] 600 X 600mm CERAMIC TILE FLOOR FINISH (SUBMIT SAMPLE FOR APPROVAL)
(NOTE: USE 600 X 600mm CERAMIC TILE (NON-SKID) FLOOR FINISH FOR MAIN ENTRANCE STAIR/FIRE EXIT STAIR - TREADS & RISERS)
- [FL4] 600 X 600mm UNGLAZED VITRIFIED CERAMIC TILE FLOOR FINISH (SIZE & COLOR BY END-USER'S APPROVAL)
-PROVIDE WATER BASE WATERPROOFING
- [FL5] NON-SKID CEMENT FLOOR FINISH WITH GROOVE LINES (PROVIDE FLOOR HARDENER)
- [FL6] PLAIN CEMENT FLOOR FINISH (PROVIDE FLOOR HARDENER)
- [FL7] 1820 X 190 X 19mm THK. LAMINATE FLOORING
- [FL8] CARPET MAD RIBBED FLOORING

SCHEDULE OF WALL FINISHES:


- [WF1] 150mm THK. CHB W/ PLAIN CEMENT PLASTER (PAINTED FINISH)
 - [WF2] 100mm THK. CHB W/ PLAIN CEMENT PLASTER (PAINTED FINISH)
 - [WF3] 100mm THK. CHB W/ 600x600mm VITRIFIED WALL TILES (GLAZED)
 - [WF4] 150mm THK. CHB W/ 600x600mm VITRIFIED WALL TILES (GLAZED)
 - [WF5] 100mm THK. CHB W/ 1820x190x19mm THK. WALL PANELS
 - [WF6] 12mm THK. TEMPERED GLASS
 - [WF7] DRYWALL PAINTED FINISH
 - [WF8] REINFORCED CONCRETE WALL
- REINFORCED CONCRETE COLUMN

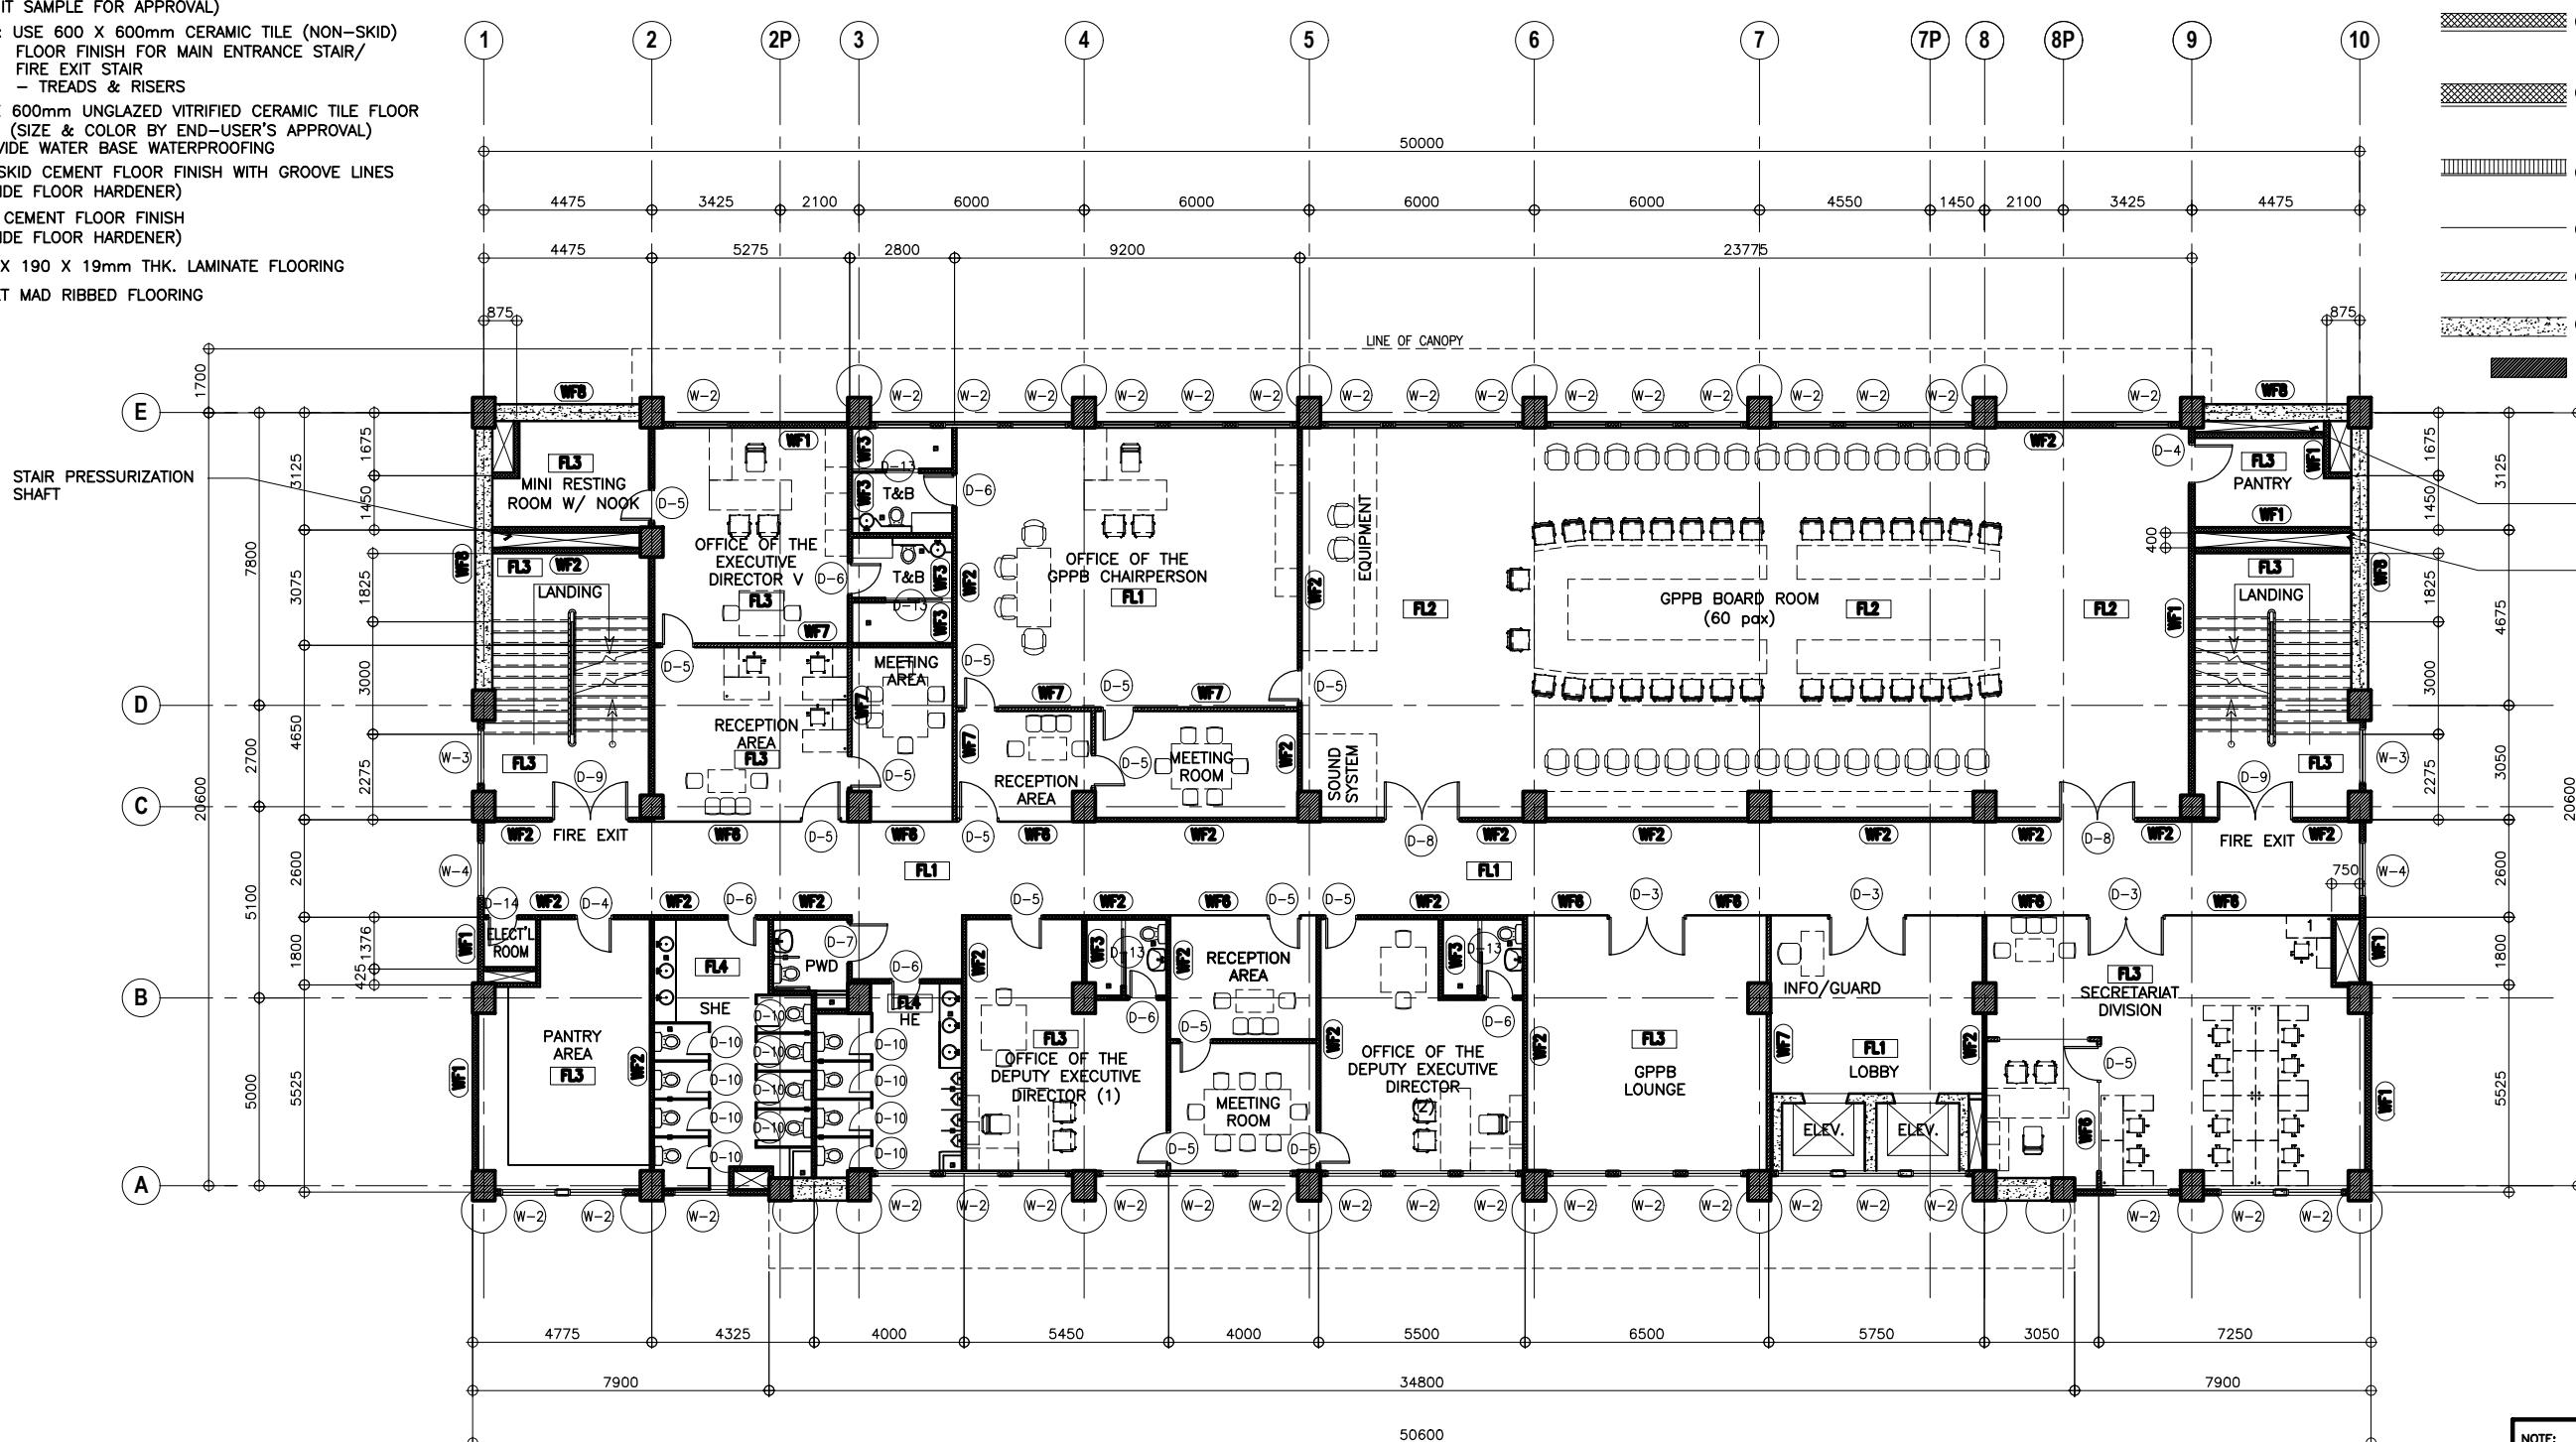

NOTE:
PURSUANT TO SECTION 4 OF ANNEX "A" OF THE REVISED IMPLEMENTING RULES AND REGULATION OF RA. 9184, APPROVAL BY THE AUTHORIZED DPWH OFFICIALS OF DETAILED ENGINEERING SURVEYS AND DESIGN UNDERTAKEN BY CONSULTANTS NEITHER DIMINISHES THE RESPONSIBILITY OF THE LATTER FOR THE TECHNICAL INTEGRITY OF THE SURVEYS AND DESIGN NOR TRANSFER ANY PART OF THAT RESPONSIBILITY TO THE APPROVING OFFICIALS.

THE DESIGN CONSULTANT SHALL BE HELD FULLY RESPONSIBLE FOR THE FAILURE OF THE FACILITY/IES/STRUCTURES DUE TO FAULTY DESIGN EXCEPT FOR THE CHANGES MADE WITHOUT THE CONFORMITY OF THE CONSULTANTS.

1 FOURTH FLOOR PLAN
A-6 SCALE 1:100M

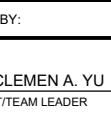


SCHEDULE OF FLOOR FINISHES:

- [FL1] 900 X 900mm POLISHED SYNTHETIC GRANITE TILE FLOOR FINISH
- [FL2] 600 X 600mm TEXTURED CERAMIC TILE (NON-SKID) FLOOR FINISH-OUTDOOR TYPE (SUBMIT SAMPLE FOR APPROVAL)
-PROVIDE WATER BASE WATERPROOFING FOR TERRACE
- [FL3] 600 X 600mm CERAMIC TILE FLOOR FINISH (SUBMIT SAMPLE FOR APPROVAL)
(NOTE: USE 600 X 600mm CERAMIC TILE (NON-SKID) FLOOR FINISH FOR MAIN ENTRANCE STAIR/FIRE EXIT STAIR
- TREADS & RISERS)
- [FL4] 600 X 600mm UNGLAZED VITRIFIED CERAMIC TILE FLOOR FINISH (SIZE & COLOR BY END-USER'S APPROVAL)
-PROVIDE WATER BASE WATERPROOFING
- [FL5] NON-SKID CEMENT FLOOR FINISH WITH GROOVE LINES (PROVIDE FLOOR HARDENER)
- [FL6] PLAIN CEMENT FLOOR FINISH (PROVIDE FLOOR HARDENER)
- [FL7] 1820 X 190 X 19mm THK. LAMINATE FLOORING
- [FL8] CARPET MAD RIBBED FLOORING

SCHEDULE OF WALL FINISHES:


- [WF1] 150mm THK. CHB W/ PLAIN CEMENT PLASTER (PAINTED FINISH)
 - [WF2] 100mm THK. CHB W/ PLAIN CEMENT PLASTER (PAINTED FINISH)
 - [WF3] 100mm THK. CHB W/ 600x600mm VITRIFIED WALL TILES (GLAZED)
 - [WF4] 150mm THK. CHB W/ 600x600mm VITRIFIED WALL TILES (GLAZED)
 - [WF5] 100mm THK. CHB W/ 1820x190x19mm THK. WALL PANELS
 - [WF6] 12mm THK. TEMPERED GLASS
 - [WF7] DRYWALL PAINTED FINISH
 - [WF8] REINFORCED CONCRETE WALL
- REINFORCED CONCRETE COLUMN

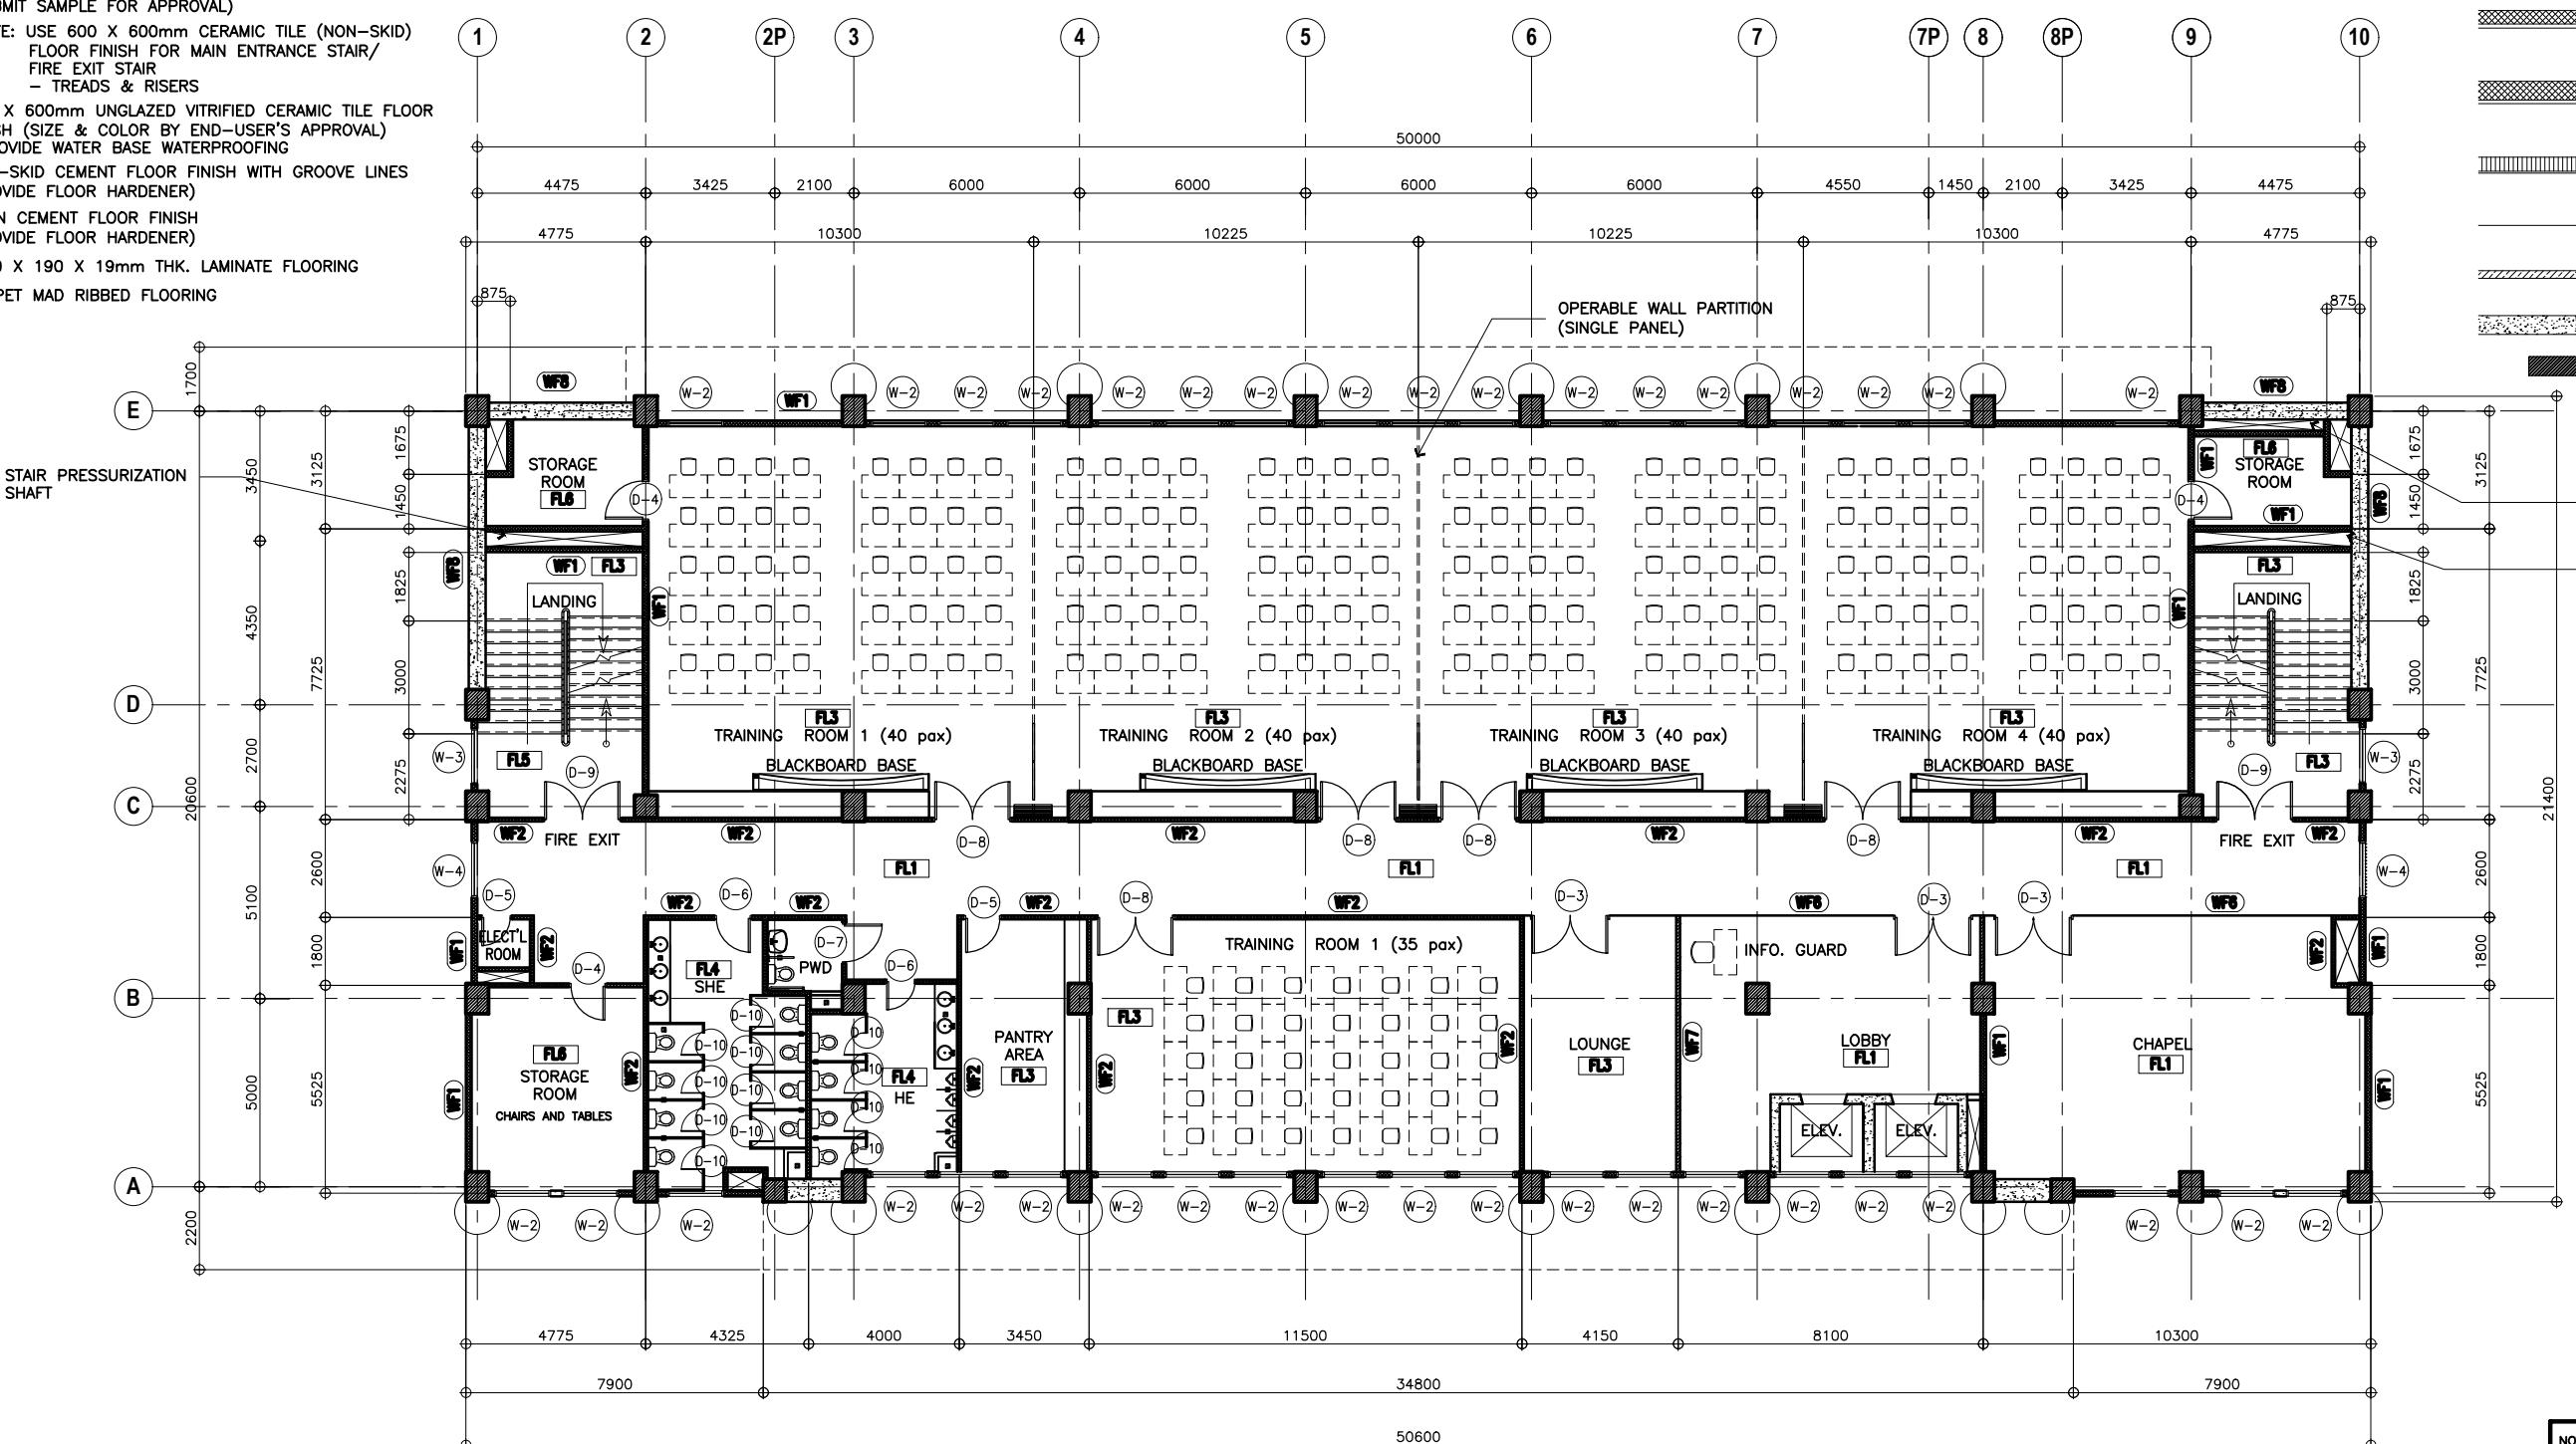

1 FIFTH FLOOR PLAN
A-7 SCALE 1:100M

NOTE:
PURSUANT TO SECTION 4 OF ANNEX "A" OF THE REVISED IMPLEMENTING RULES AND REGULATION OF R.A. 9184, APPROVAL BY THE AUTHORIZED DPWH OFFICIALS OF DETAILED ENGINEERING SURVEYS AND DESIGN UNDERTAKEN BY CONSULTANTS NEITHER DIMINISHES THE RESPONSIBILITY OF THE LATTER FOR THE TECHNICAL INTEGRITY OF THE SURVEYS AND DESIGN NOR TRANSFER ANY PART OF THAT RESPONSIBILITY TO THE APPROVING OFFICIALS.

THE DESIGN CONSULTANT SHALL BE HELD FULLY RESPONSIBLE FOR THE FAILURE OF THE FACILITY/IES/STRUCTURES DUE TO FAULTY DESIGN EXCEPT FOR THE CHANGES MADE WITHOUT THE CONFORMITY OF THE CONSULTANTS.

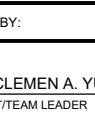


SCHEDULE OF FLOOR FINISHES:

- [FL1] 900 x 900mm POLISHED SYNTHETIC GRANITE TILE FLOOR FINISH
- [FL2] 600 x 600mm TEXTURED CERAMIC TILE (NON-SKID) FLOOR FINISH-OUTDOOR TYPE (SUBMIT SAMPLE FOR APPROVAL)
-PROVIDE WATER BASE WATERPROOFING FOR TERRACE
- [FL3] 600 x 600mm CERAMIC TILE FLOOR FINISH (SUBMIT SAMPLE FOR APPROVAL)
(NOTE: USE 600 x 600mm CERAMIC TILE (NON-SKID) FLOOR FINISH FOR MAIN ENTRANCE STAIR/FIRE EXIT STAIR - TREADS & RISERS)
- [FL4] 600 x 600mm UNGLAZED VITRIFIED CERAMIC TILE FLOOR FINISH (SIZE & COLOR BY END-USER'S APPROVAL)
-PROVIDE WATER BASE WATERPROOFING
- [FL5] NON-SKID CEMENT FLOOR FINISH WITH GROOVE LINES (PROVIDE FLOOR HARDENER)
- [FL6] PLAIN CEMENT FLOOR FINISH (PROVIDE FLOOR HARDENER)
- [FL7] 1820 X 190 X 19mm THK. LAMINATE FLOORING
- [FL8] CARPET MAD RIBBED FLOORING

SCHEDULE OF WALL FINISHES:

- [WF1] 150mm THK. CHB W/ PLAIN CEMENT PLASTER (PAINTED FINISH)
 - [WF2] 100mm THK. CHB W/ PLAIN CEMENT PLASTER (PAINTED FINISH)
 - [WF3] 100mm THK. CHB W/ 600x600mm VITRIFIED WALL TILES (GLAZED)
 - [WF4] 150mm THK. CHB W/ 600x600mm VITRIFIED WALL TILES (GLAZED)
 - [WF5] 100mm THK. CHB W/ 1820x190x19mm THK. WALL PANELS
 - [WF6] 12mm THK. TEMPERED GLASS
 - [WF7] DRYWALL PAINTED FINISH
 - [WF8] REINFORCED CONCRETE WALL
- REINFORCED CONCRETE COLUMN

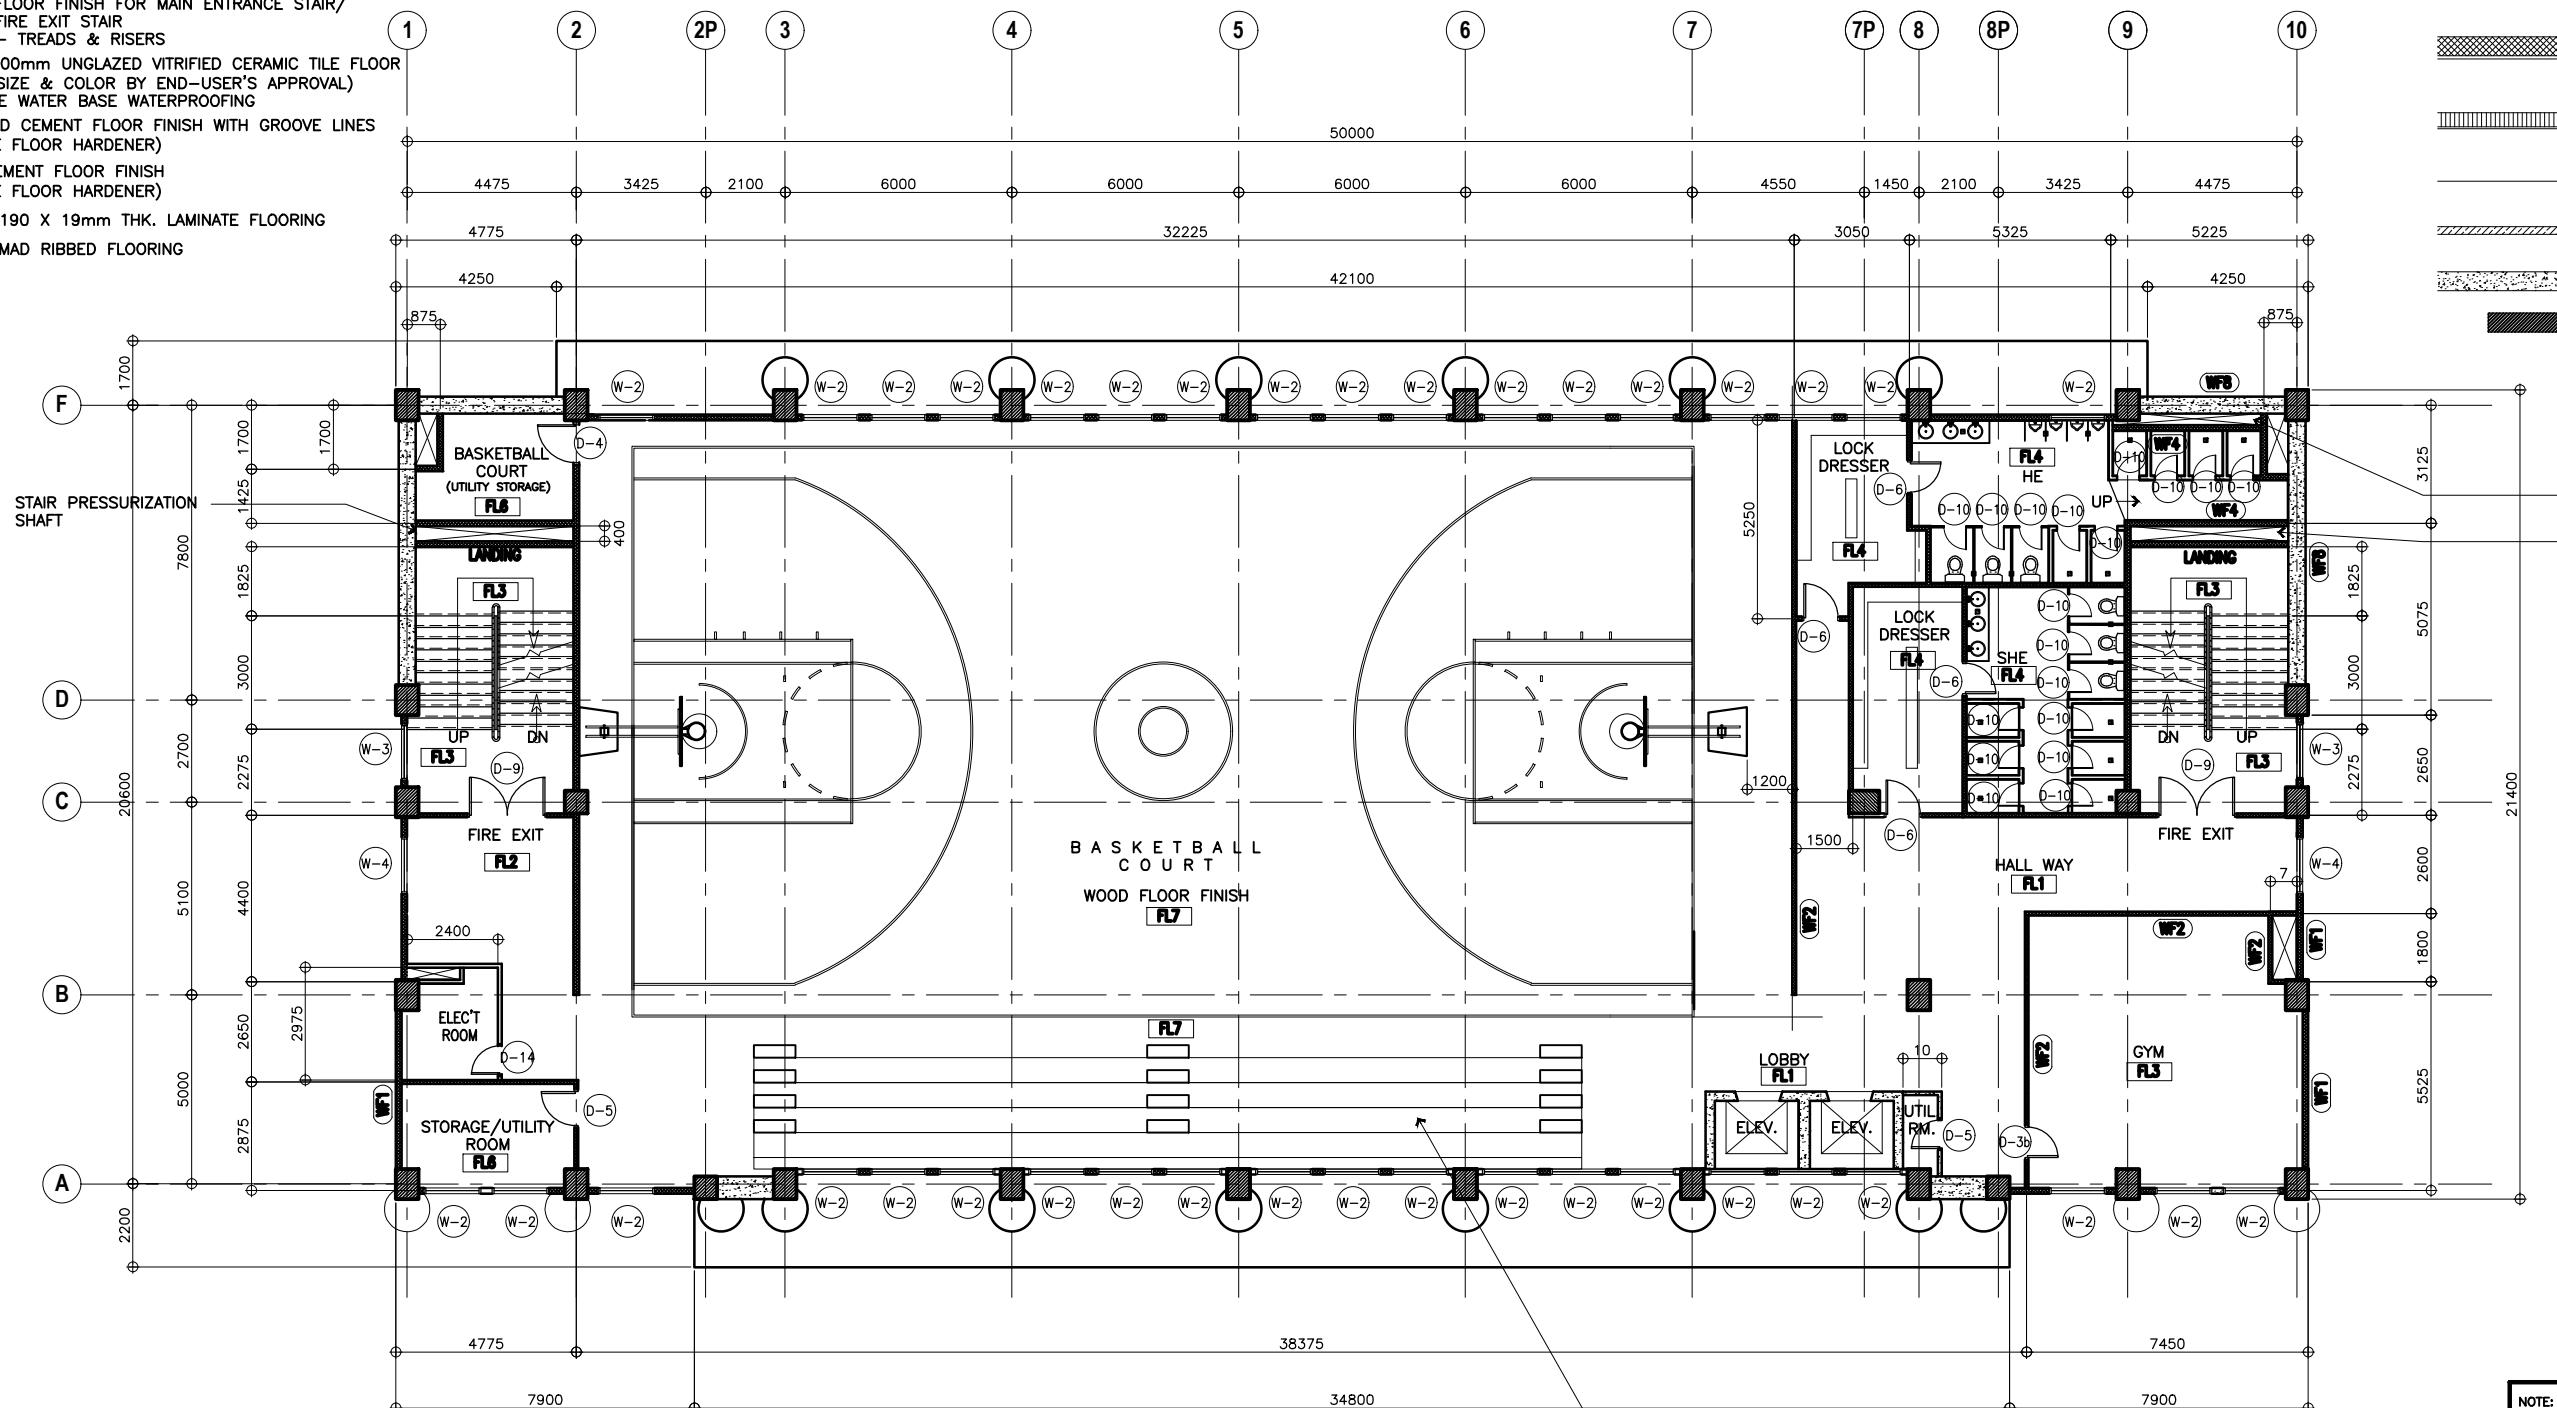

NOTE: PURSUANT TO SECTION 4 OF ANNEX "A" OF THE REVISED IMPLEMENTING RULES AND REGULATION OF RA. 9184, APPROVAL BY THE AUTHORIZED DPWH OFFICIALS OF DETAILED ENGINEERING SURVEYS AND DESIGN UNDERTAKEN BY CONSULTANTS NEITHER DIMINISHES THE RESPONSIBILITY OF THE LATTER FOR THE TECHNICAL INTEGRITY OF THE SURVEYS AND DESIGN NOR TRANSFER ANY PART OF THAT RESPONSIBILITY TO THE APPROVING OFFICIALS.

THE DESIGN CONSULTANT SHALL BE HELD FULLY RESPONSIBLE FOR THE FAILURE OF THE FACILITY/IES/STRUCTURES DUE TO FAULTY DESIGN EXCEPT FOR THE CHANGES MADE WITHOUT THE CONFORMITY OF THE CONSULTANTS.

1 SEVENTH FLOOR PLAN
A-9 SCALE 1:100M



PREPARED BY:
ARMAN U. CUEVAS
ARCHITECTURAL DESIGN POSITION: ARCHITECT
PRC No.: 0018676 TIN No.: 907-359-364 PTR No.: 4020896

SUBMITTED BY:
CYNTHIA CLEMEN A. YU
ARCHITECT/TEAM LEADER



REPUBLIC OF THE PHILIPPINES
DEPARTMENT OF PUBLIC WORKS AND HIGHWAYS
BUREAU OF DESIGN
BUILDINGS DIVISION
BONIFACIO DRIVE PORT AREA, MANILA

REVIEWED AS TO DESIGN CONCEPT:
JOSEPHINE P. ISTURIS
CHIEF, BUILDINGS DIVISION, BOD

RECOMMENDING APPROVAL:
(SEE COVER SHEET)
LEA N. DELFINADO, CESO IV
OFFICER-IN-CHARGE

APPROVED:
(SEE COVER SHEET)
EMIL K. SADAIN, CESO I
UNDERSECRETARY FOR UPMO OPERATIONS & TECHNICAL SERVICES

CONCURRED:
(SEE COVER SHEET)
ROWENA CANDICE M. RUIZ
EXECUTIVE DIRECTOR

PROJECT & LOCATION / BARANGAY:
PROPOSED:
PROPOSED SEVEN (7) STOREY GOVERNMENT PROCUREMENT POLICY BOARD (GPPB)
UP DILIMAN COMPOUND, DILIMAN, QUEZON CITY

Sheet Contents:
SEVENTH FLOOR PLAN


SET NO.
BOD-A-9
11
216

SCHEDULE OF FLOOR FINISHES:

- FL1 900 x 900mm POLISHED SYNTHETIC GRANITE TILE FLOOR FINISH
- FL2 600 x 600mm TEXTURED CERAMIC TILE (NON-SKID) FLOOR FINISH-OUTDOOR TYPE (SUBMIT SAMPLE FOR APPROVAL)
-PROVIDE WATER BASE WATERPROOFING FOR TERRACE
- FL3 600 x 600mm CERAMIC TILE FLOOR FINISH (SUBMIT SAMPLE FOR APPROVAL)
(NOTE: USE 600 X 600mm CERAMIC TILE (NON-SKID) FLOOR FINISH FOR MAIN ENTRANCE STAIR/FIRE EXIT STAIR - TREADS & RISERS)
- FL4 600 x 600mm UNGLAZED VITRIFIED CERAMIC TILE FLOOR FINISH (SIZE & COLOR BY END-USER'S APPROVAL)
-PROVIDE WATER BASE WATERPROOFING
- FL5 NON-SKID CEMENT FLOOR FINISH WITH GROOVE LINES (PROVIDE FLOOR HARDENER)
- FL6 PLAIN CEMENT FLOOR FINISH (PROVIDE FLOOR HARDENER)
- FL7 1820 X 190 X 19mm THK. LAMINATE FLOORING
- FL8 CARPET MAD RIBBED FLOORING

SCHEDULE OF WALL FINISHES:

- WF1 100mm THK. CHB W/ PLAIN CEMENT PLASTER (PAINTED FINISH)
 - WF2 100mm THK. CHB W/ PLAIN CEMENT PLASTER (PAINTED FINISH)
 - WF3 100mm THK. CHB W/ 600x600mm VITRIFIED WALL TILES (GLAZED)
 - WF4 150mm THK. CHB W/ 600x600mm VITRIFIED WALL TILES (GLAZED)
 - WF5 100mm THK. CHB W/ 1820x190x19mm THK. WALL PANELS
 - WF6 12mm THK. TEMPERED GLASS
 - WF7 DRYWALL PAINTED FINISH
 - WF8 REINFORCED CONCRETE WALL
- REINFORCED CONCRETE COLUMN

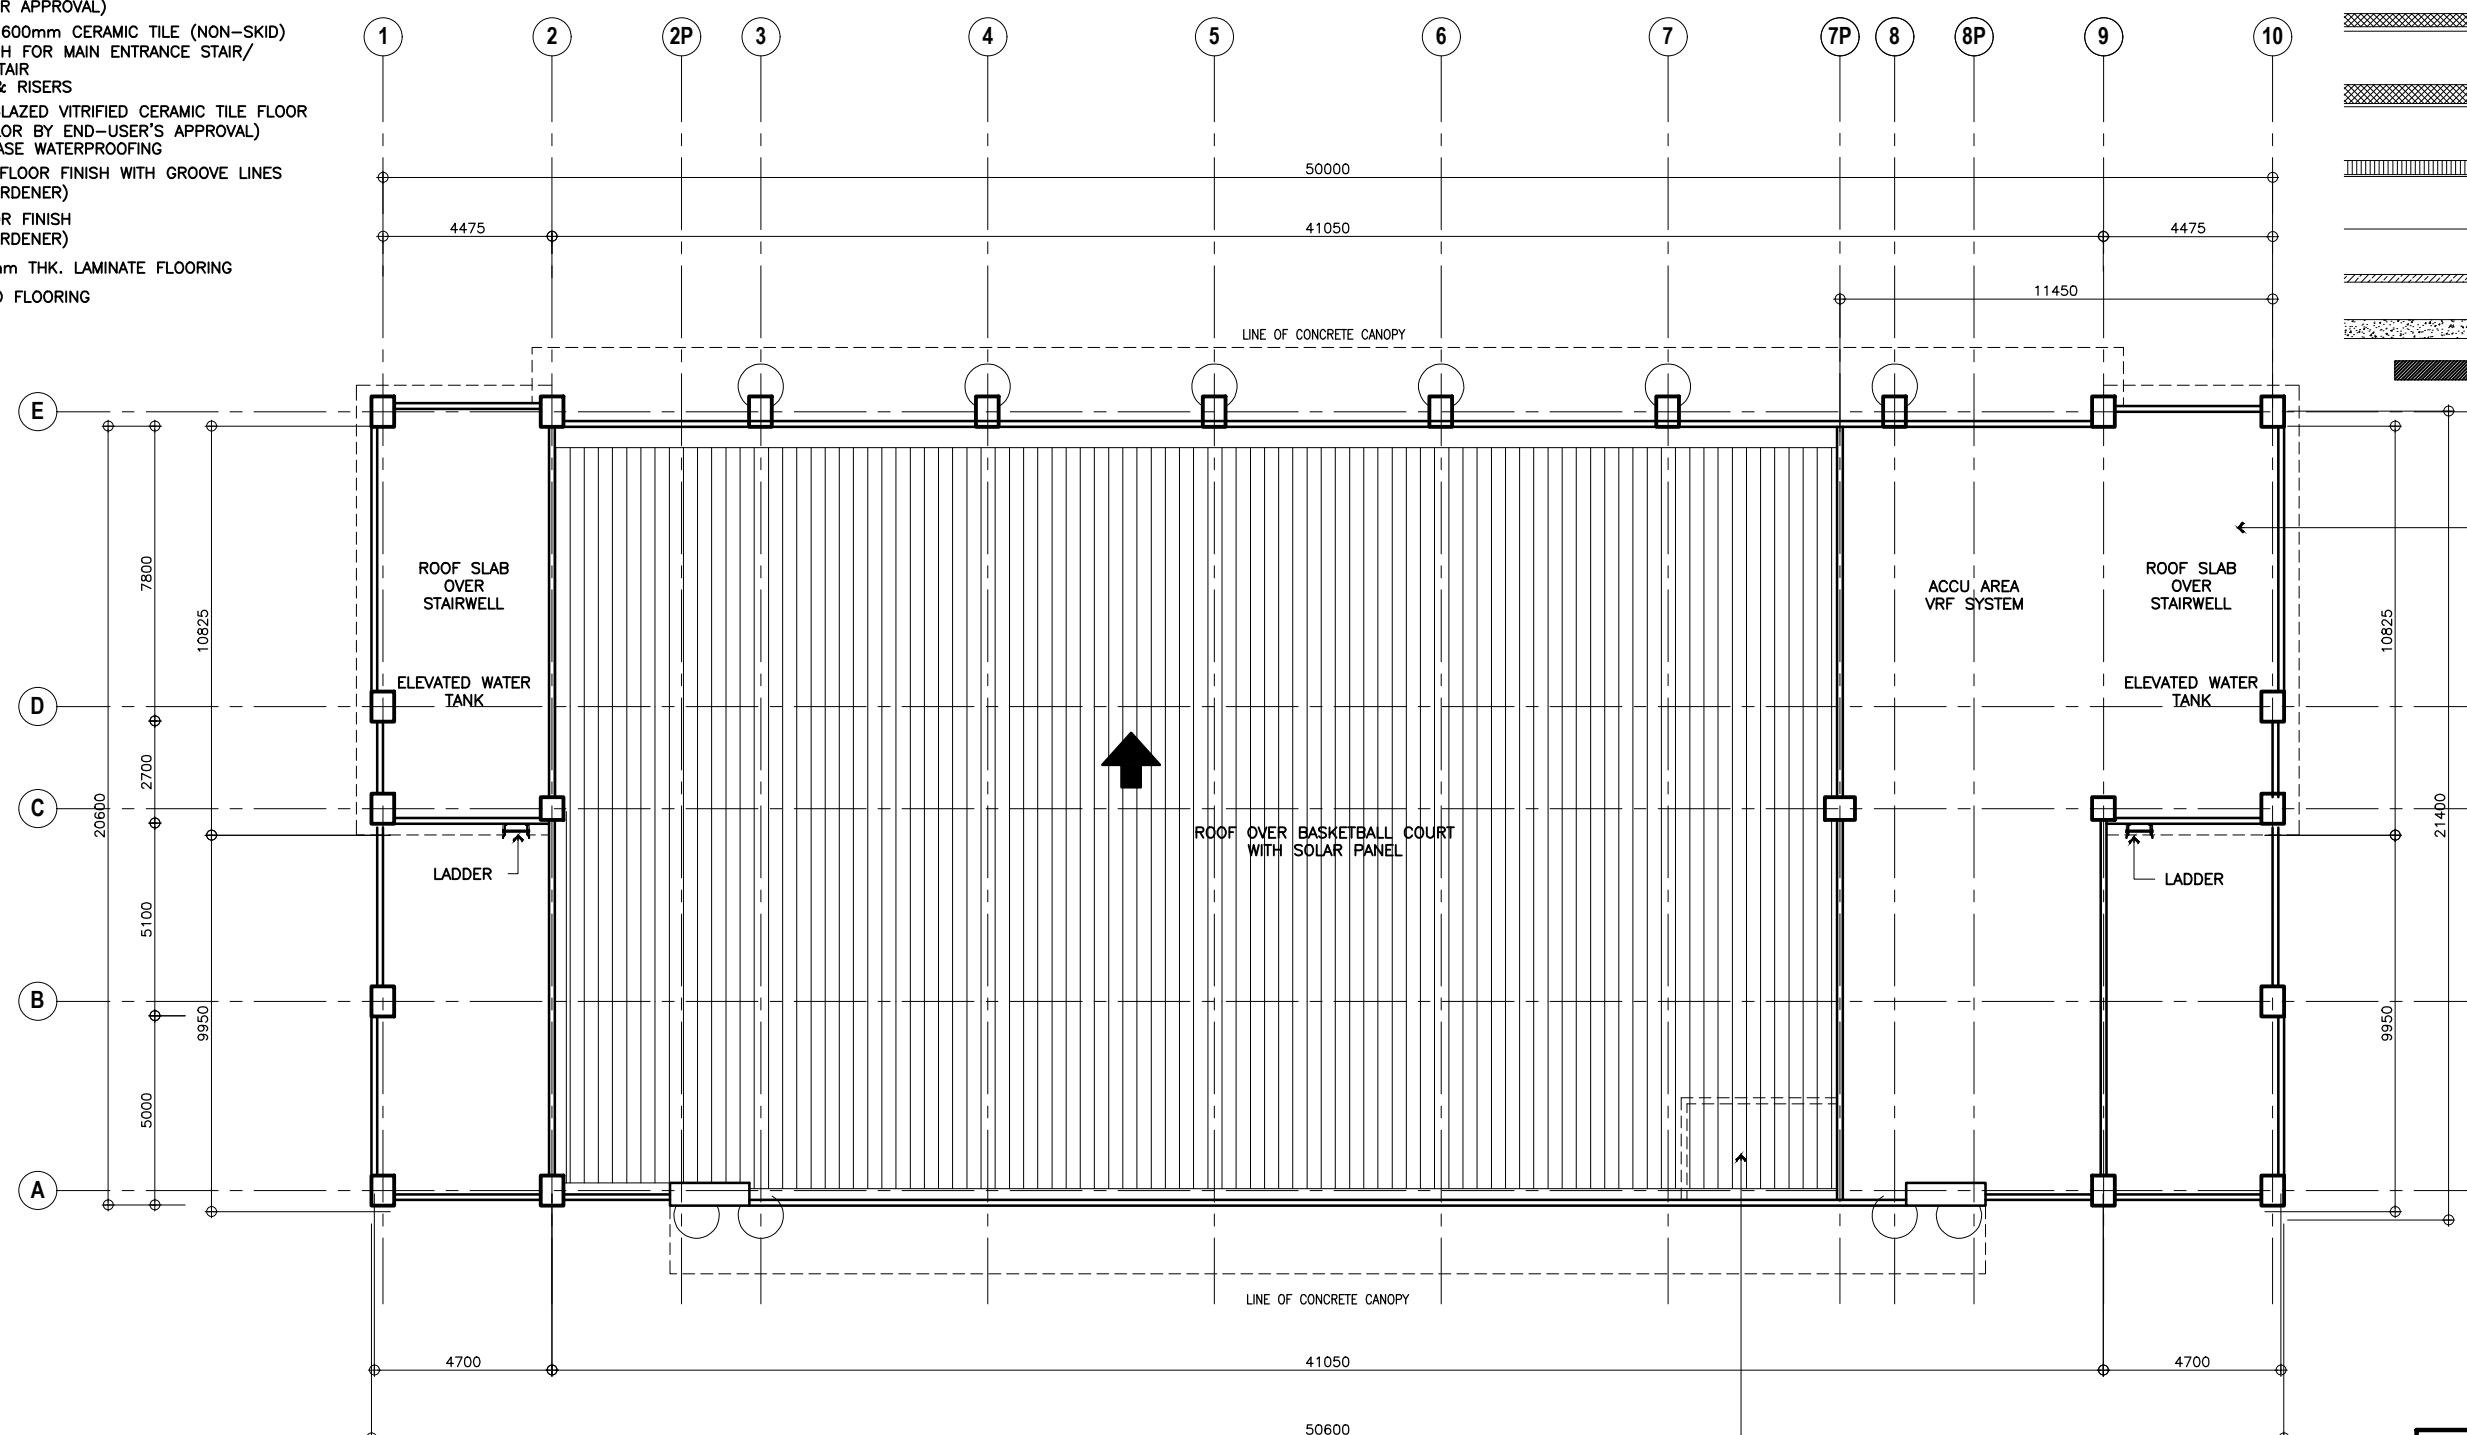



0.40mm THICK (BASE METAL THICKNESS) LONG SPAN
PRE-PAINTED G.I. ROOFING
SHEETS WITH TOTAL COATED THICKNESS
OF 0.43-0.45mm THICK. (RIB TYPE)

NOTE:
PURSUANT TO SECTION 4 OF ANNEX "A" OF THE
REVISED IMPLEMENTING RULES AND REGULATION OF RA. 9184,
APPROVAL BY THE AUTHORIZED DPWH OFFICIALS OF DETAILED
ENGINEERING SURVEYS AND DESIGN UNDERTAKEN BY CONSULTANTS
NEITHER DIMINISHES THE RESPONSIBILITY OF THE LATTER
FOR THE TECHNICAL INTEGRITY OF THE SURVEYS AND DESIGN
NOR TRANSFER ANY PART OF THAT RESPONSIBILITY TO THE
APPROVING OFFICIALS.

THE DESIGN CONSULTANT SHALL BE HELD FULLY RESPONSIBLE
FOR THE FAILURE OF THE FACILITY/IES/STRUCTURES
DUE TO FAULTY DESIGN EXCEPT FOR THE CHANGES MADE
WITHOUT THE CONFORMITY OF THE CONSULTANTS.

1 ROOF PLAN
A-11 SCALE 1:100M

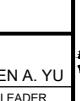

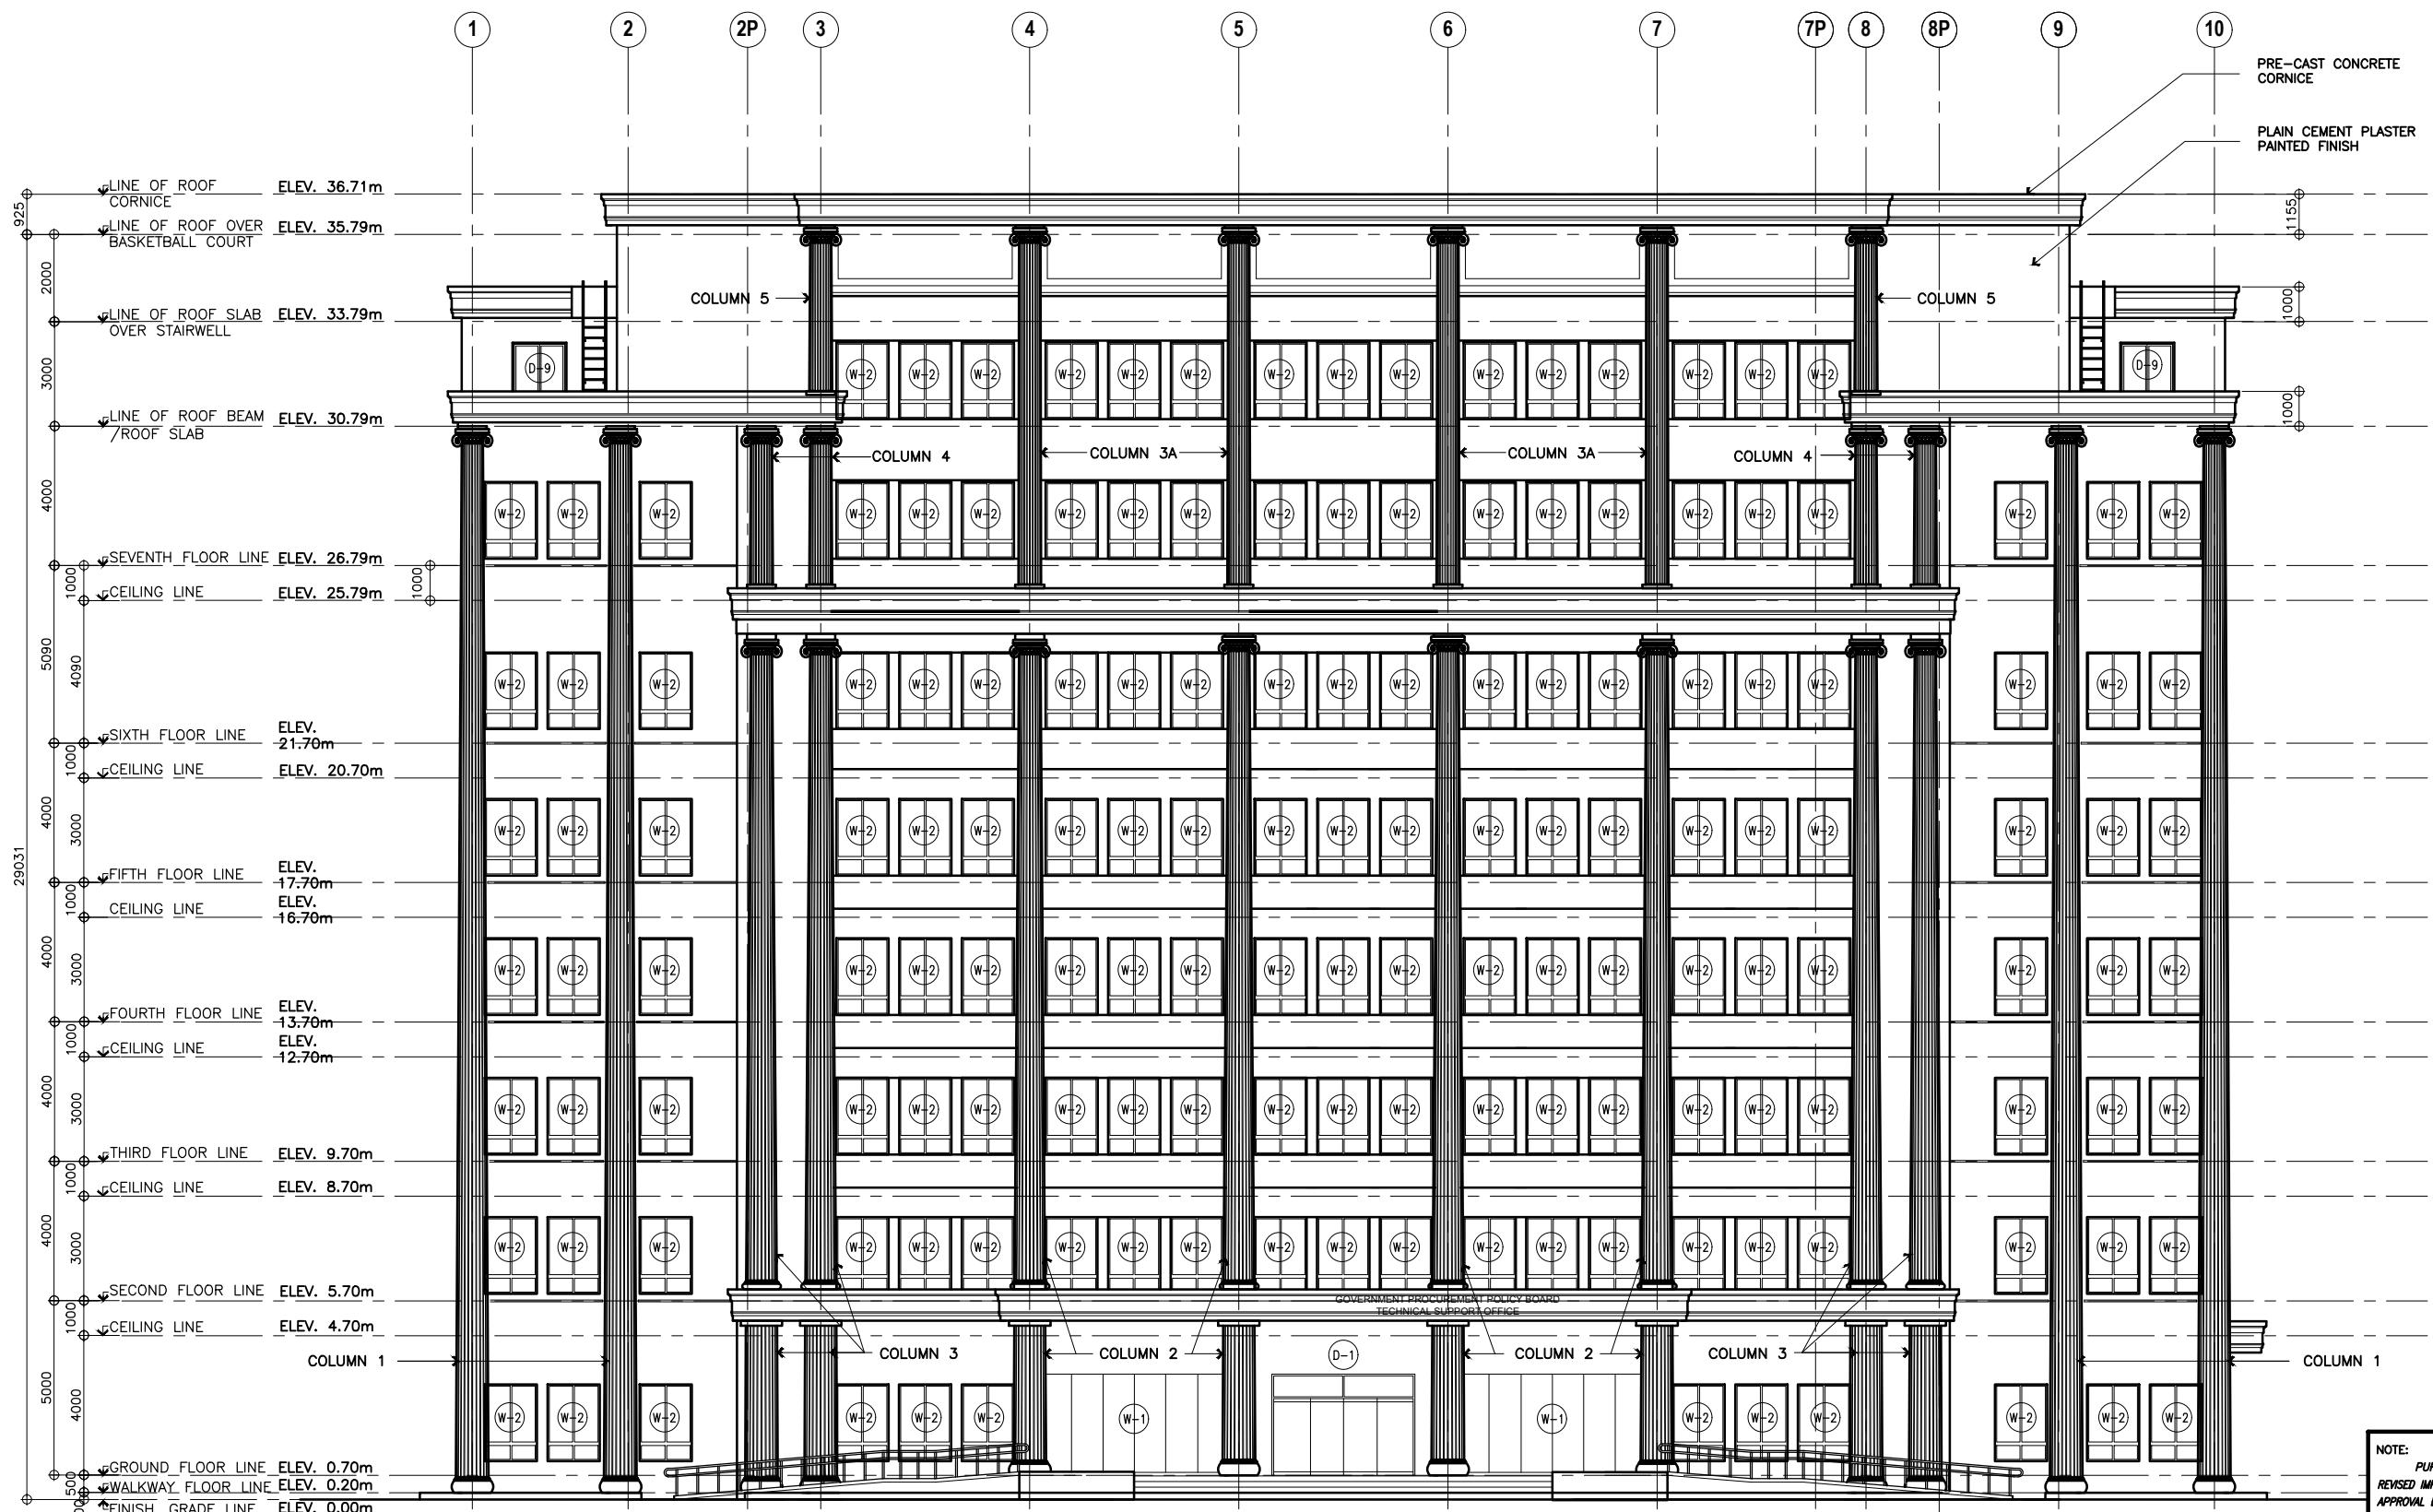


FRONT ELEVATION


**PURSUANT TO SECTION 4 OF ANNEX "A" OF THE
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APPROVAL BY THE AUTHORIZED DPWH OFFICIALS OF DETAILED
ENGINEERING SURVEYS AND DESIGN UNDERTAKEN BY CONSULTANTS
NEITHER DIMINISHES THE RESPONSIBILITY OF THE LATTER
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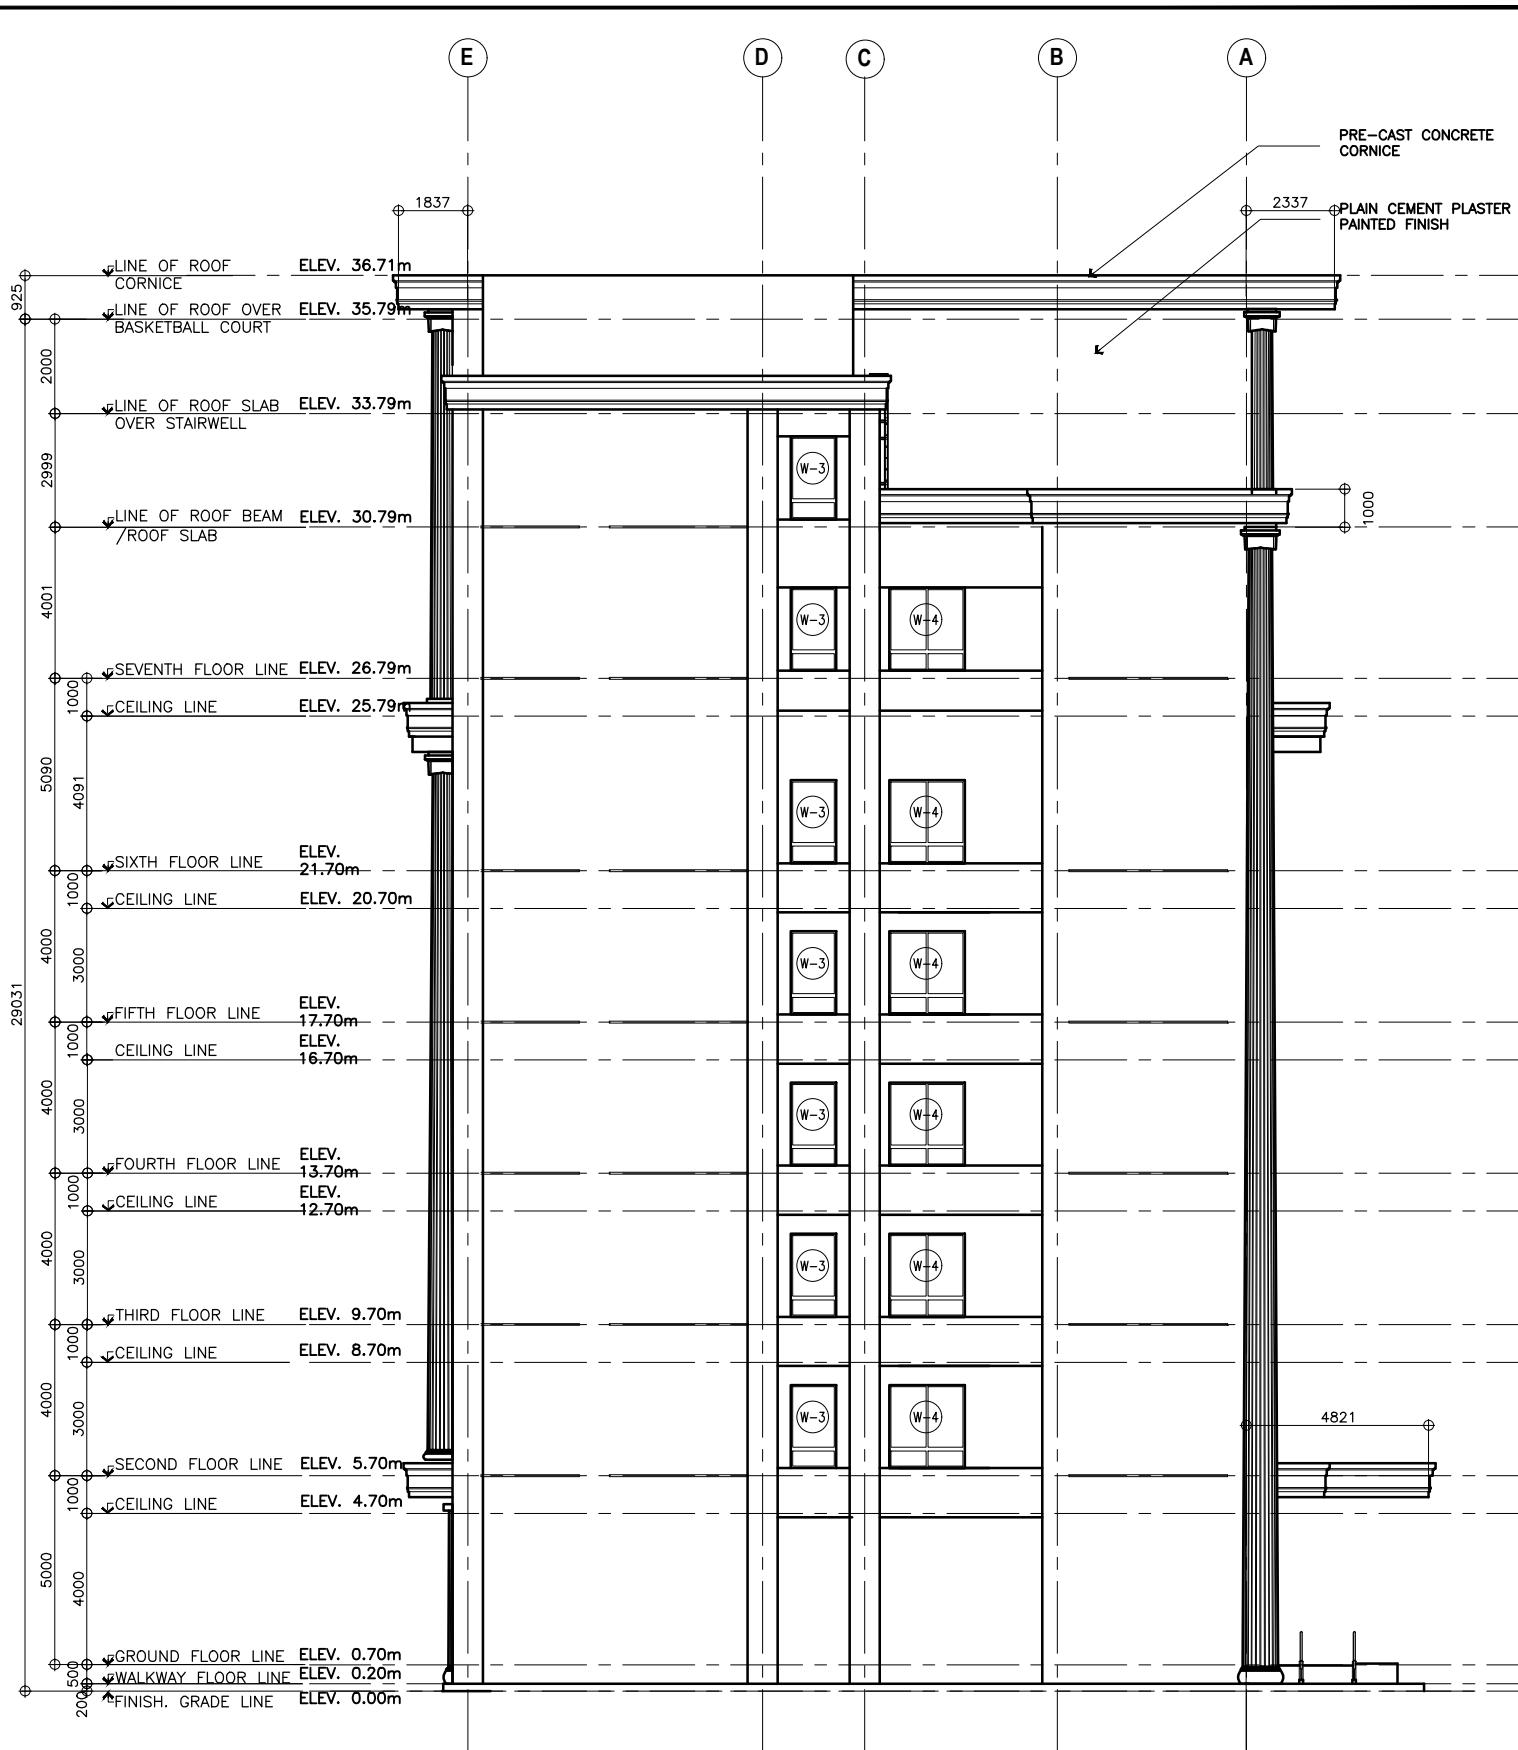
UNITED TECHNOLOGIES CONSOLIDATED PARTNERSHIP	PREPARED BY:	SUBMITTED BY:	REPUBLIC OF THE PHILIPPINES DEPARTMENT OF PUBLIC WORKS AND HIGHWAYS BUREAU OF DESIGN BUILDINGS DIVISION BONIFACIO DRIVE PORT AREA, MANILA	REVIEWED AS TO DESIGN CONCEPT:	RECOMMENDING APPROVAL:	APPROVED:	CONCURRED:	PROJECT & LOCATION / BARANGAY:	SHEET CONTENTS:	SET NO.	SHEET NO.
	ARMAN U. CUEVAS	CYNTHIA CLEMEN A. YU		(SEE COVER SHEET)	(SEE COVER SHEET)	(SEE COVER SHEET)	(SEE COVER SHEET)	PROPOSED:	PROPOSED SEVEN (7) STOREY GOVERNMENT PROCUREMENT POLICY BOARD (GPPB)	BOD A-12	14
	ARCHITECTURAL DESIGN POSITION: ARCHITECT PRC No.: 0018676 TIN No.: 907-359-364 PTR No.: 4020896	ARCHITECT/TEAM LEADER		JOSEPHINE P. ISTURIS	LEA N. DELFINADO, CESO IV	EMIL K. SADAIN, CESO I	ROWENA CANDICE M. RUIZ		UP DILIMAN COMPOUND, DILIMAN, QUEZON CITY		216
		CHIEF, BUILDINGS DIVISION, BOD		OFFICER-IN-CHARGE	UNDERSECRETARY FOR UPMO OPERATIONS & TECHNICAL SERVICES		EXECUTIVE DIRECTOR				



1 REAR ELEVATION
A-13 SCALE 1:100M

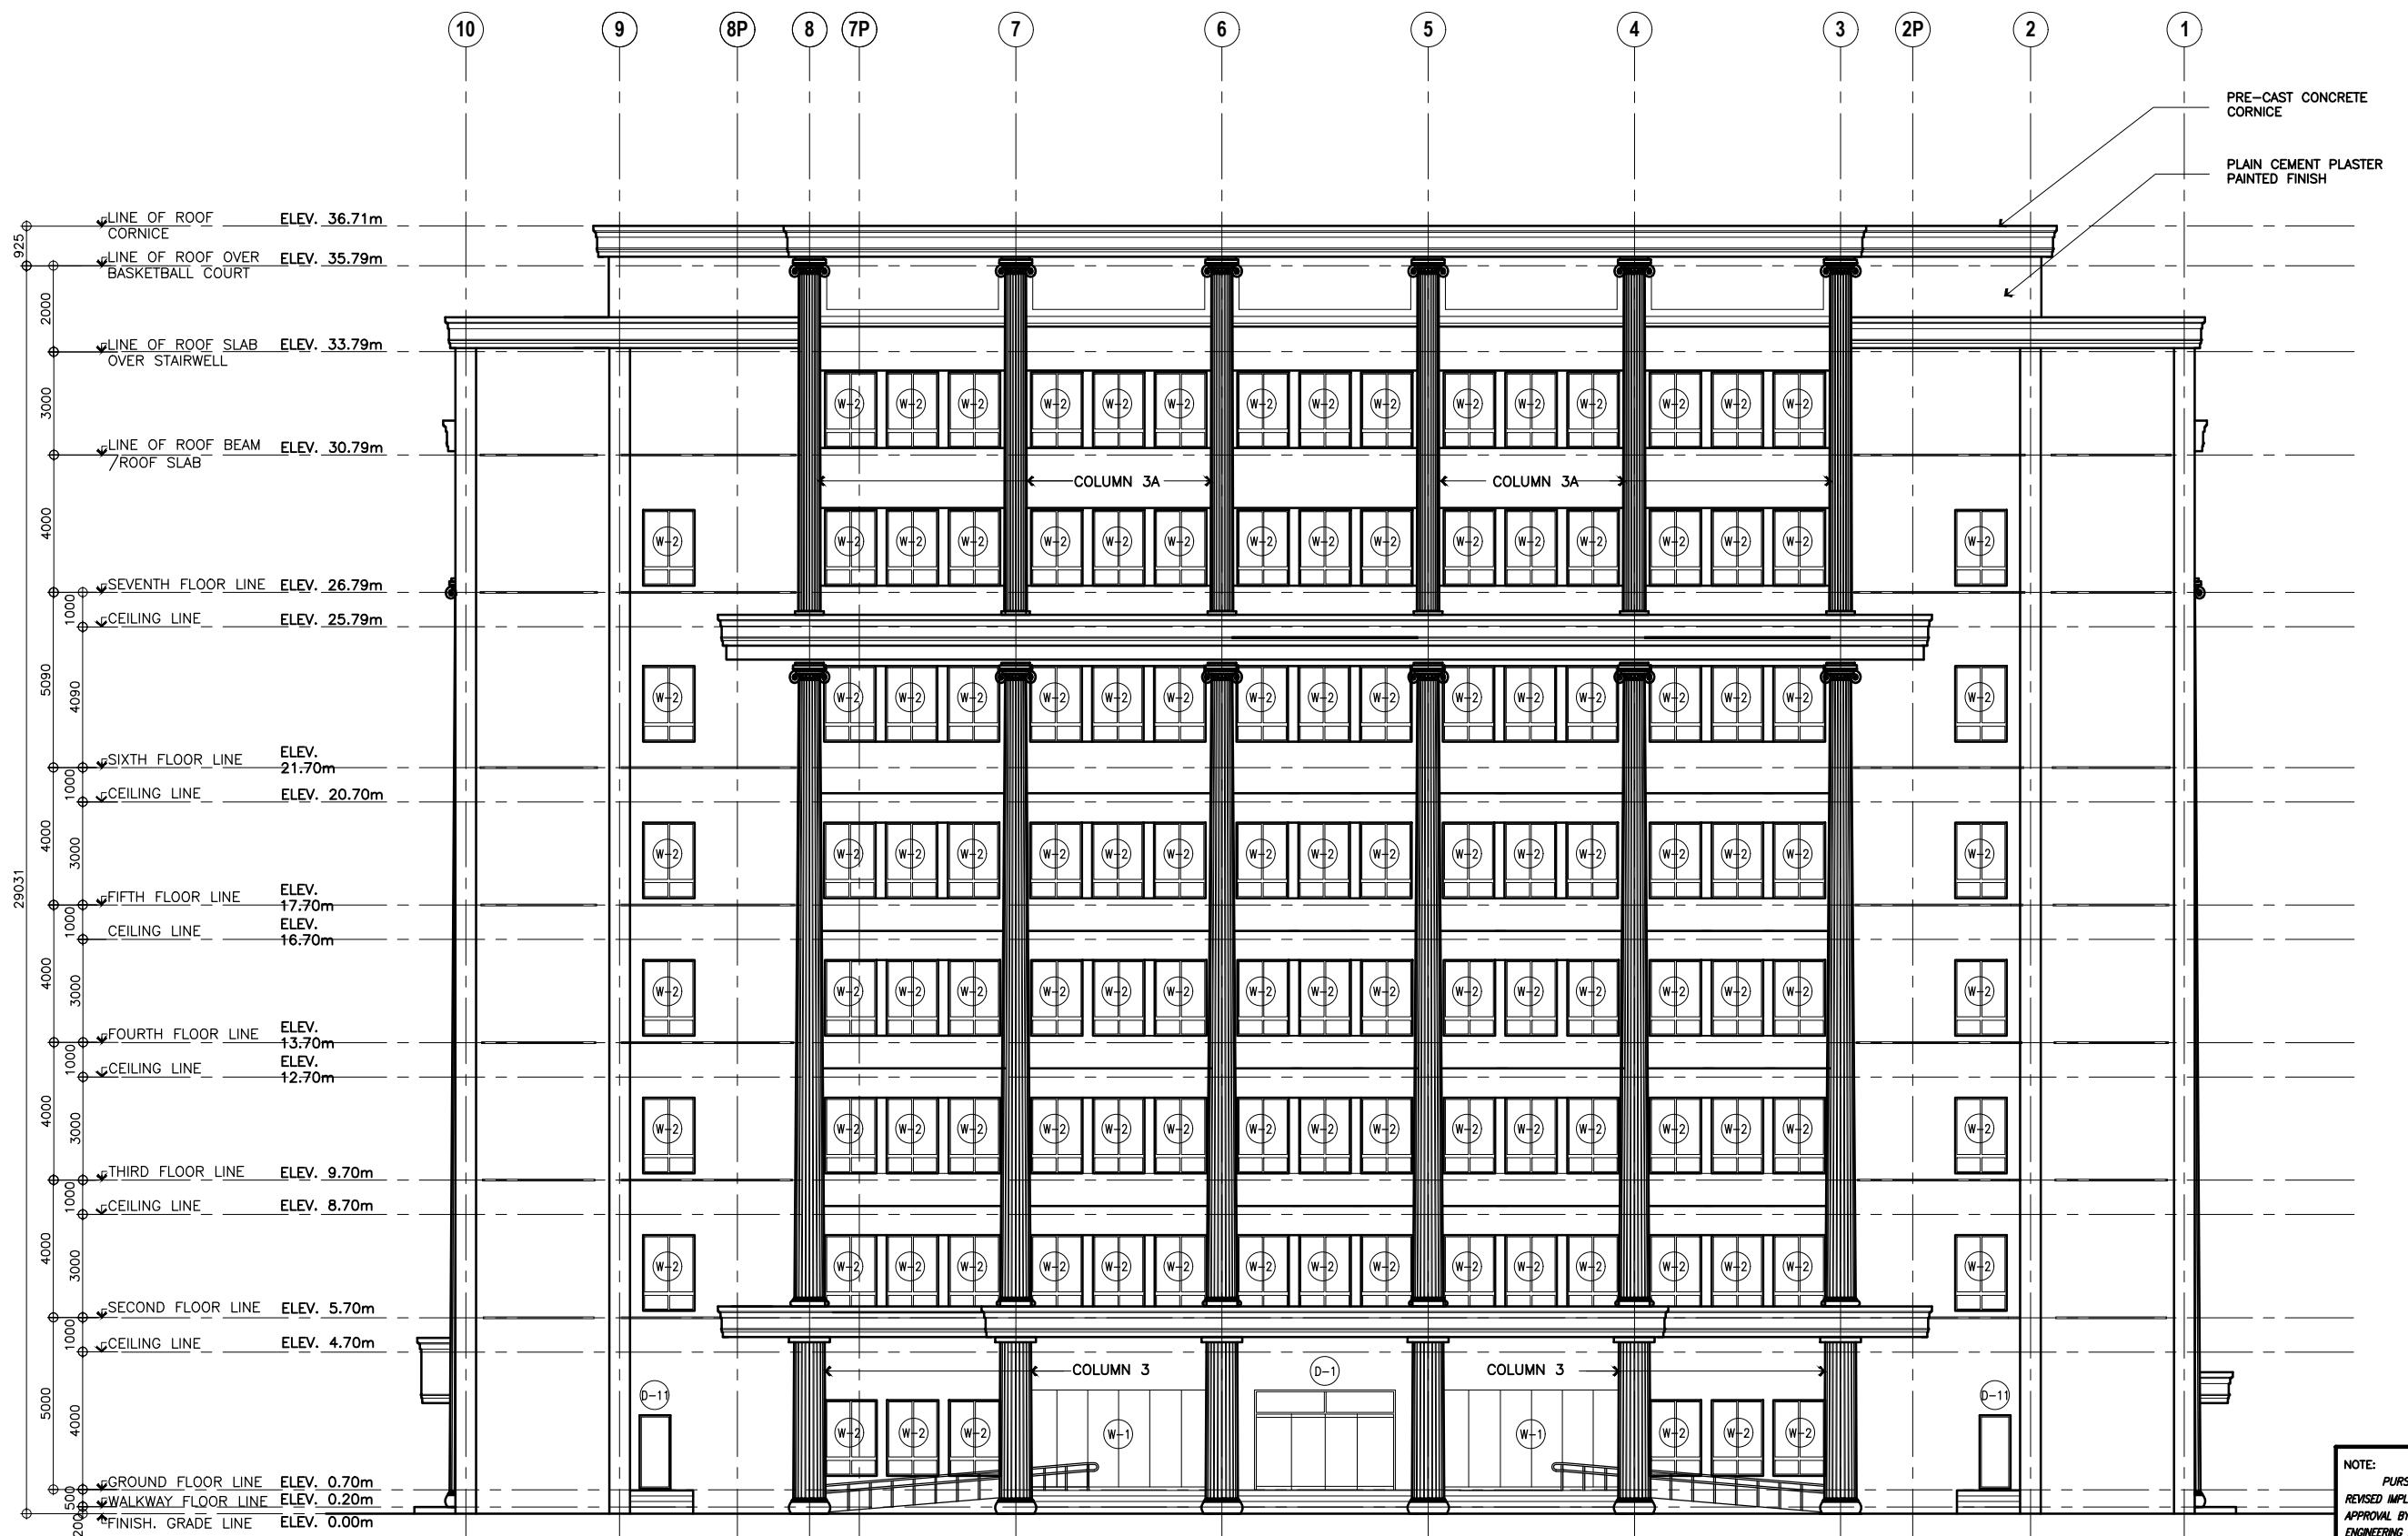




1 RIGHT SIDE ELEVATION
A-14 SCALE 1:100M

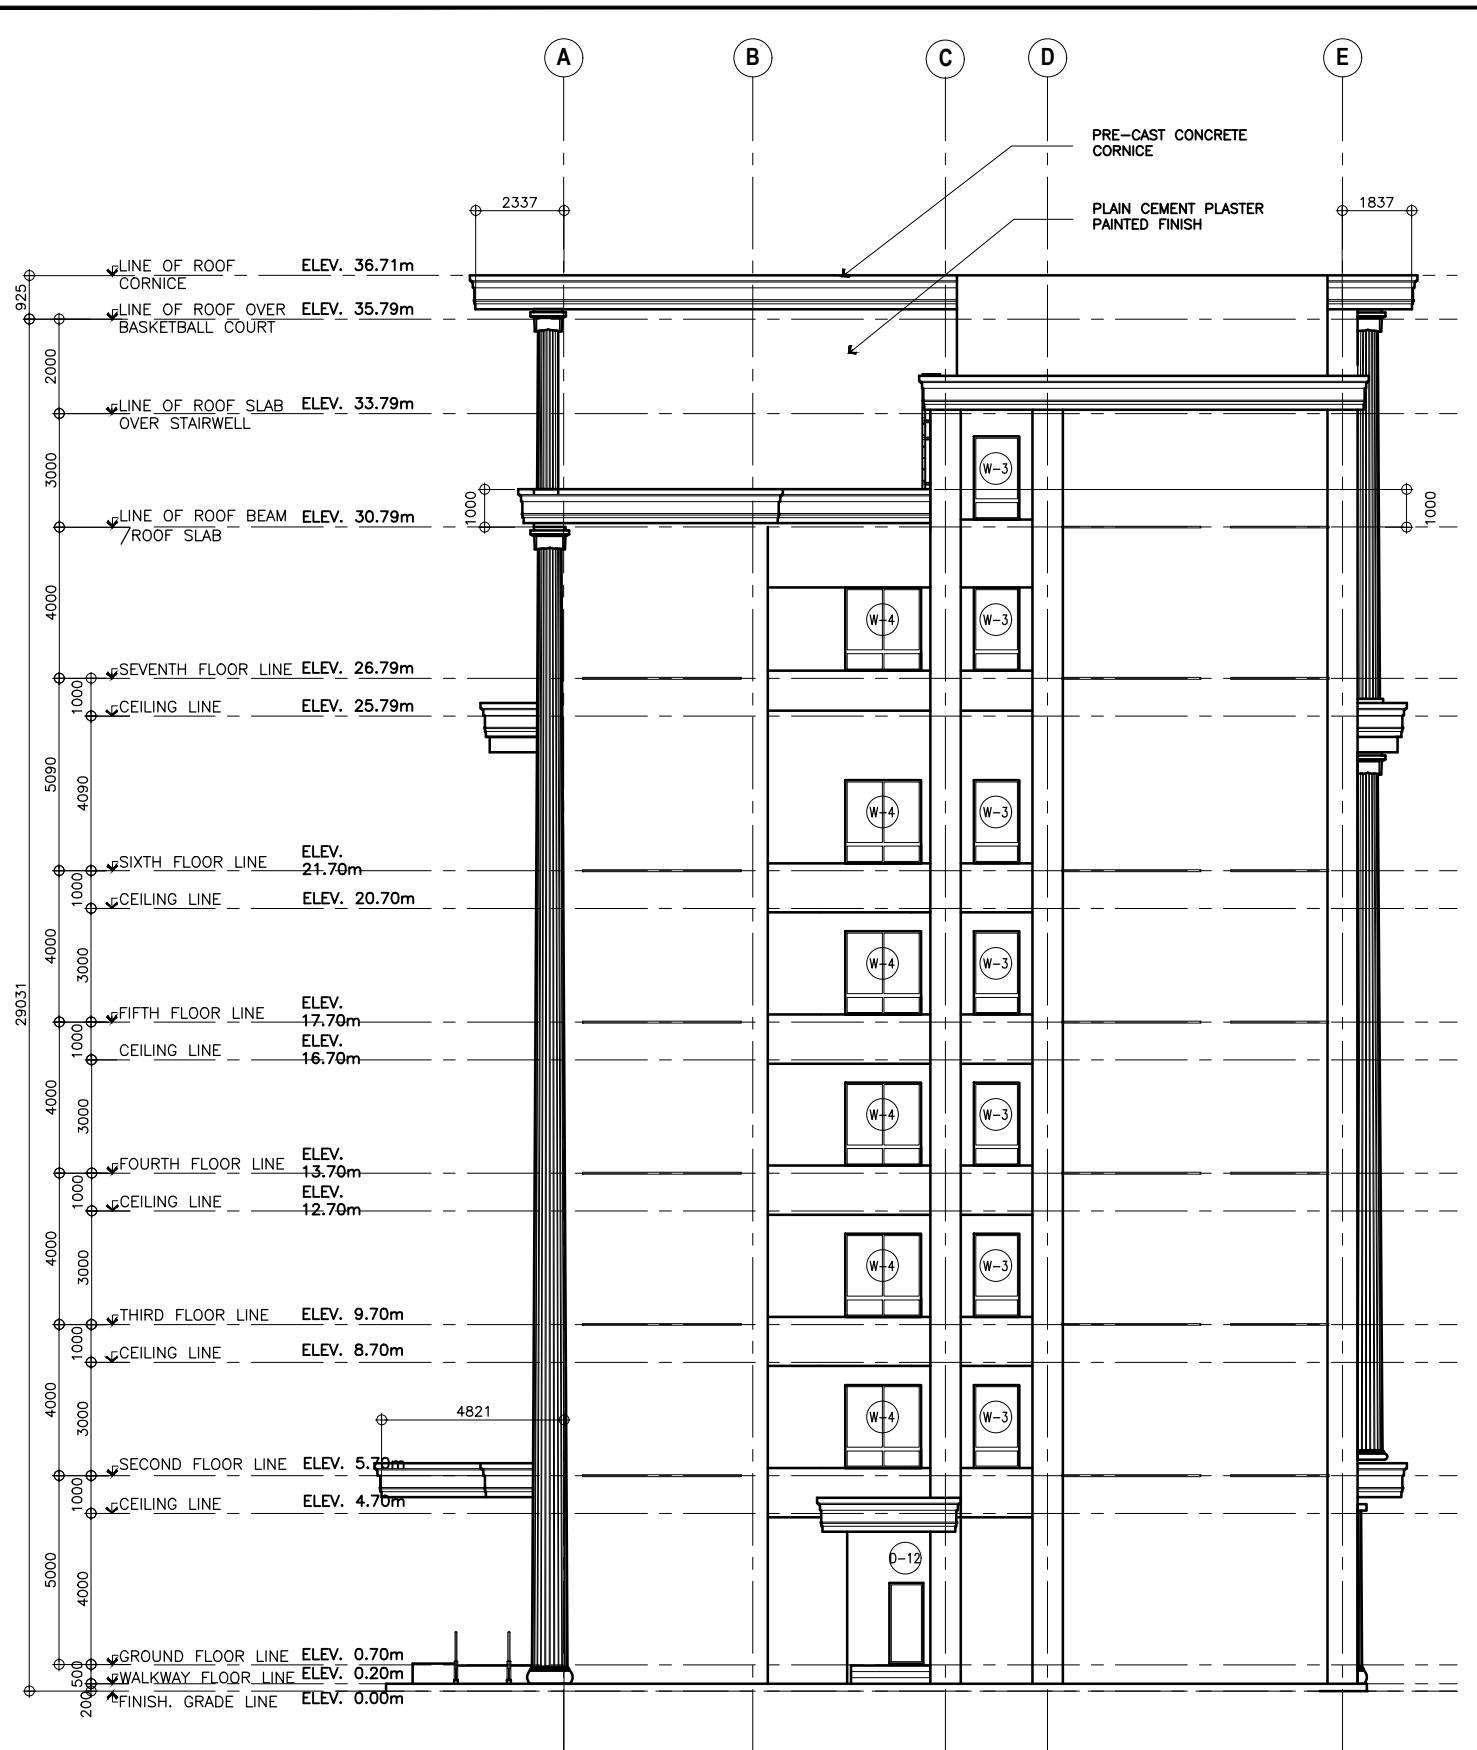

2 LEFT SIDE ELEVATION
A-14 SCALE 1:100M

UNITED TECHNOLOGIES CONSOLIDATED PARTNERSHIP	PREPARED BY:	SUBMITTED BY:	REPUBLIC OF THE PHILIPPINES DEPARTMENT OF PUBLIC WORKS AND HIGHWAYS BUREAU OF DESIGN BUILDINGS DIVISION BONIFACIO DRIVE PORT AREA, MANILA	REVIEWED AS TO DESIGN CONCEPT:	RECOMMENDING APPROVAL:	APPROVED:	CONCURRED:	PROJECT & LOCATION / BARANGAY:	SHEET CONTENTS:	SET NO.	SHEET NO.
										BOD A-14	16 216
								PROPOSED: PROPOSED SEVEN (7) STOREY GOVERNMENT PROCUREMENT POLICY BOARD (GPPB) UP DILIMAN COMPOUND, DILIMAN, QUEZON CITY		RIGHT SIDE ELEVATION, LEFT SIDE ELEVATION	

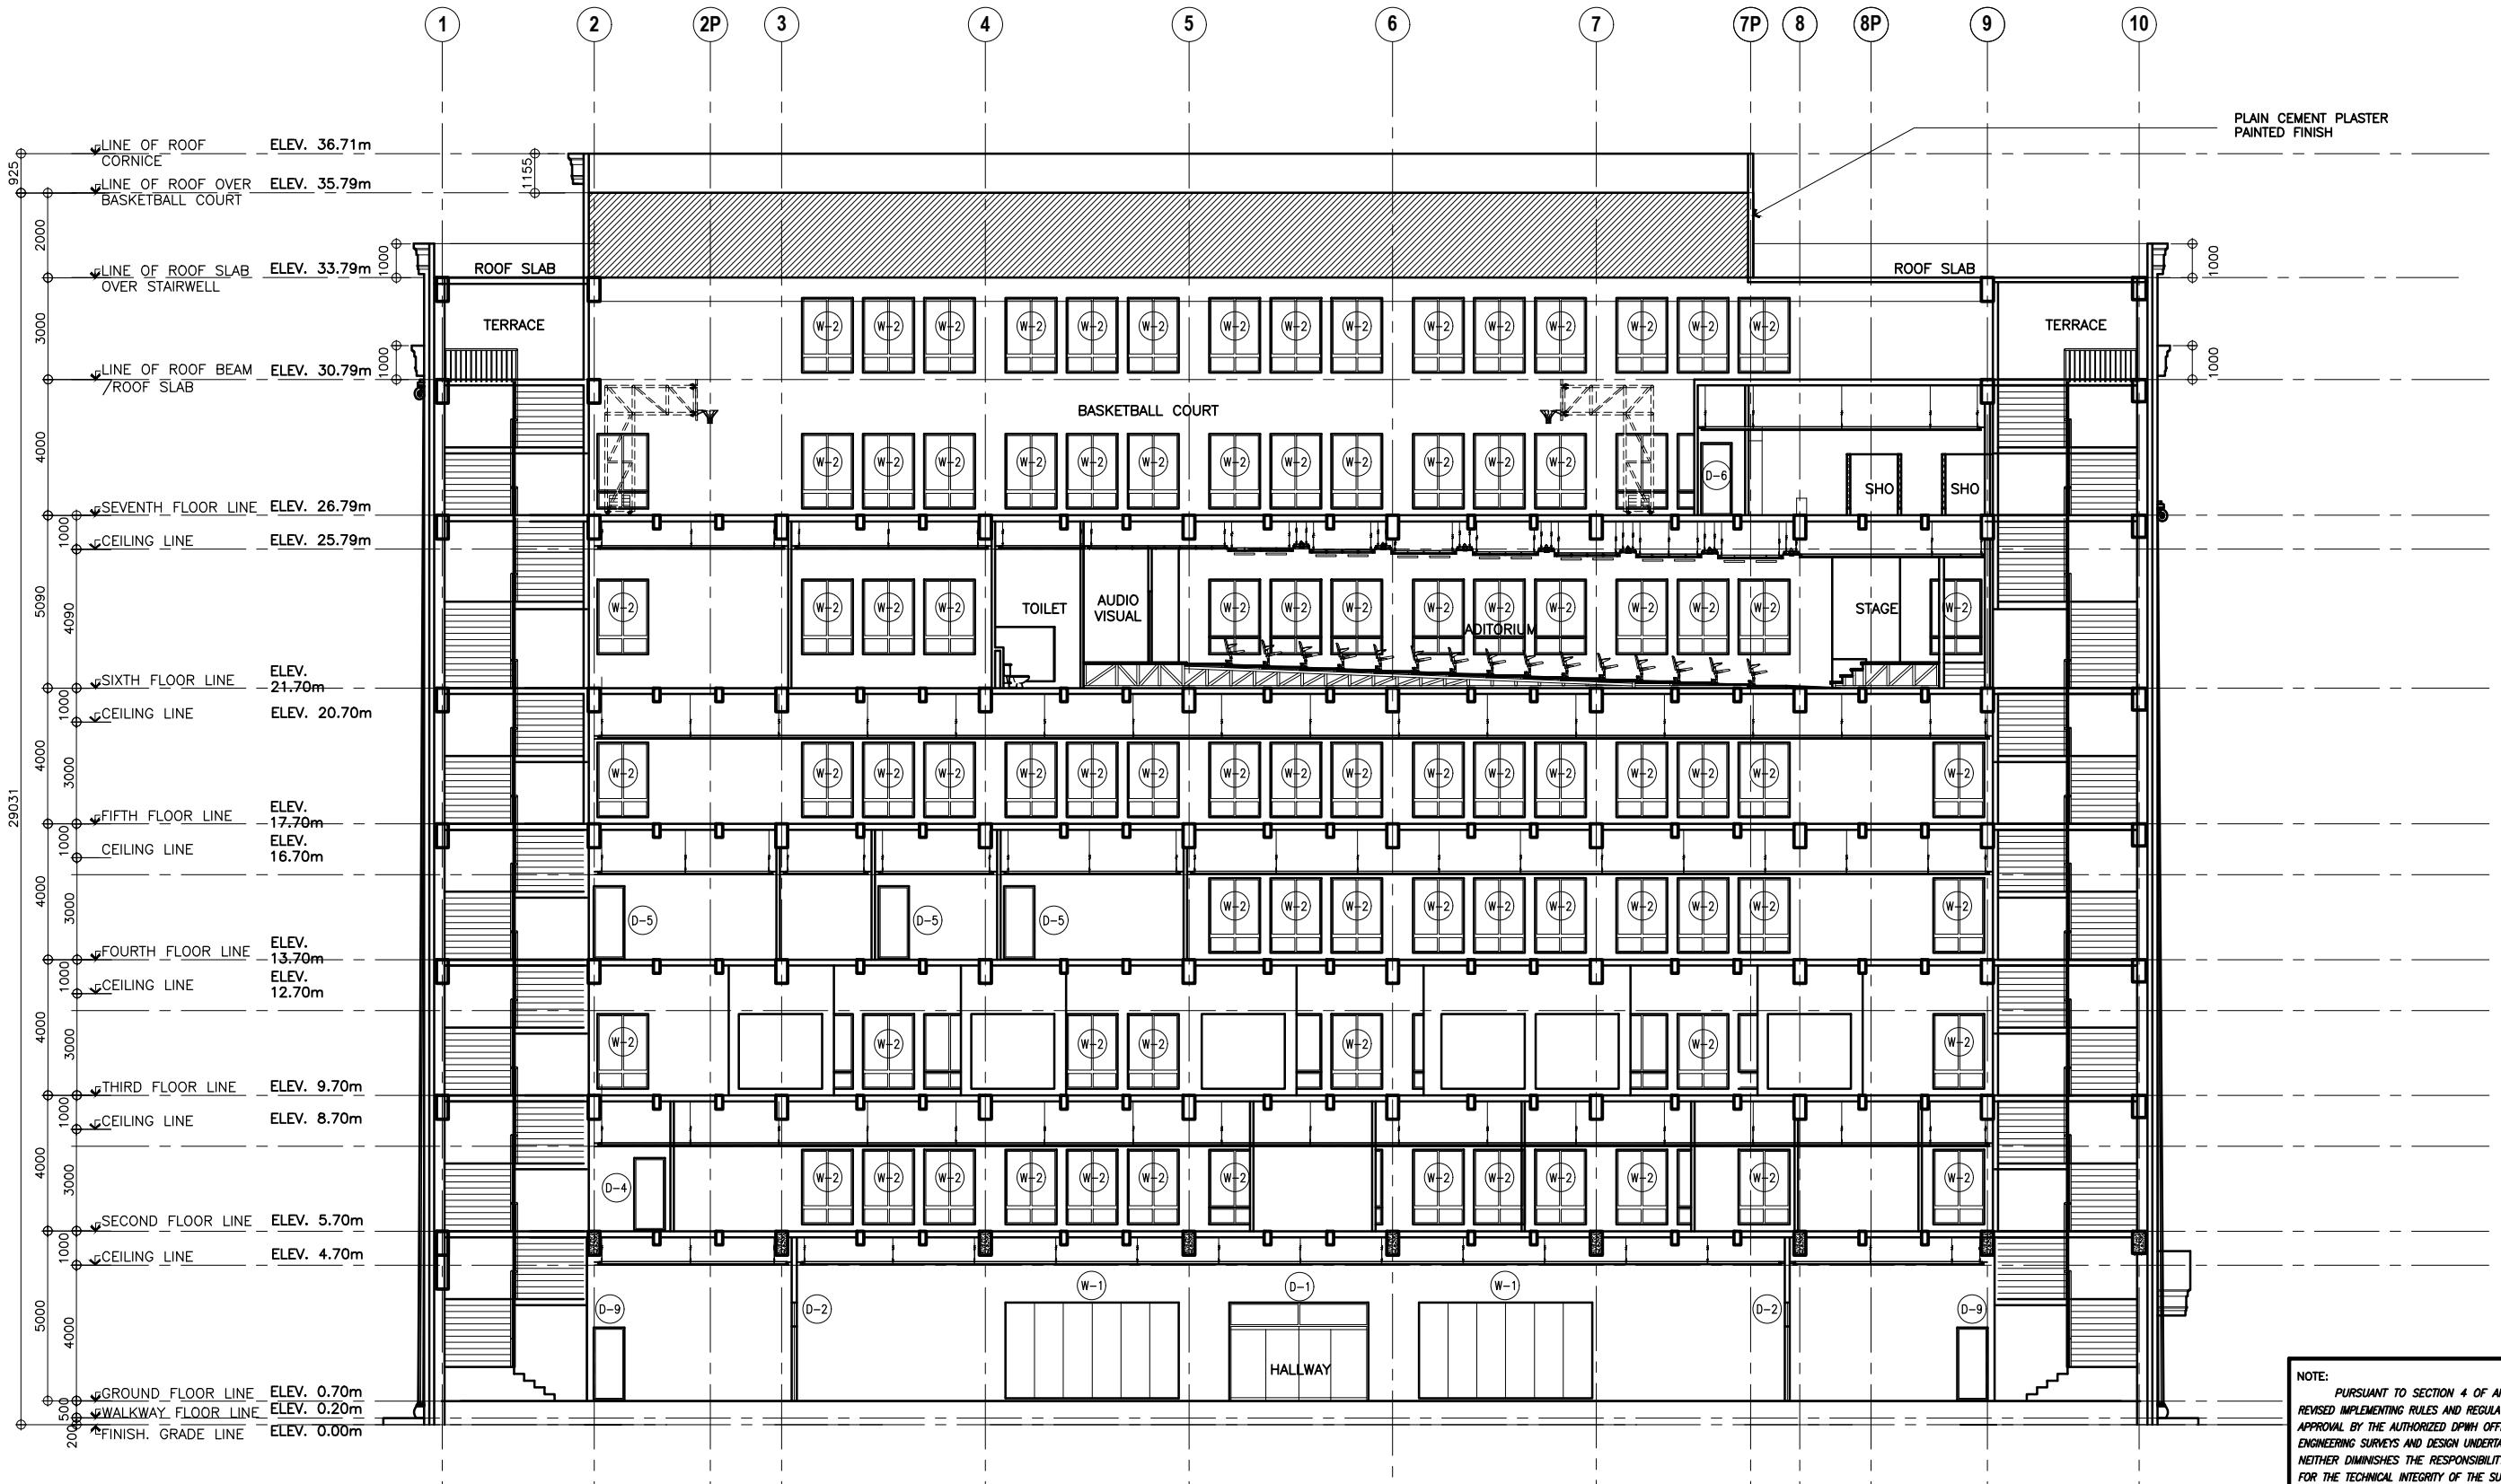


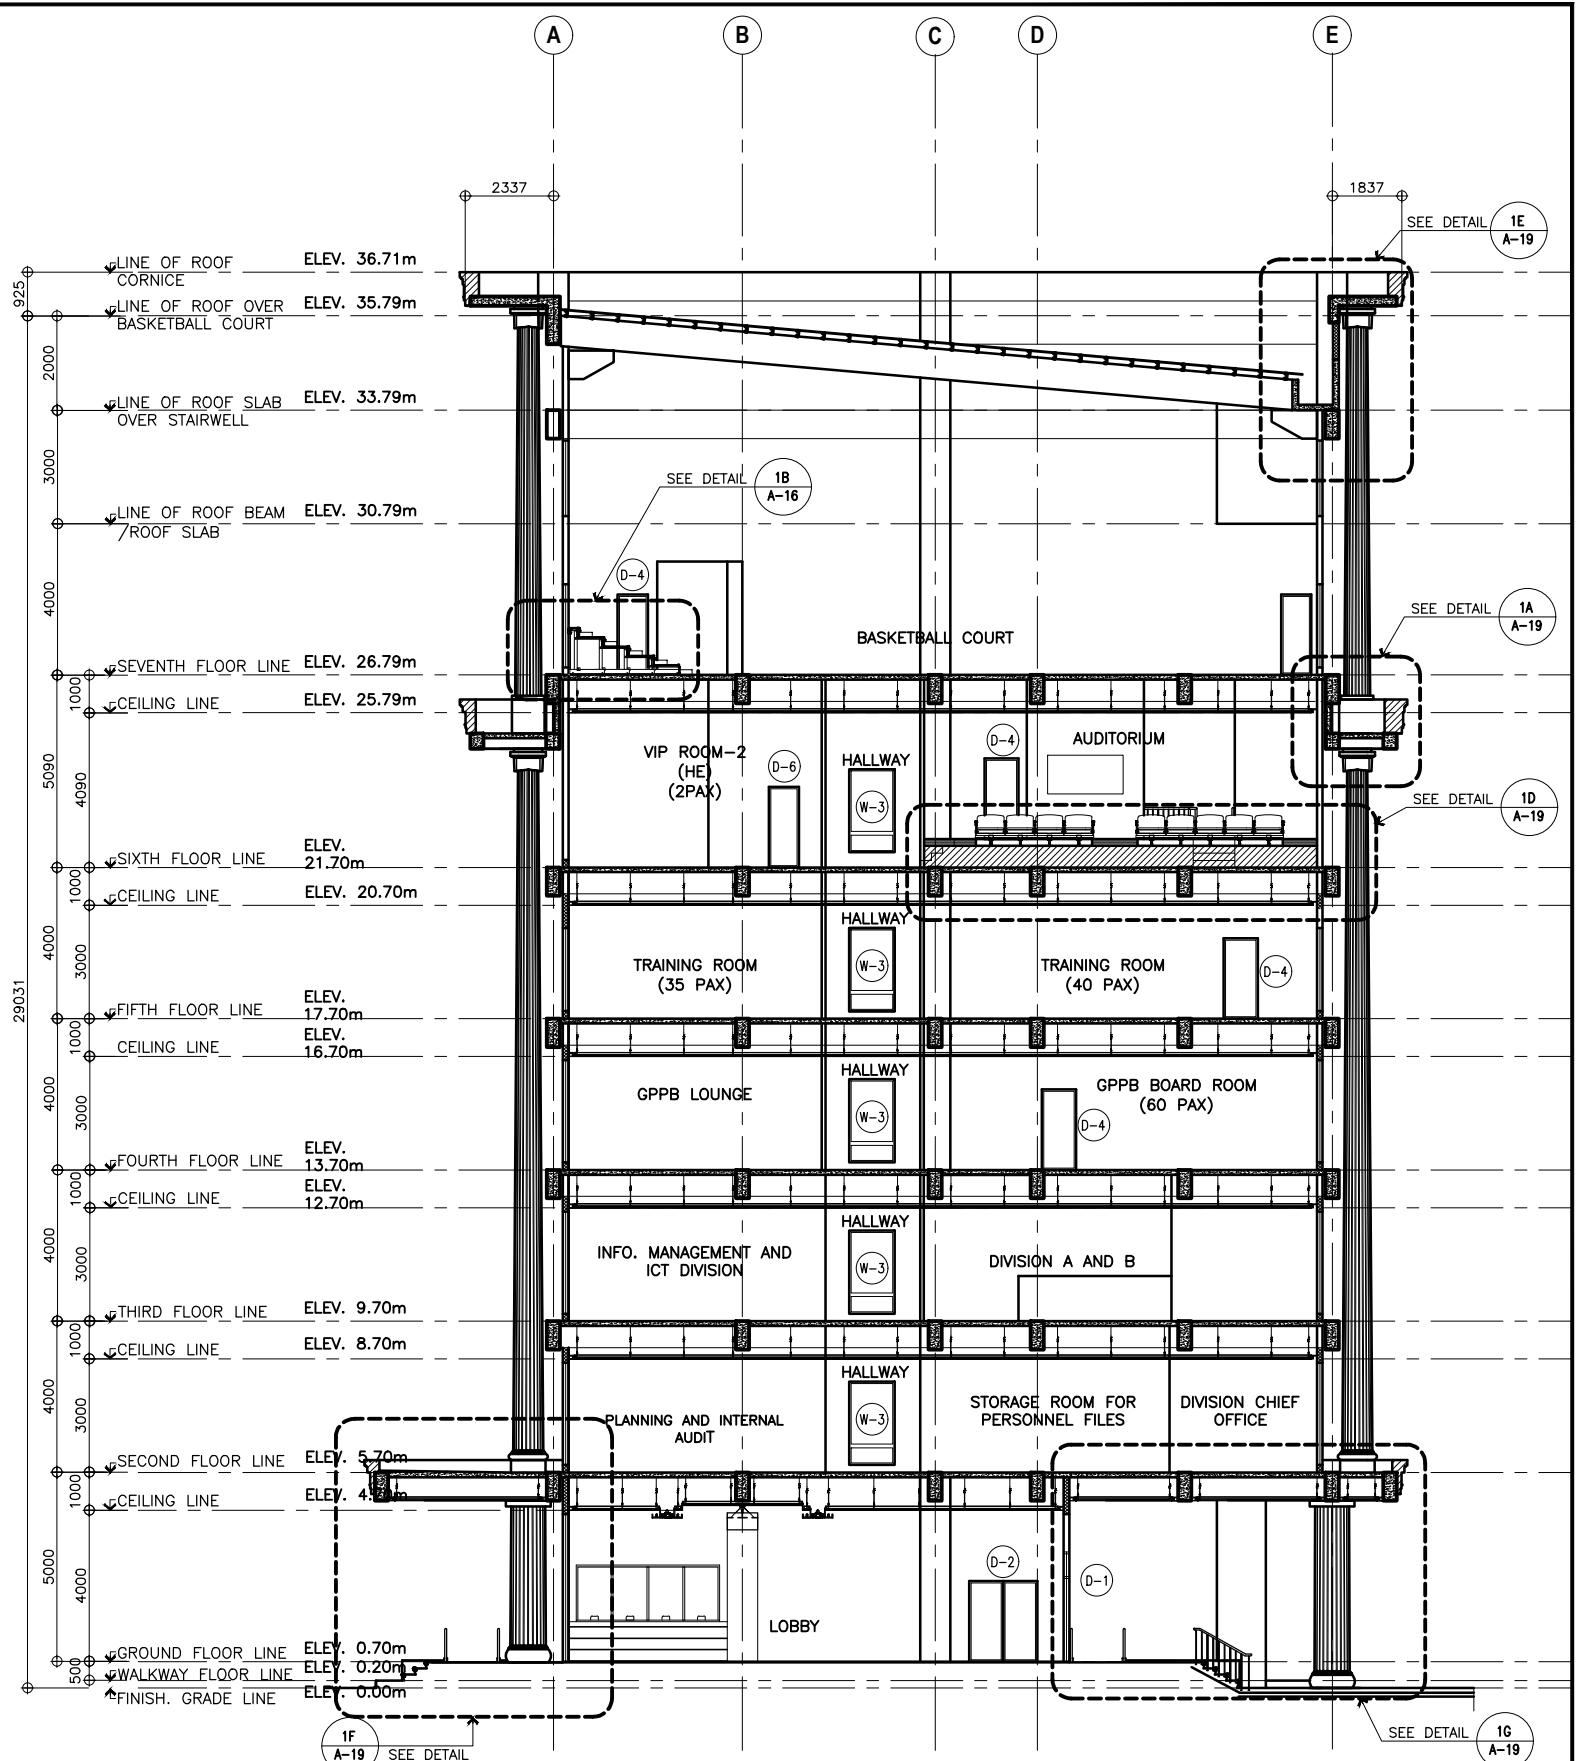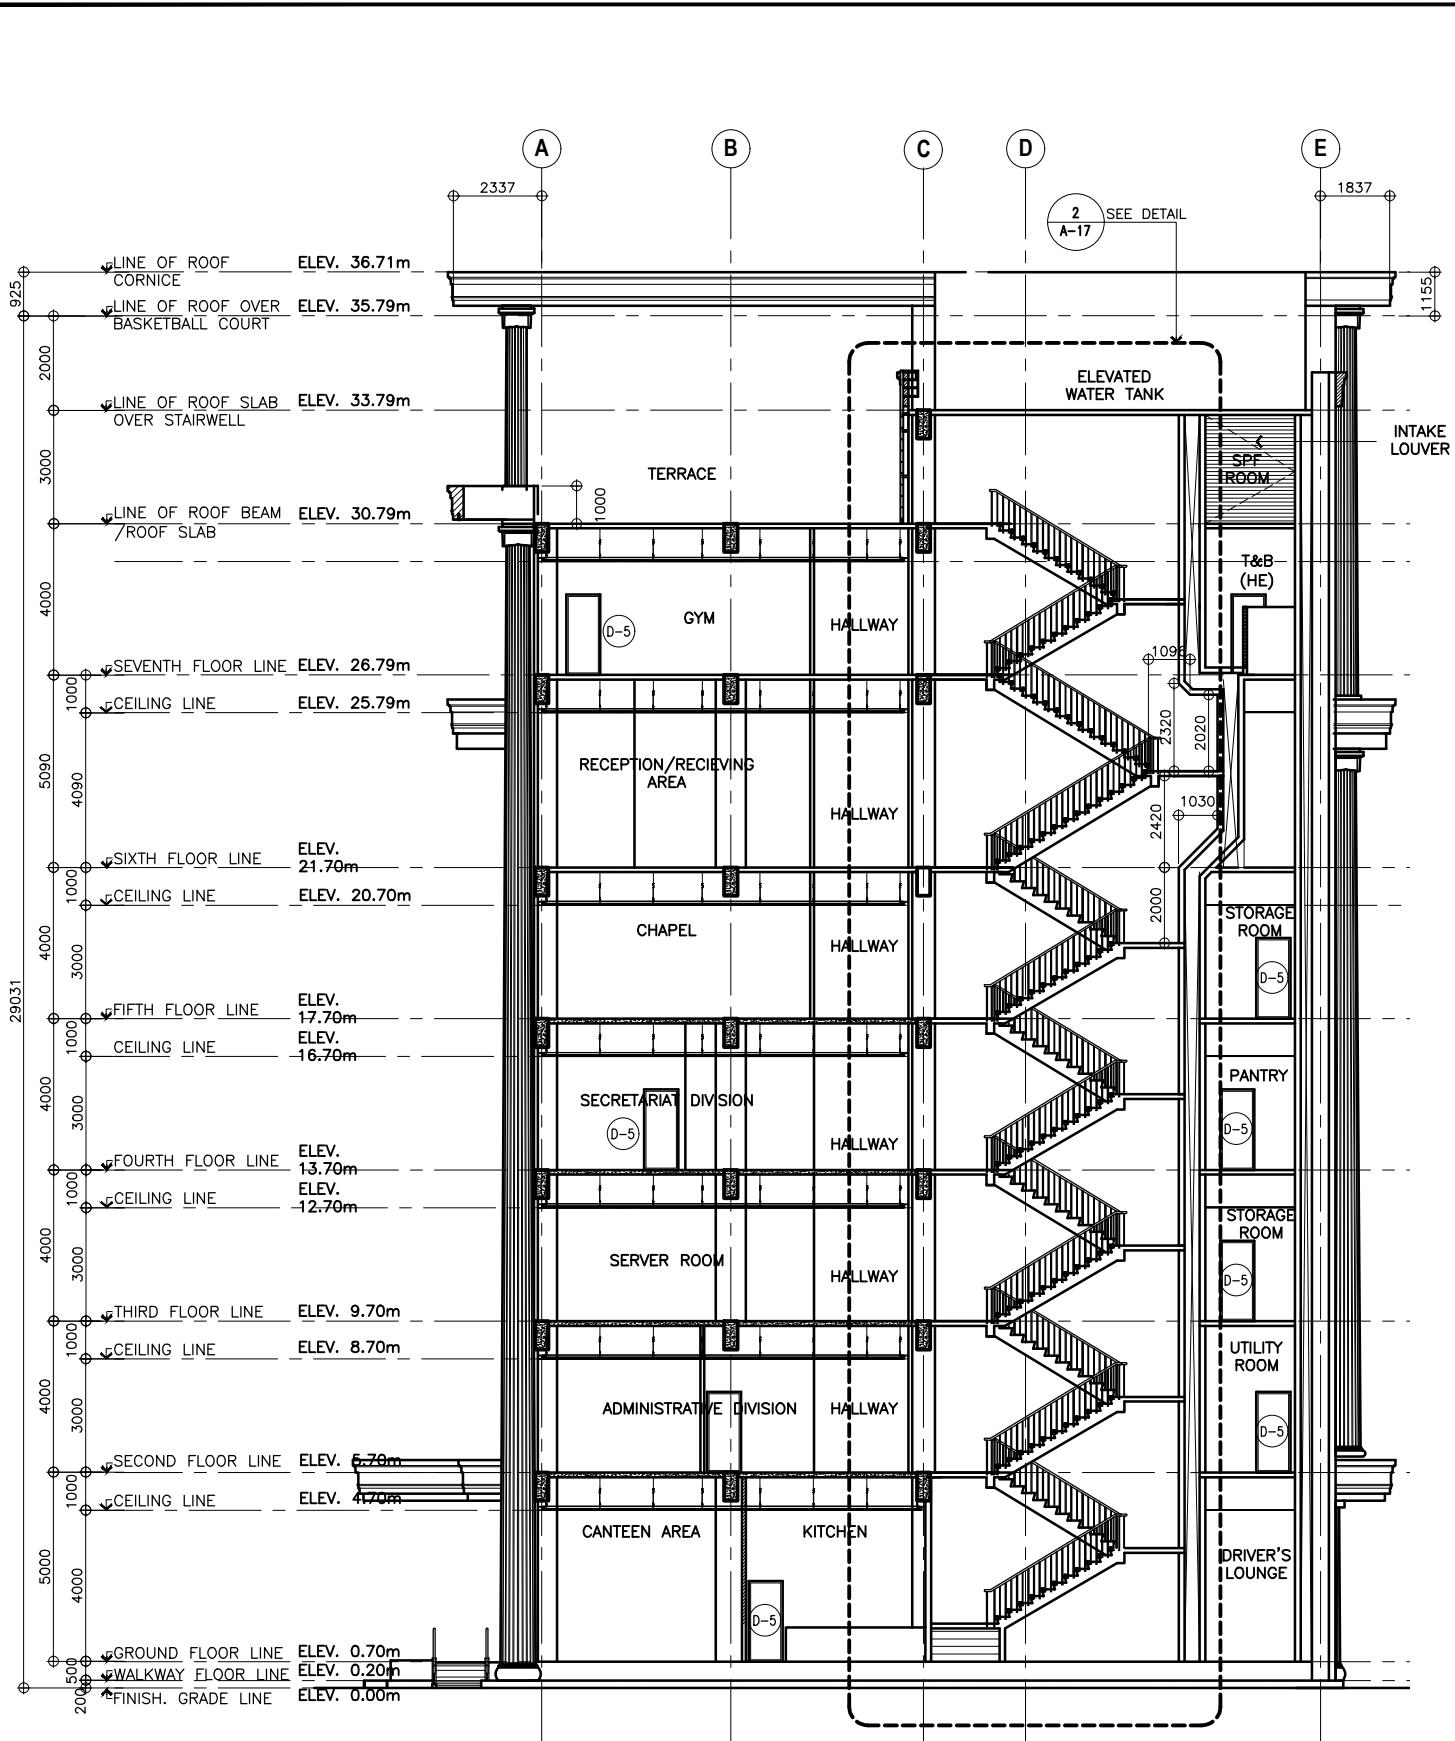


1 LONGITUDINAL SECTION "A"
A-16 SCALE 1:100M


2 LONGITUDINAL SECTION "B"
A-16 SCALE 1:100M

UNITED TECHNOLOGIES CONSOLIDATED PARTNERSHIP	PREPARED BY:	SUBMITTED BY:		REPUBLIC OF THE PHILIPPINES DEPARTMENT OF PUBLIC WORKS AND HIGHWAYS BUREAU OF DESIGN BUILDINGS DIVISION BONIFACIO DRIVE PORT AREA, MANILA	REVIEWED AS TO DESIGN CONCEPT:	RECOMMENDING APPROVAL:	APPROVED:	CONCURRED:	PROJECT & LOCATION / BARANGAY:	SHEET CONTENTS:	SET NO.	SHEET NO.
	ARMAN U. CUEVAS ARCHITECTURAL DESIGN POSITION: ARCHITECT PRC No.: 0018676 TIN No.: 907-359-364 PTR No.: 4020896	CYNTHIA CLEMEN A. YU ARCHITECT/TEAM LEADER		JOSEPHINE P. ISTURIS CHIEF, BUILDINGS DIVISION, BOD	(SEE COVER SHEET) LEA N. DELFINADO, CESO IV OFFICER-IN-CHARGE	(SEE COVER SHEET) EMIL K. SADAIN, CESO I	(SEE COVER SHEET) ROWENA CANDICE M. RUIZ EXECUTIVE DIRECTOR	PROPOSED: PROPOSED SEVEN (7) STOREY GOVERNMENT PROCUREMENT POLICY BOARD (GPPB) UP DILIMAN COMPOUND, DILIMAN, QUEZON CITY	LONGITUDINAL SECTION "A", LONGITUDINAL SECTION "B"	 BOD A-16	18 216	

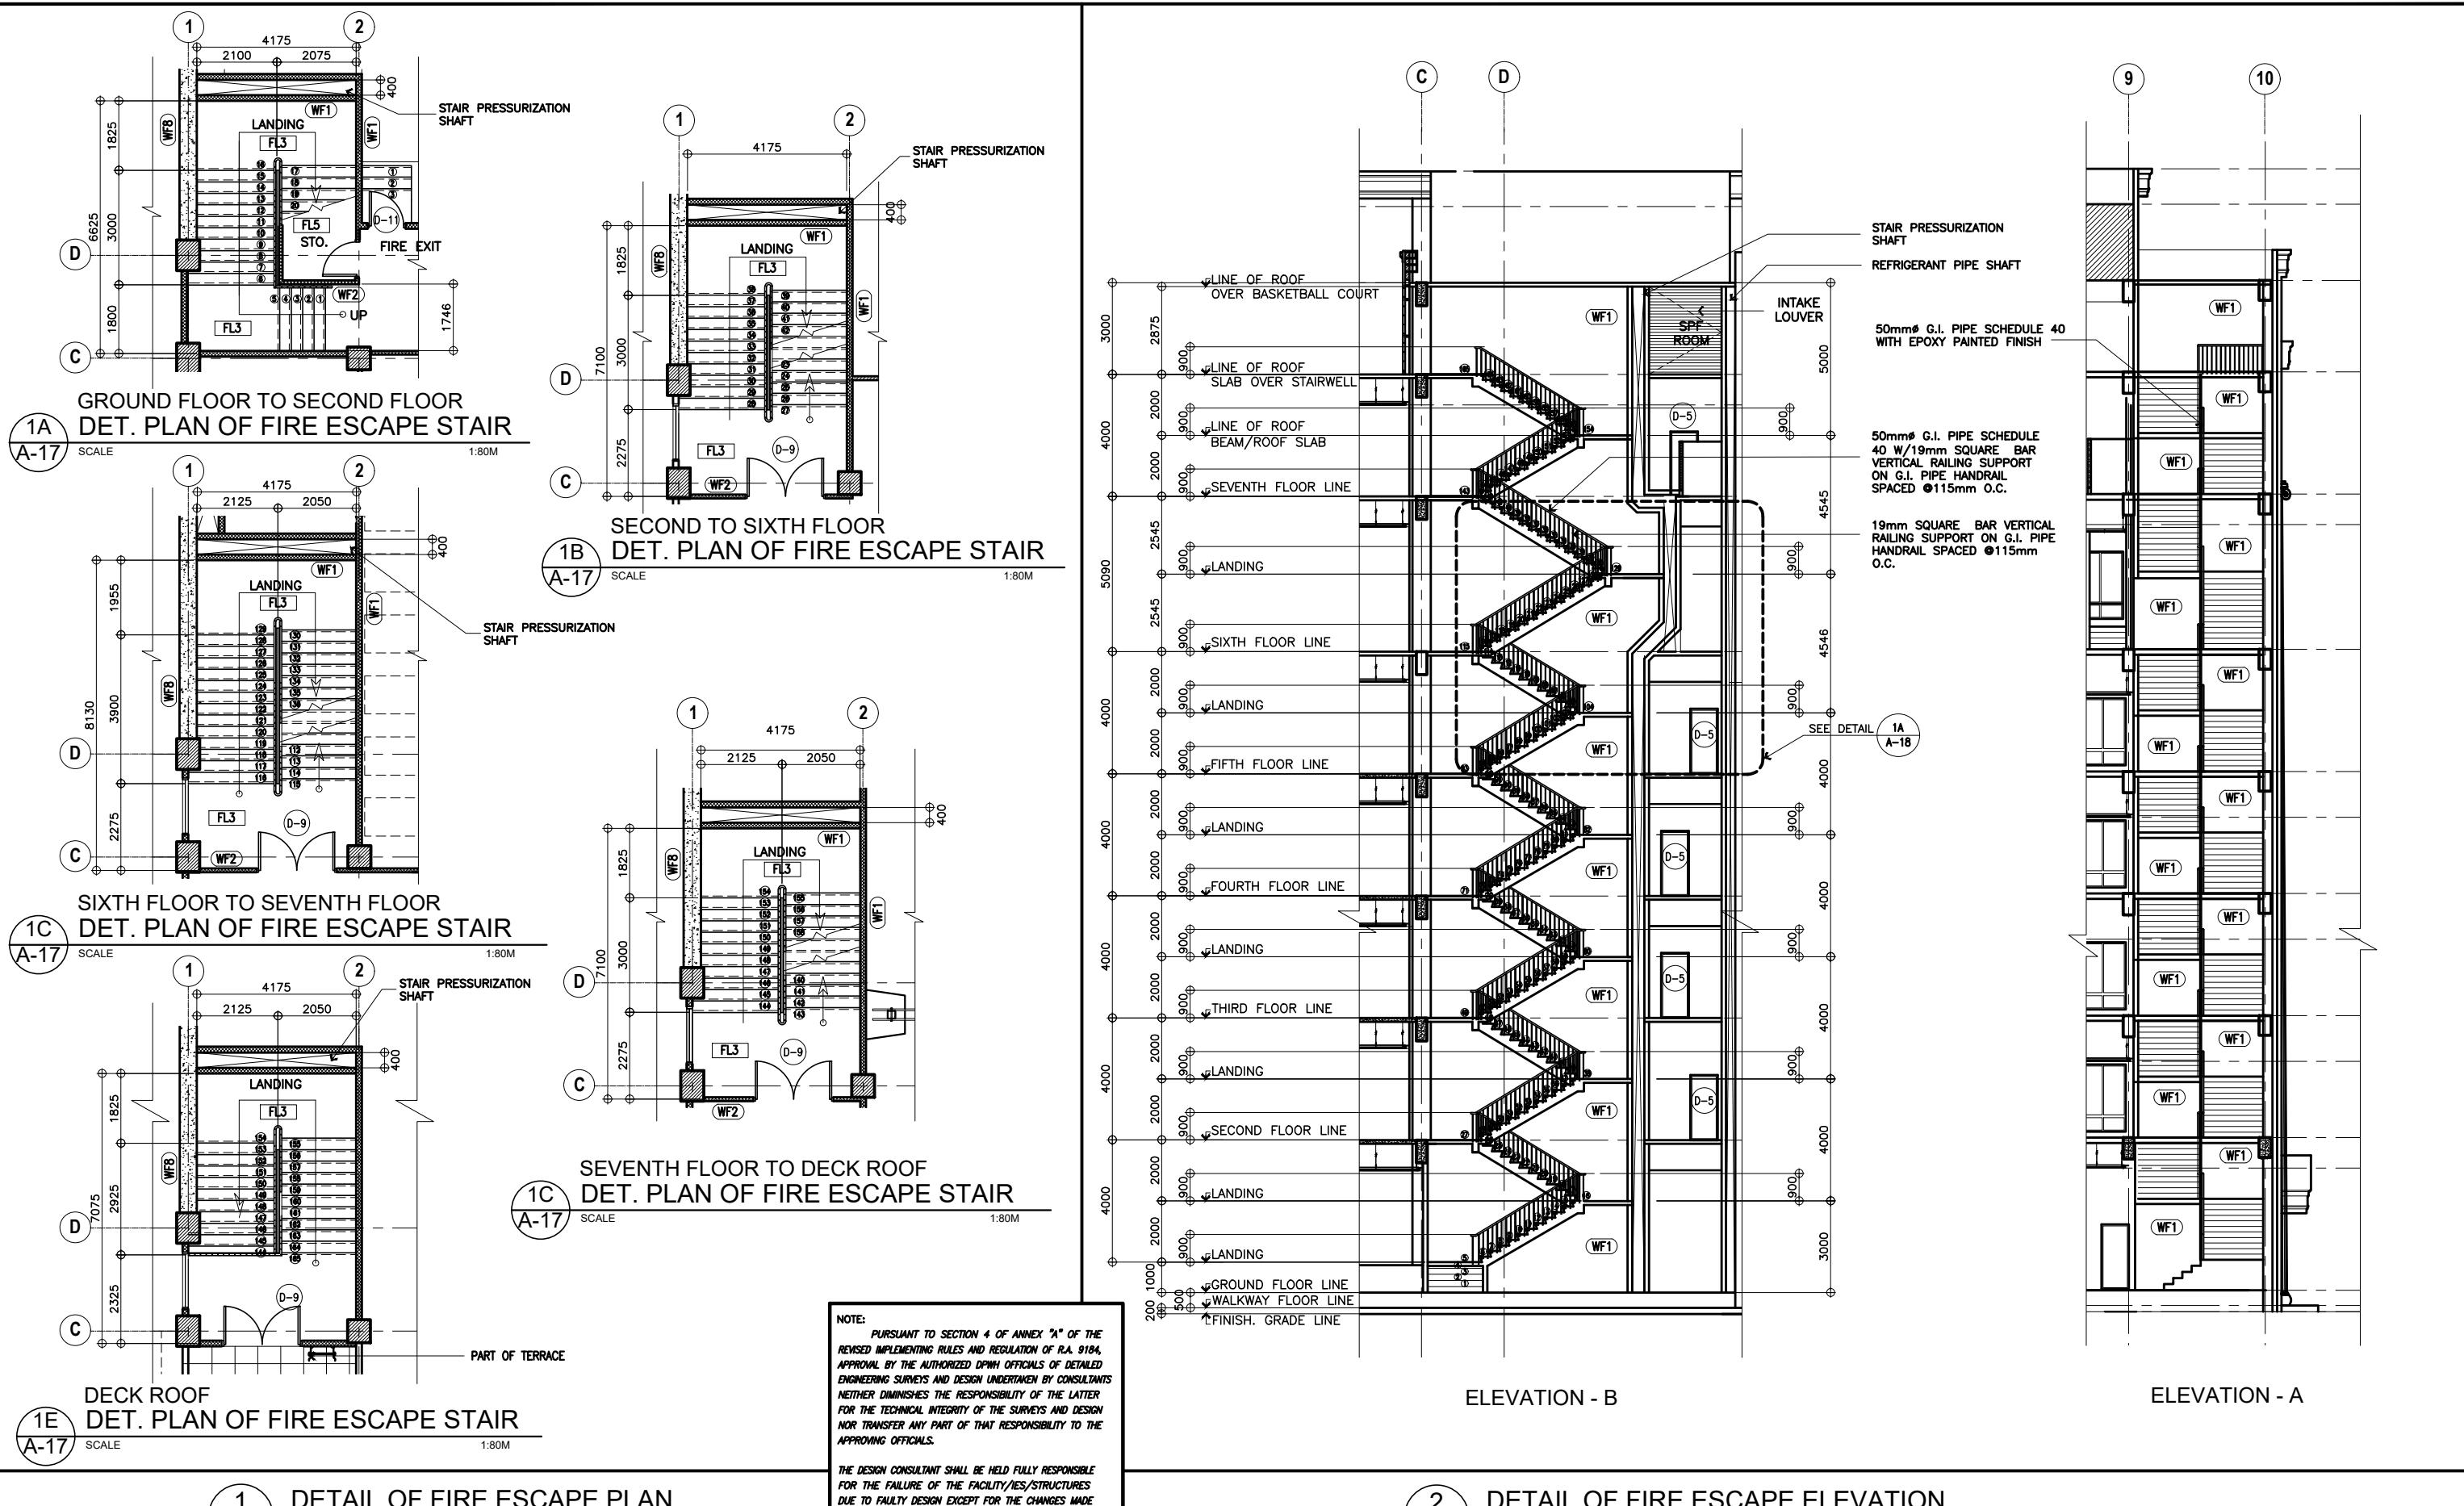


UNITED TECHNOLOGIES CONSOLIDATED PARTNERSHIP	PREPARED BY: ARMAN U. CUEVAS ARCHITECTURAL DESIGN POSITION: ARCHITECT PRC No.: 0018676 TIN No.: 907-359-364 PTR No.: 4020896	SUBMITTED BY: CYNTHIA CLEMEN A. YU ARCHITECT/TEAM LEADER	REPUBLIC OF THE PHILIPPINES DEPARTMENT OF PUBLIC WORKS AND HIGHWAYS BUREAU OF DESIGN BUILDINGS DIVISION BONIFACIO DRIVE PORT AREA, MANILA	REVIEWED AS TO DESIGN CONCEPT: JOSEPHINE P. ISTURIS CHIEF, BUILDINGS DIVISION, BOD	RECOMMENDING APPROVAL: (SEE COVER SHEET) LEA N. DELFINADO, CESO IV OFFICER-IN-CHARGE	APPROVED: (SEE COVER SHEET) EMIL K. SADAIN, CESO I UNDERSECRETARY FOR UPMO OPERATIONS & TECHNICAL SERVICES	CONCURRED: (SEE COVER SHEET) ROWENA CANDICE M. RUIZ EXECUTIVE DIRECTOR	PROJECT & LOCATION / BARANGAY: PROPOSED SEVEN (7) STOREY GOVERNMENT PROCUREMENT POLICY BOARD (GPPB) UP DILIMAN COMPOUND, DILIMAN, QUEZON CITY	HEET CONTENTS: DETAIL OF FIRE ESCAPE PLAN, DETAIL OF FIRE ESCAPE ELEVATION	SET NO. BOD A-17	SET NO. 19 216
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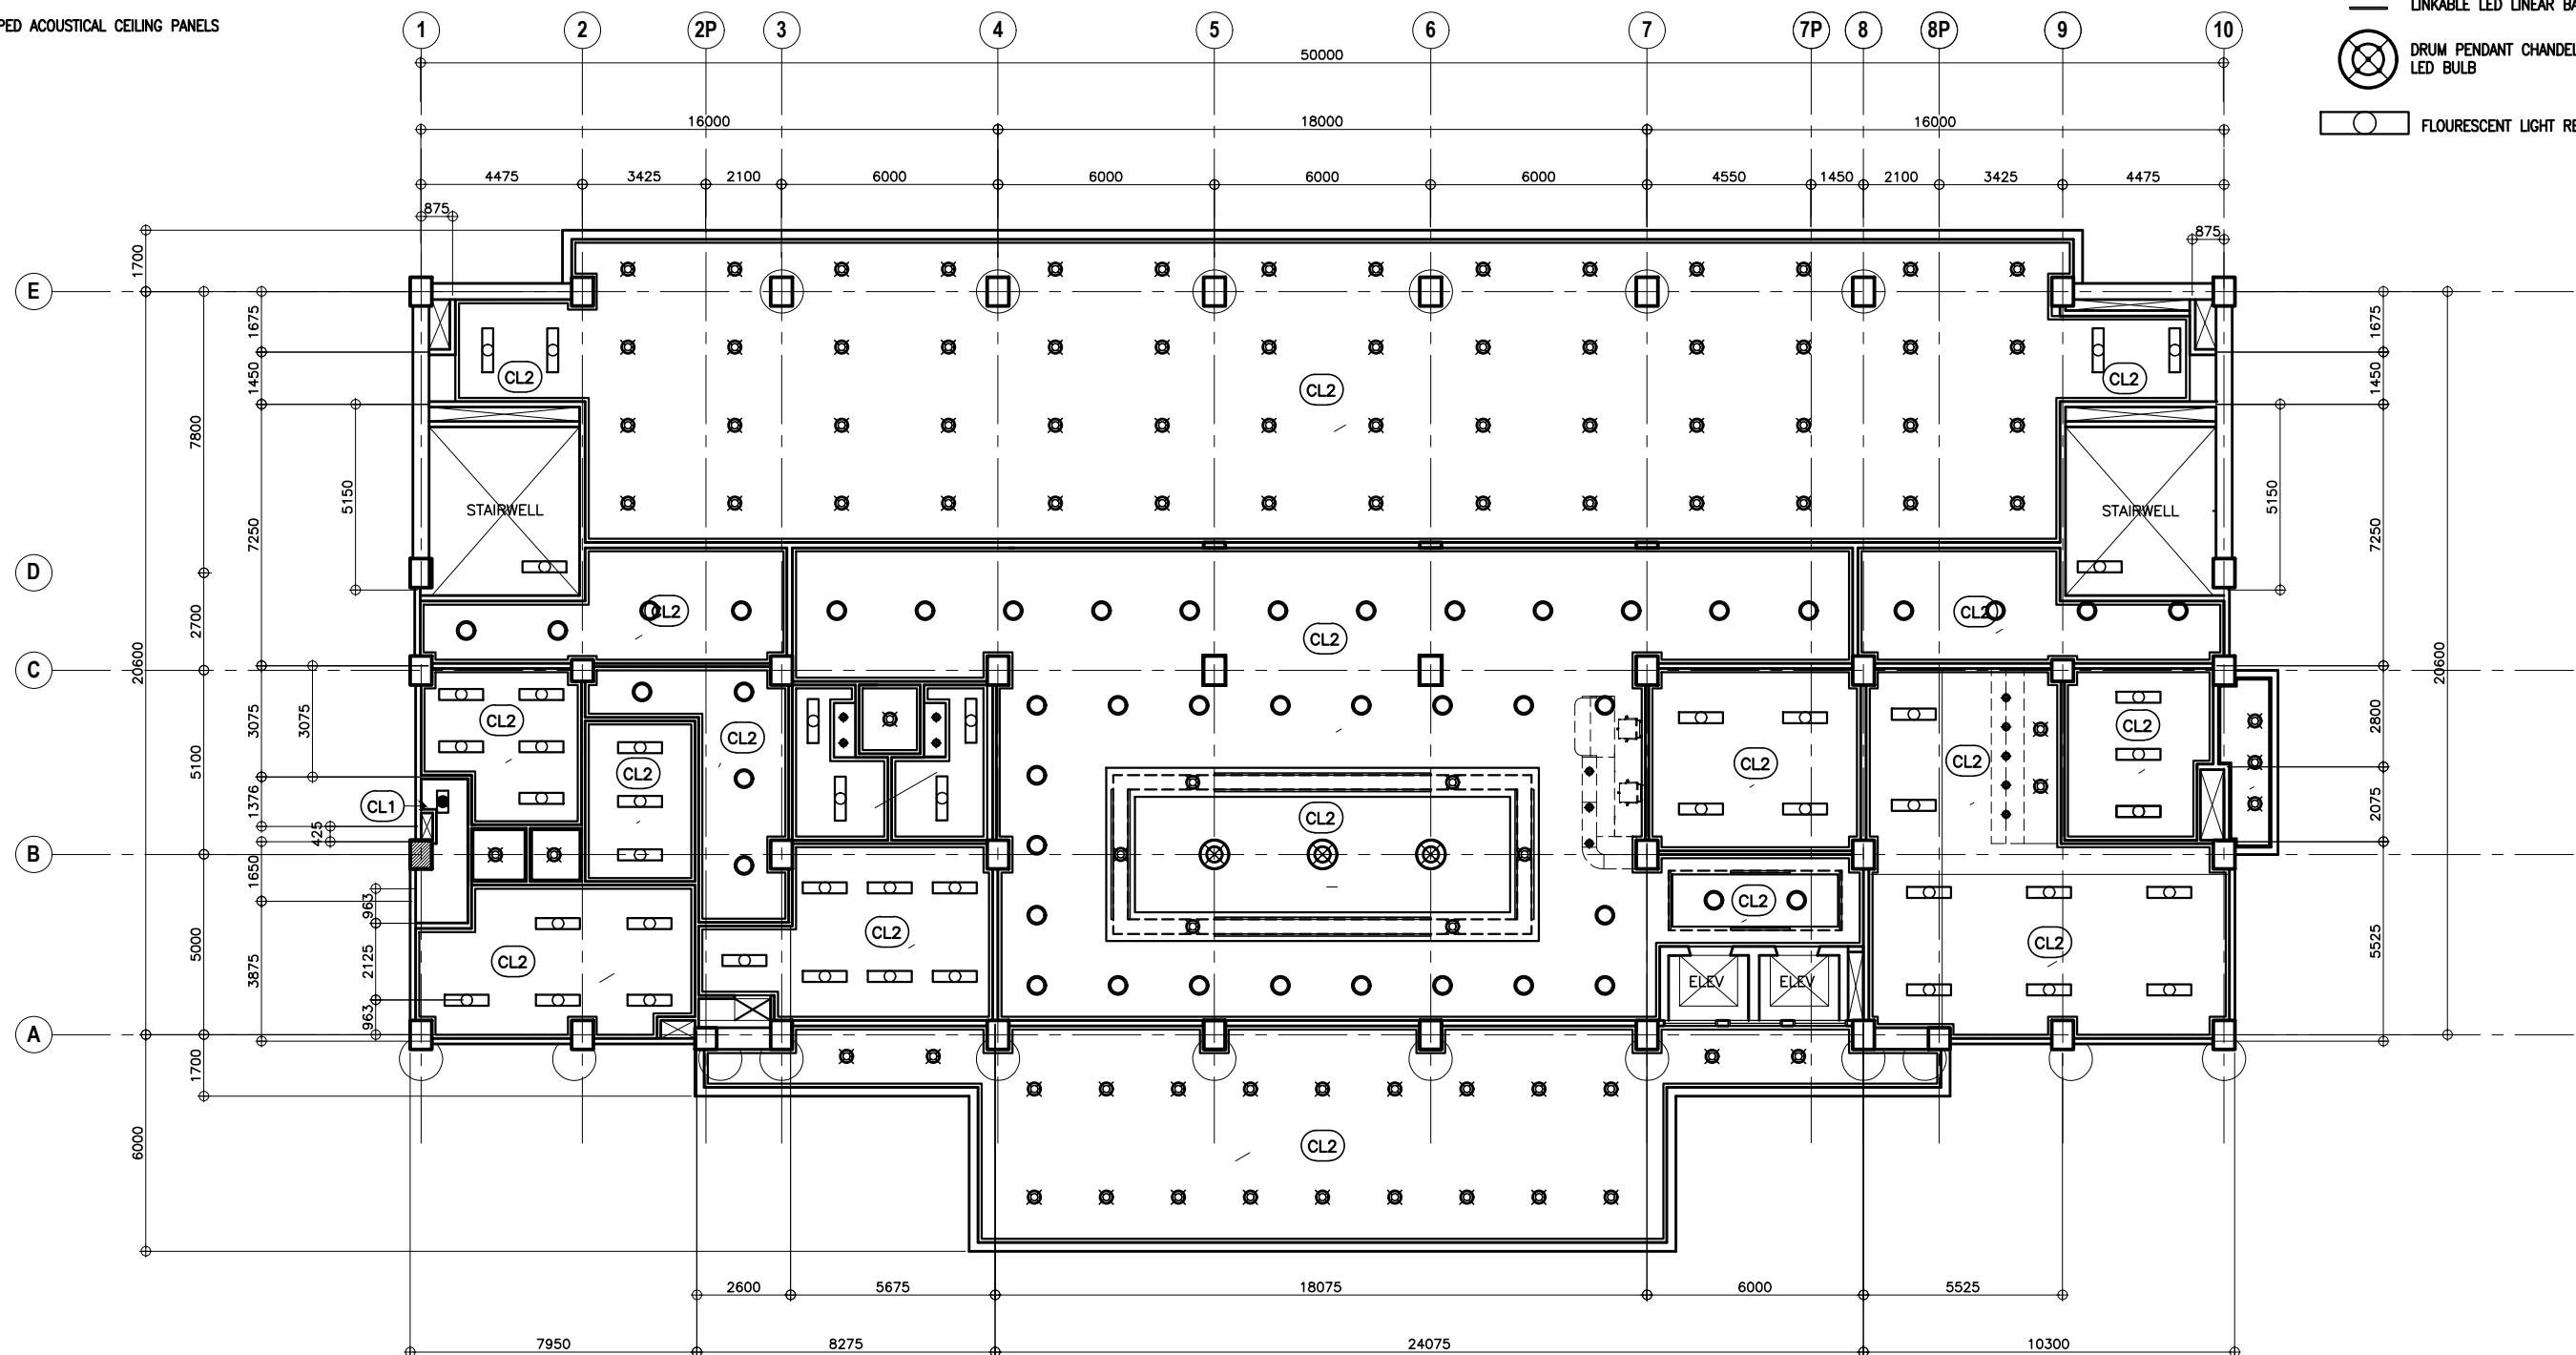
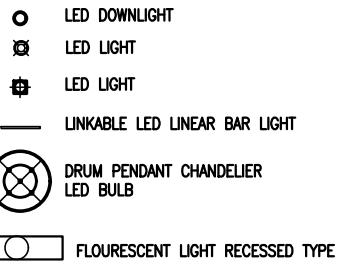
UNITED TECHNOLOGIES CONSOLIDATED PARTNERSHIP	PREPARED BY:	SUBMITTED BY:	REVIEWED AS TO DESIGN CONCEPT:	RECOMMENDING APPROVAL:	APPROVED:	CONCURRED:	PROJECT & LOCATION / BARANGAY:	SPOT DETAILS: LADDER DETAIL	SET NO.	SHEET NO.
	ARMAN U. CUEVAS ARCHITECTURAL DESIGN POSITION: ARCHITECT PRC No.: 0018676 TIN No.: 907-359-364 PTR No.: 4020896	CYNTHIA CLEMEN A. YU ARCHITECT/TEAM LEADER	JOSEPHINE P. ISTURIS CHIEF, BUILDINGS DIVISION, BOD	(SEE COVER SHEET) LEA N. DELFINADO, CESO IV OFFICER-IN-CHARGE	(SEE COVER SHEET) EMIL K. SADAIN, CESO I UNDERSECRETARY FOR UPMO OPERATIONS & TECHNICAL SERVICES	(SEE COVER SHEET) ROWENA CANDICE M. RUIZ EXECUTIVE DIRECTOR	PROPOSED SEVEN (7) STOREY GOVERNMENT PROCUREMENT POLICY BOARD (GPPB) UP DILIMAN COMPOUND, DILIMAN, QUEZON CITY		BOD A-19	21 216

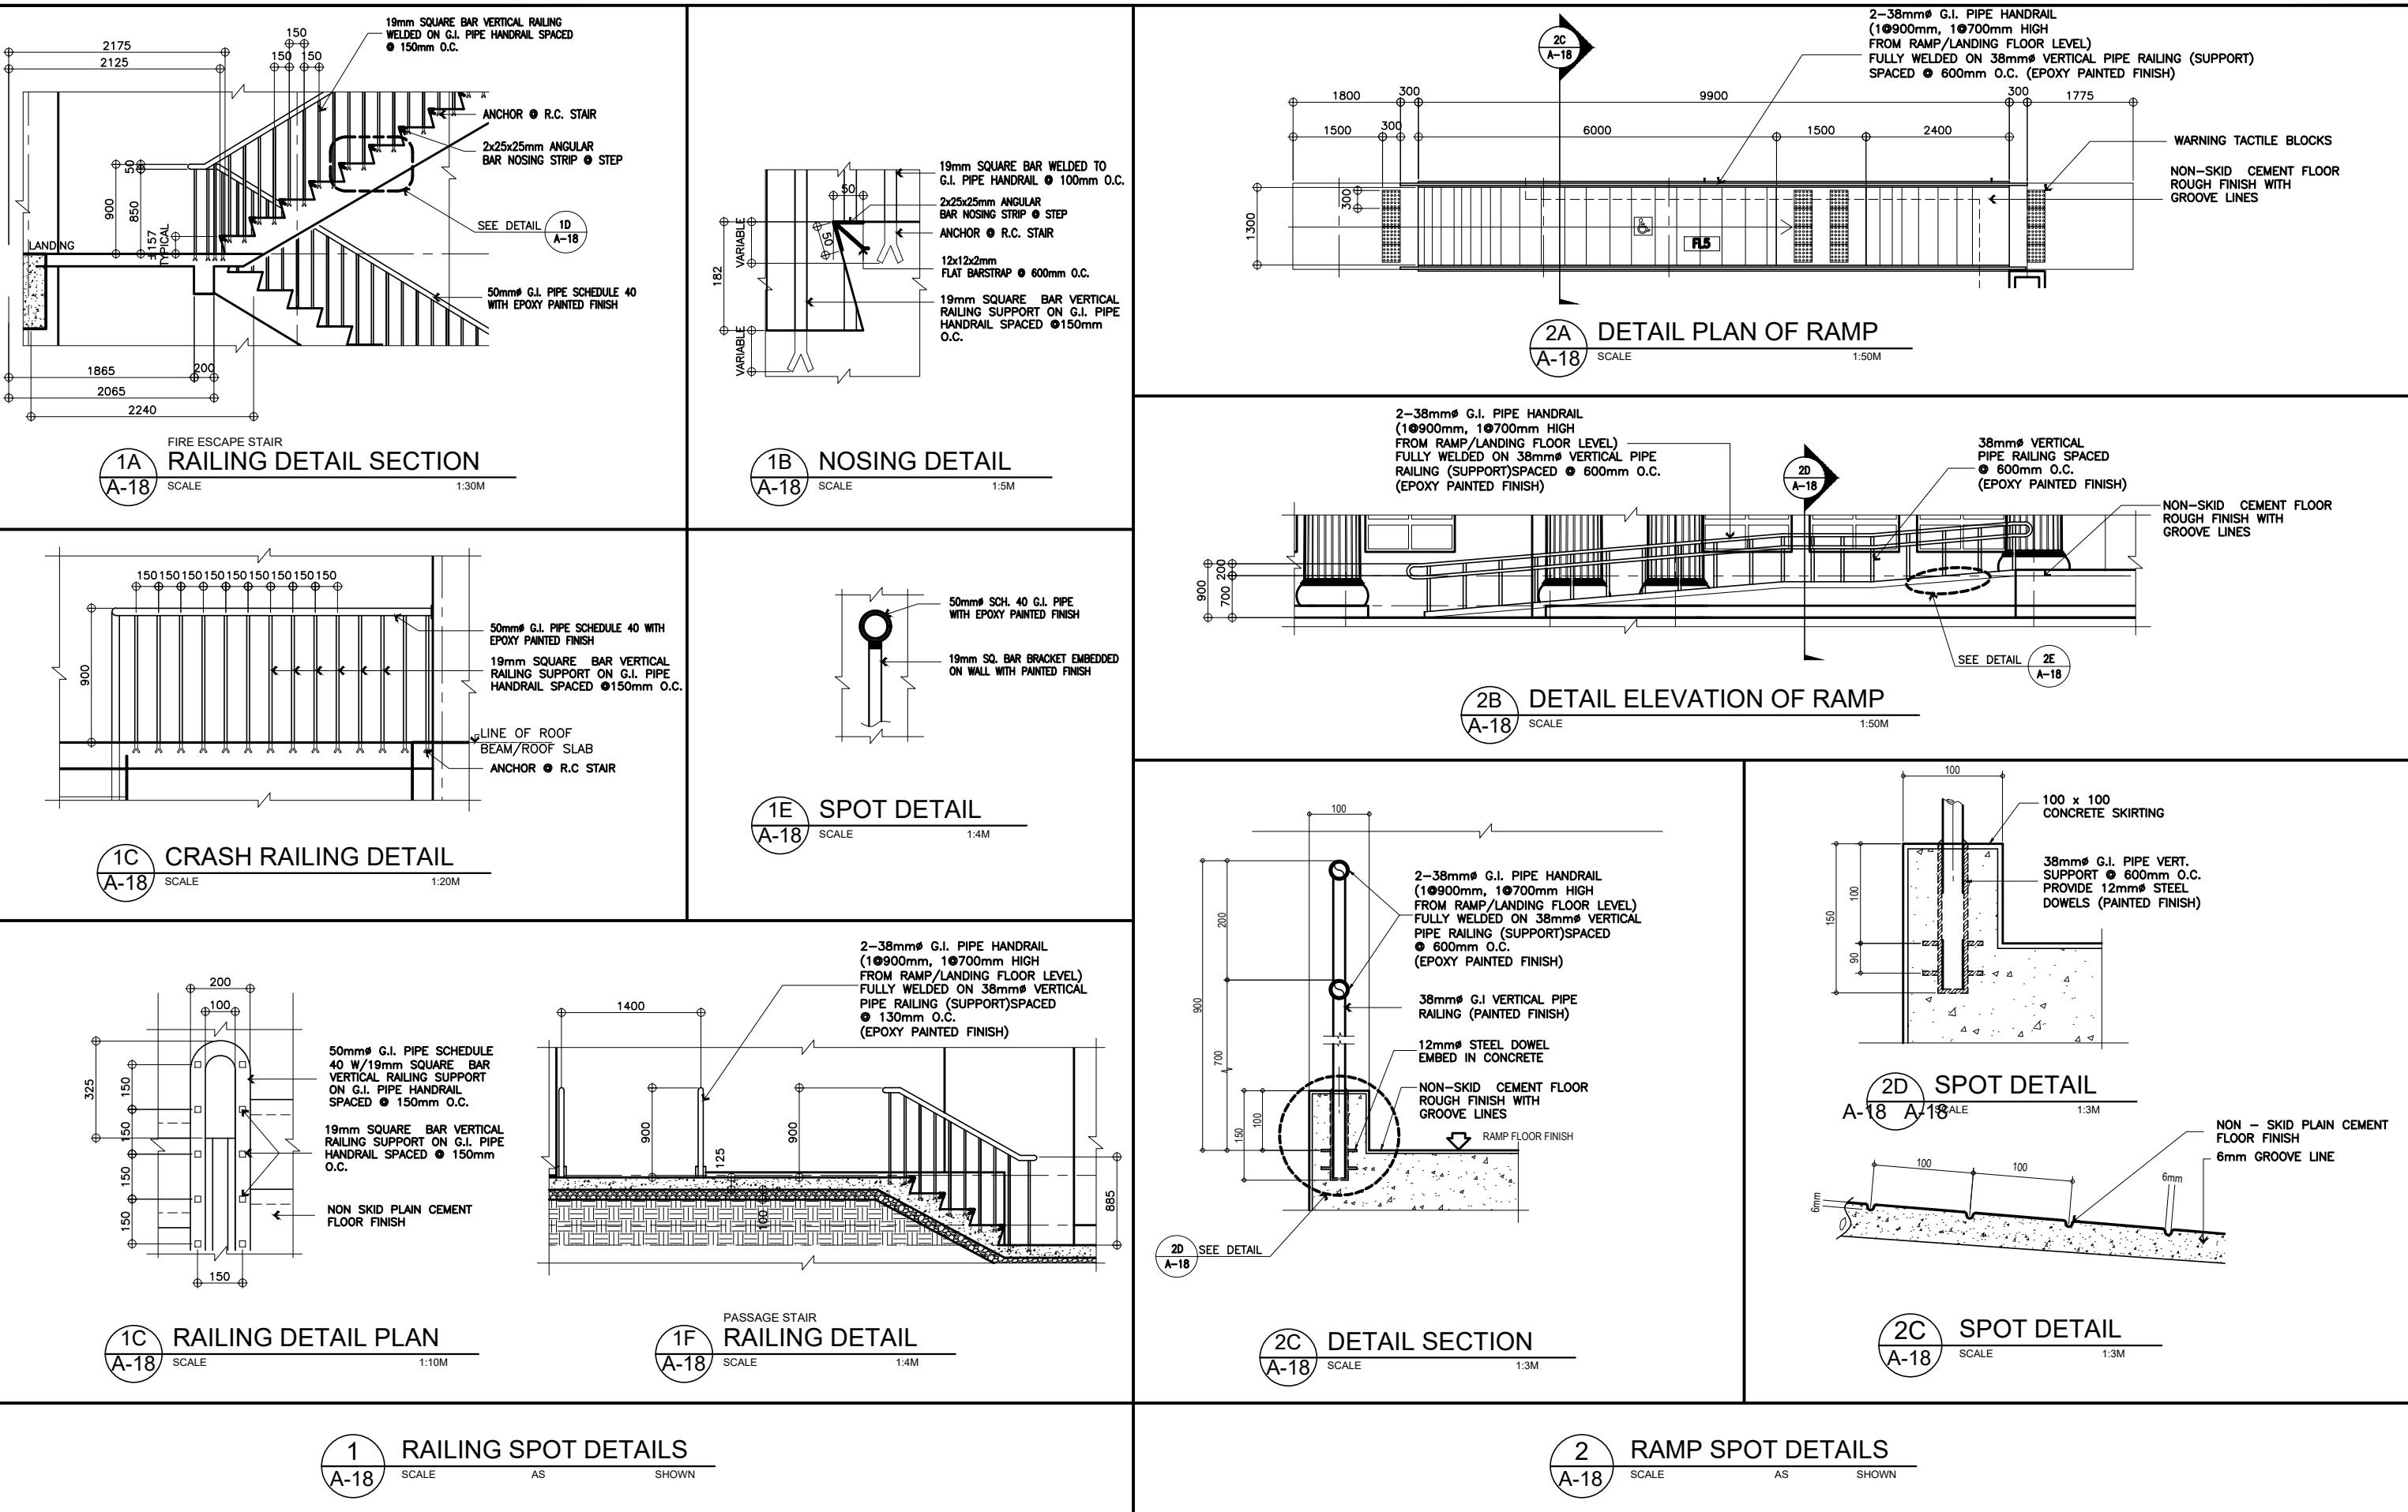

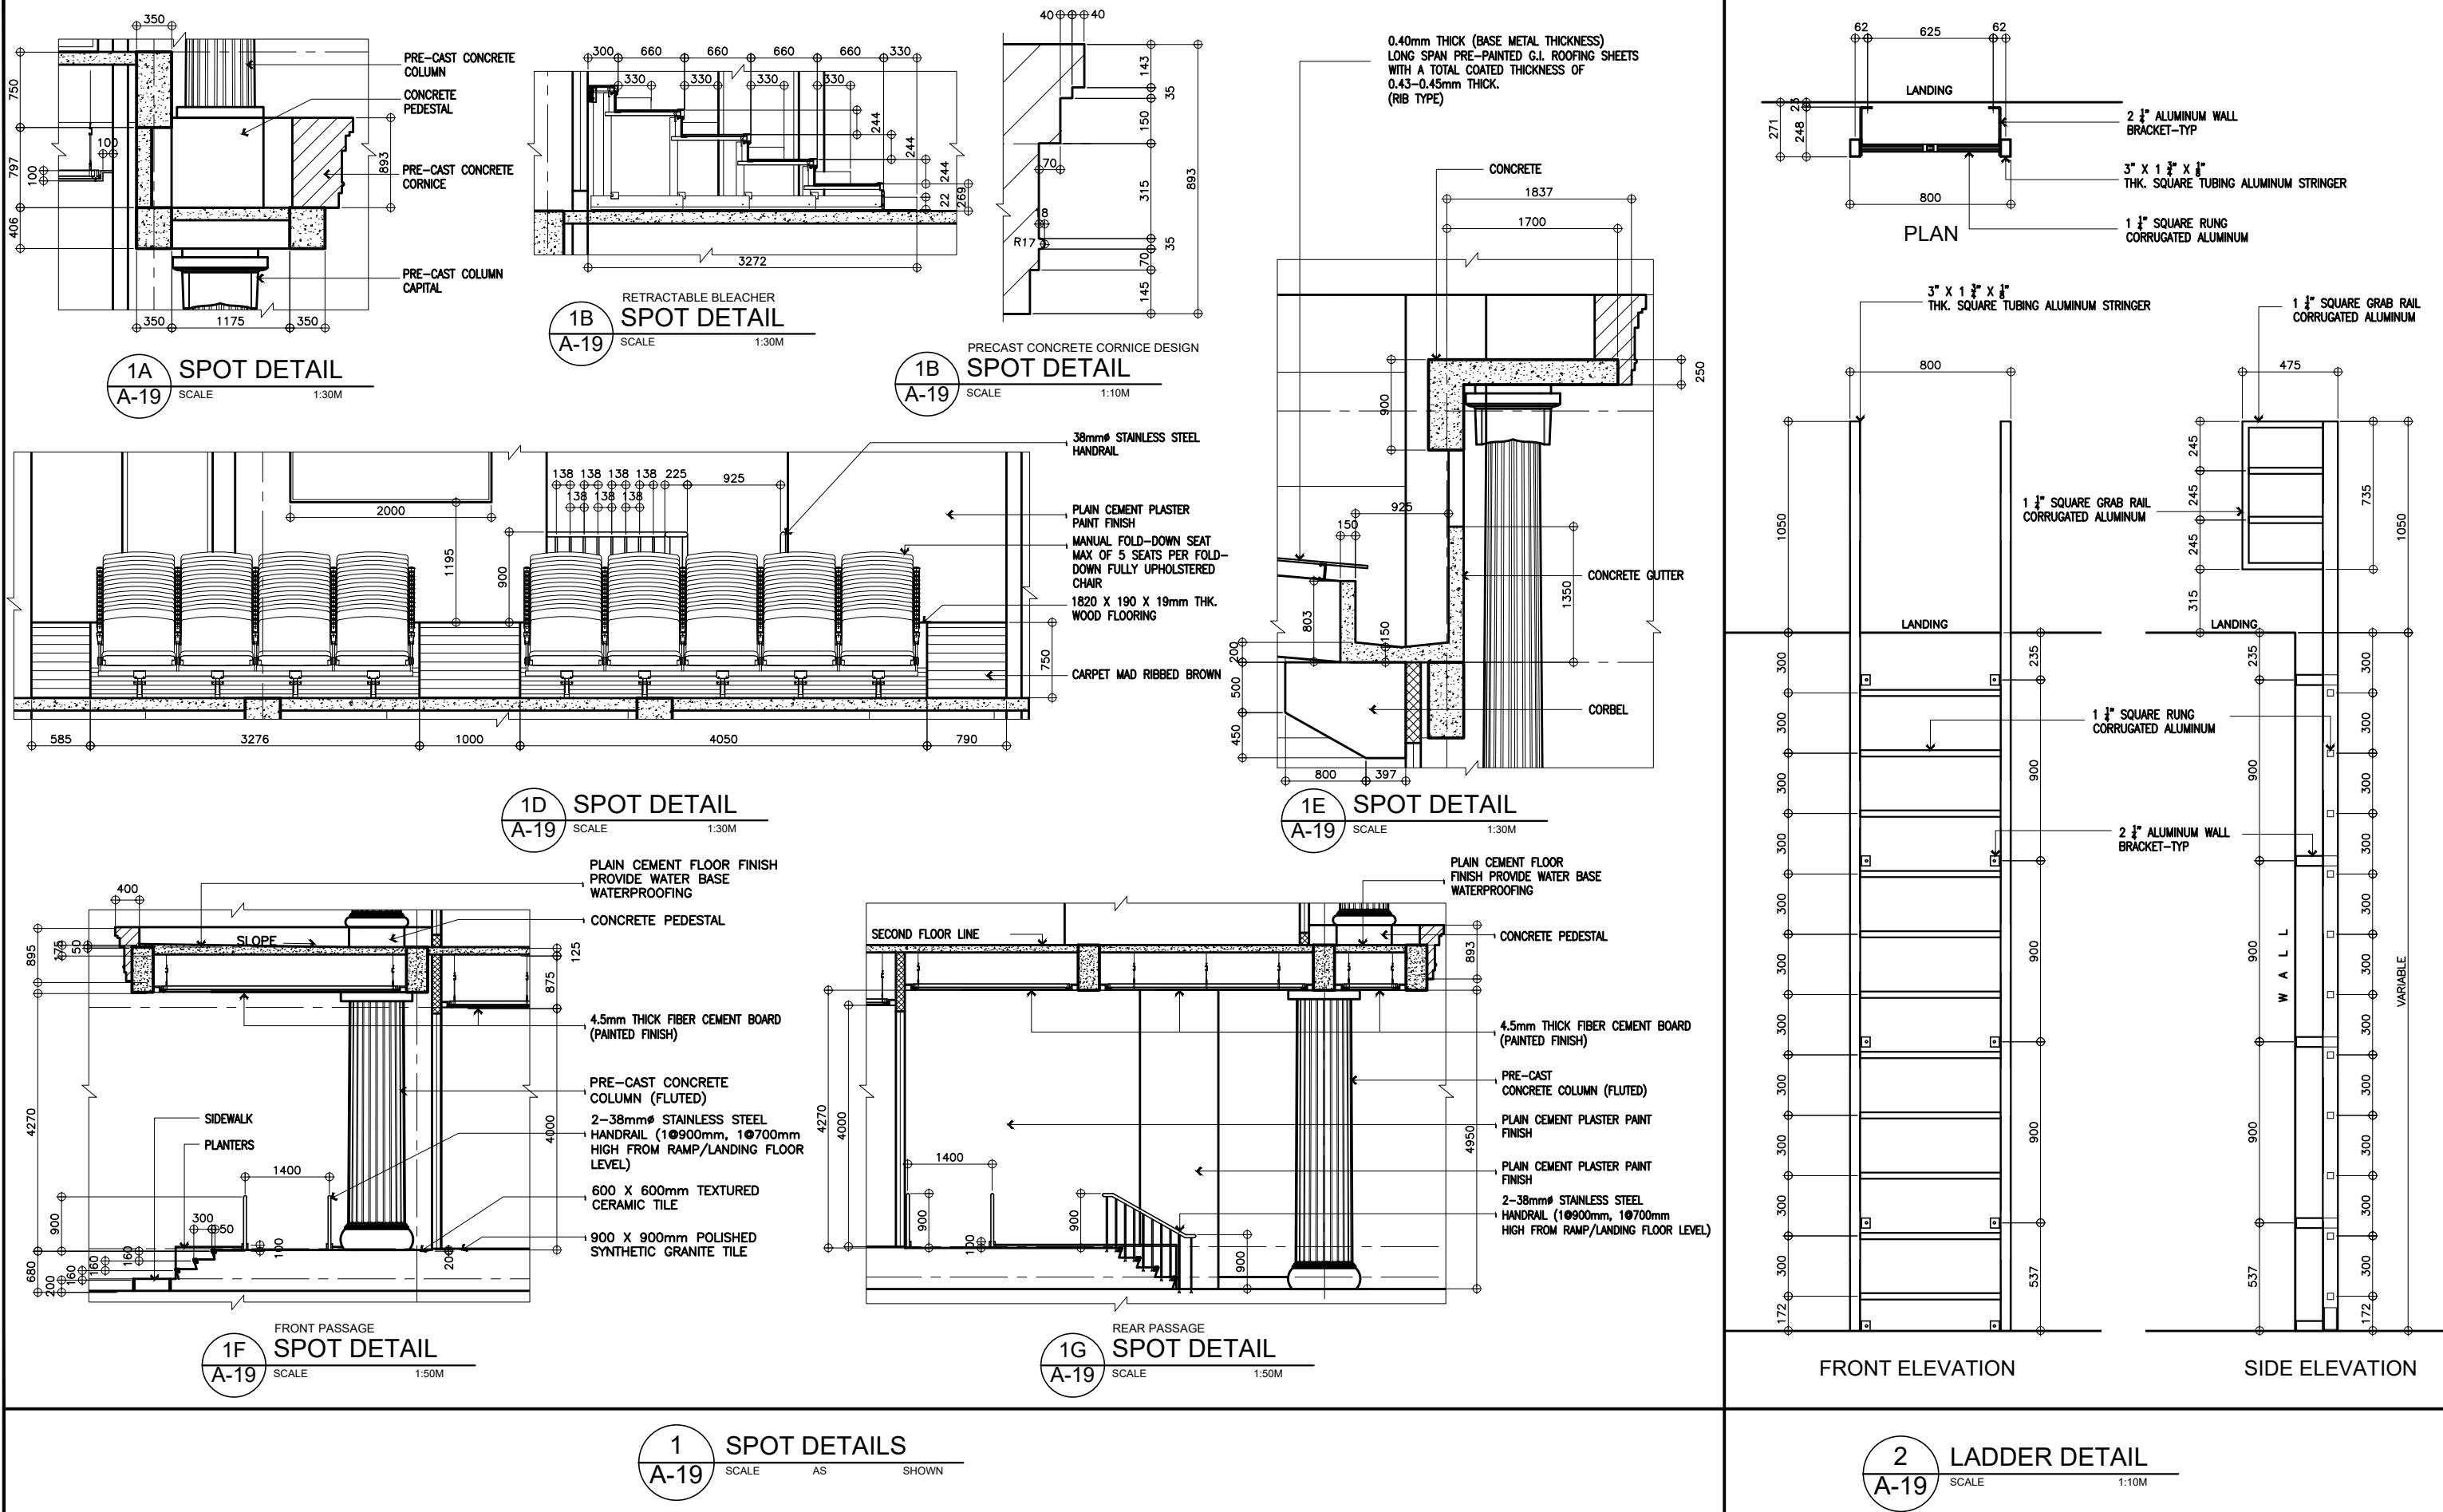CEILING FINISHES:

- CL1** EXPOSED UNDERSIDE OF CONCRETE SLAB (PAINTED FINISH)
 - CL2** 4.5mm THICK FIBER CEMENT BOARD (PAINTED) ON METAL FURRING CHANNELS @ 400mm O.C. B.W.
 - CL3** EXPOSED UNDERSIDE OF ROOFING INSULATION
 - CL4** FABRIC WRAPPED ACOUSTICAL CEILING PANELS

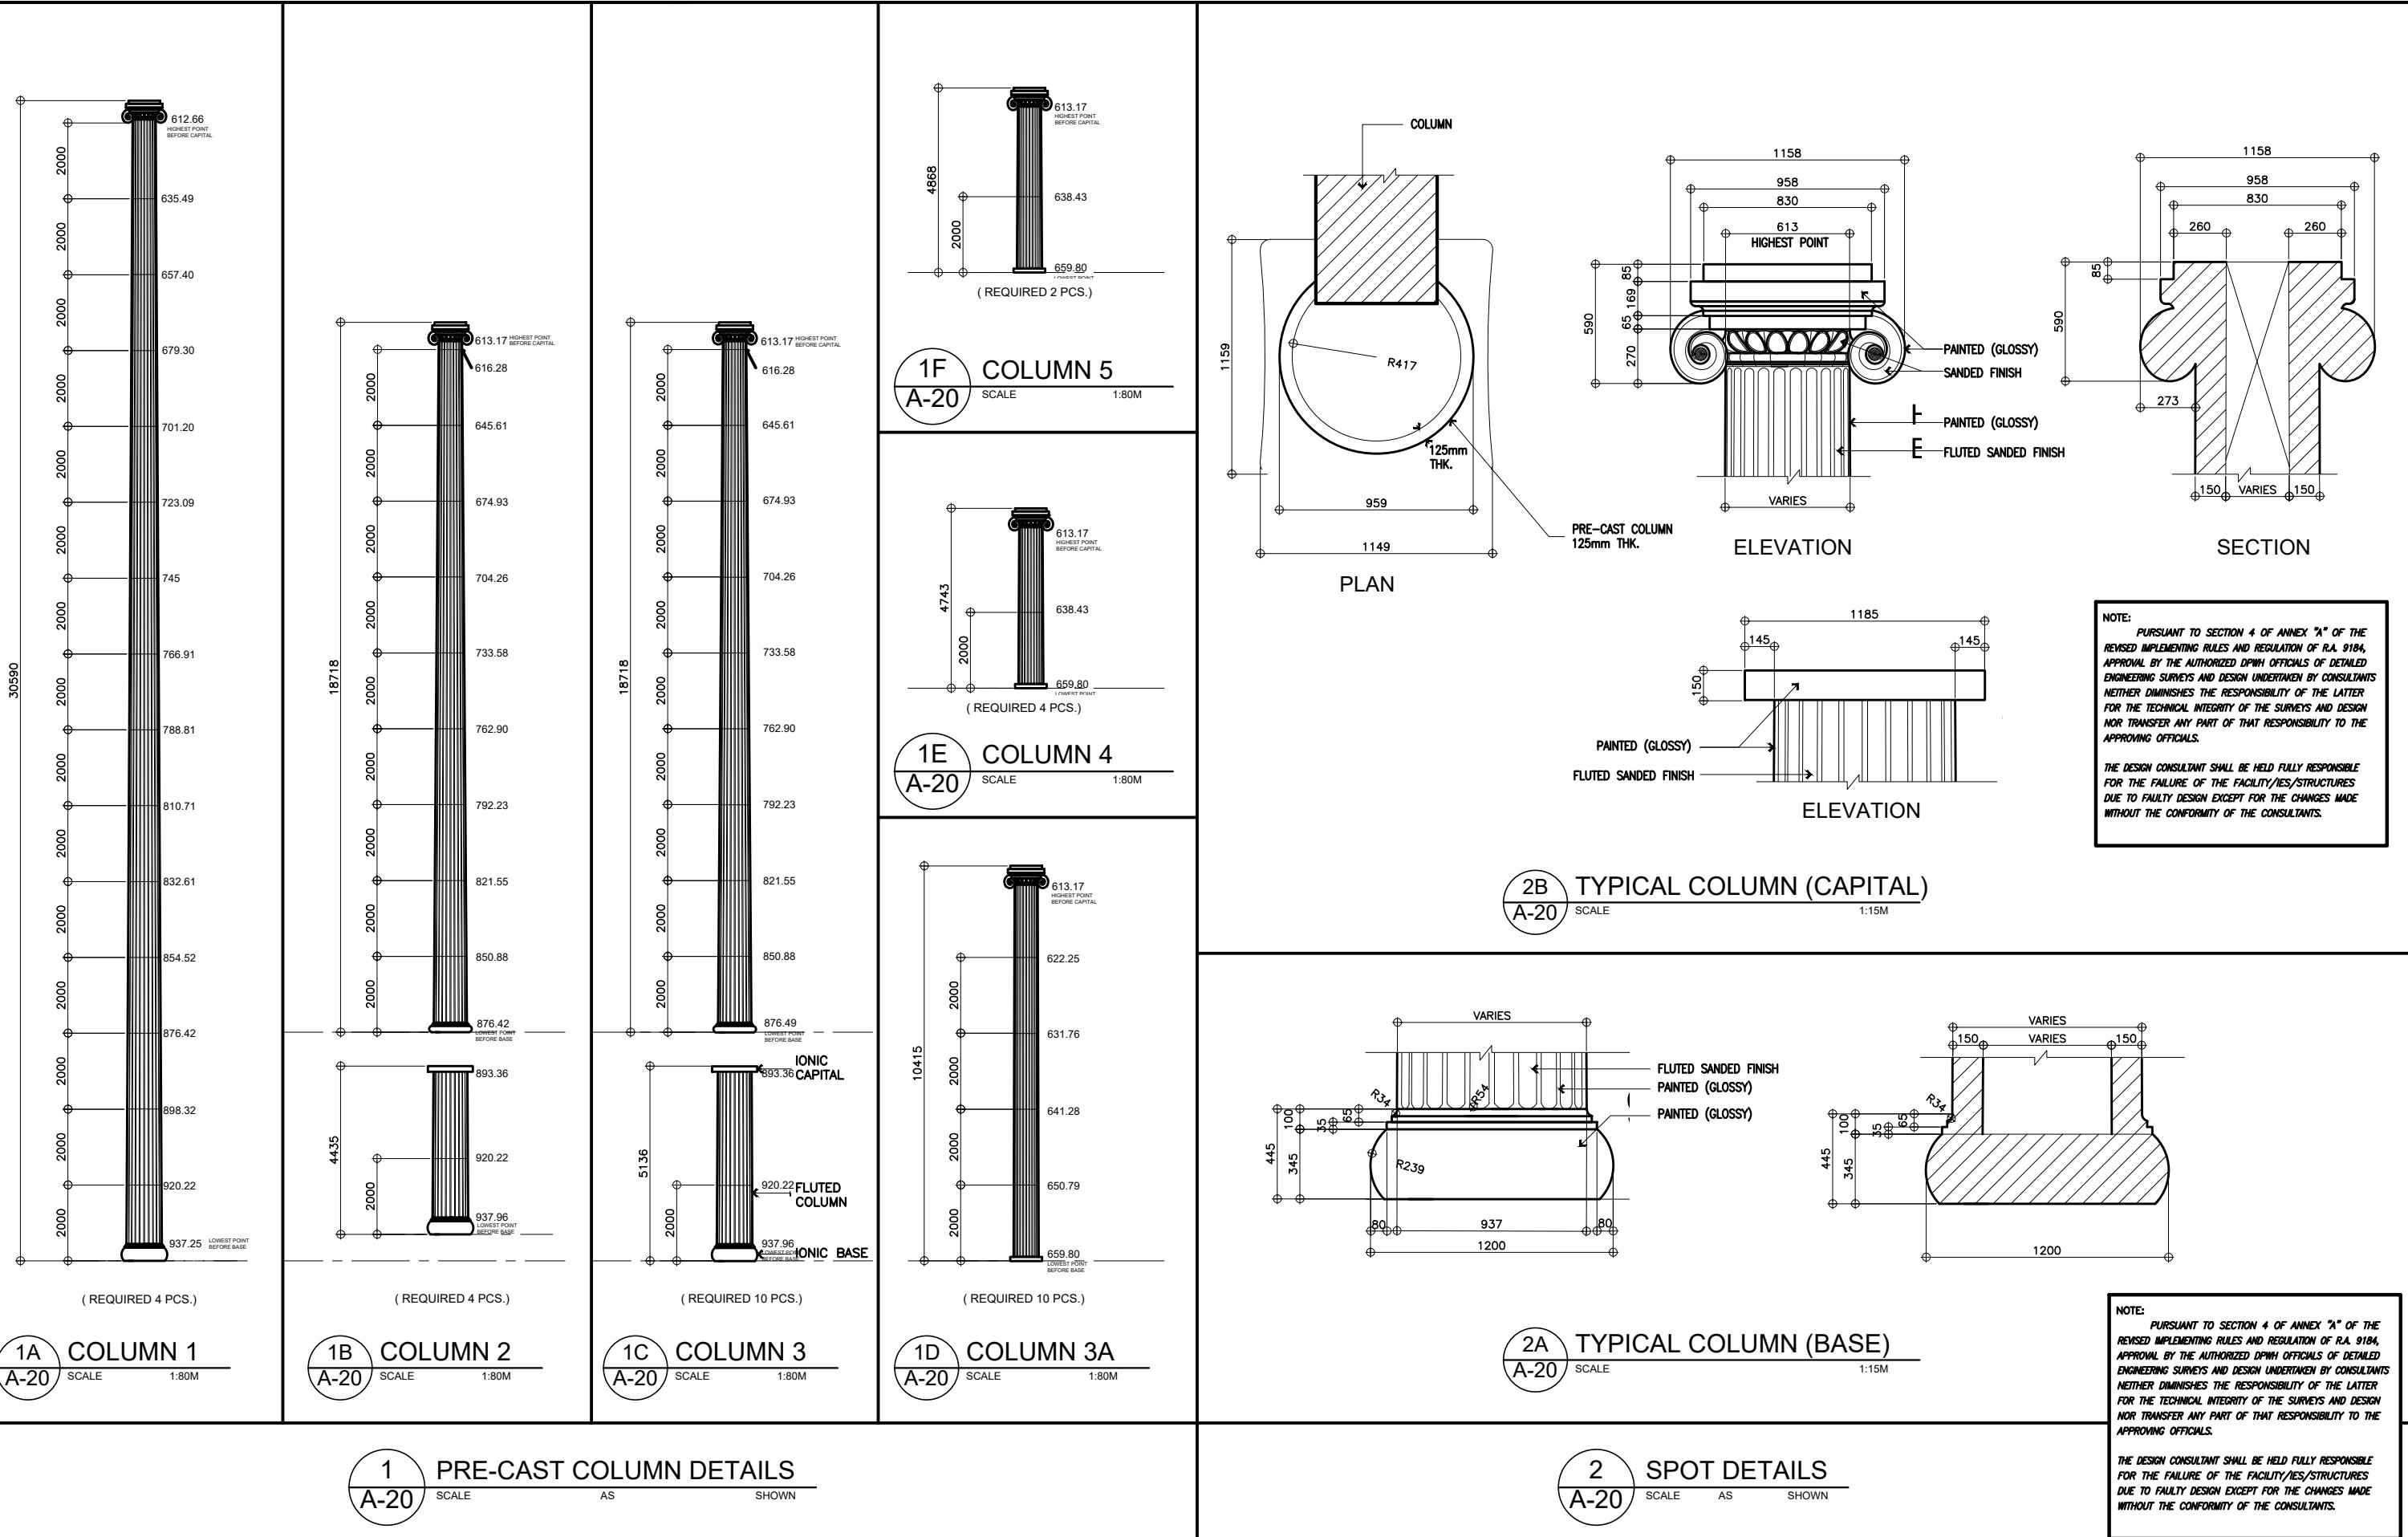LEGEND:



1 GROUND FLOOR REFLECTED CEILING PLAN
A-21 SCALE 1:100M

UNITED TECHNOLOGIES CONSOLIDATED PARTNERSHIP	PREPARED BY:	SUBMITTED BY:	 REPUBLIC OF THE PHILIPPINES DEPARTMENT OF PUBLIC WORKS AND HIGHWAYS BUREAU OF DESIGN BUILDINGS DIVISION BONIFACIO DRIVE PORT AREA, MANILA	REVIEWED AS TO DESIGN CONCEPT:	RECOMMENDING APPROVAL:	APPROVED:	CONCURRED:	PROJECT & LOCATION / BARANGAY:	SHEET CONTENTS:	SET NO.	SHEET NO.
	ARMAN U. CUEVAS	CYNTHIA CLEMEN A. YU		JOSEPHINE P. ISTURIS	(SEE COVER SHEET)	(SEE COVER SHEET)	(SEE COVER SHEET)	(SEE COVER SHEET)	PROPOSED: PROPOSED SEVEN (7) STOREY GOVERNMENT PROCUREMENT POLICY BOARD (GPPB) UP DILIMAN COMPOUND, DILIMAN, QUEZON CITY	GROUND FLOOR REFLECTED CEILING PLAN	
	ARCHITECTURAL DESIGN POSITION: ARCHITECT PRC No.: 0018676 TIN No.: 907-359-364 PTR No.: 4020896	ARCHITECT/TEAM LEADER		CHIEF, BUILDINGS DIVISION, BOD	OFFICER-IN-CHARGE	UNDERSECRETARY FOR UPMO OPERATIONS & TECHNICAL SERVICES	EXECUTIVE DIRECTOR				

CEILING FINISHES:

- (CL1) EXPOSED UNDERSIDE OF CONCRETE SLAB (PAINTED FINISH)
- (CL2) 4.5mm THICK FIBER CEMENT BOARD (PAINTED) ON METAL FURRING CHANNELS @ 400mm O.C. B.W.
- (CL3) EXPOSED UNDERSIDE OF ROOFING INSULATION
- (CL4) FABRIC WRAPPED ACOUSTICAL CEILING PANELS

LEGEND:

- LED DOWNLIGHT
- LED LIGHT
- ◆ LED LIGHT
- LINKABLE LED LINEAR BAR LIGHT
- DRUM PENDANT CHANDELIER LED BULB
- FLOURESCENT LIGHT RECESSED TYPE


 1
A-22


SECOND FLOOR REFLECTED CEILING PLAN

SCALE

1:100M


 UNITED TECHNOLOGIES
CONSOLIDATED PARTNERSHIP

 PREPARED BY:
ARMAN U. CUEVAS
POSITION: ARCHITECT
PRC No.: 0018679 TIN No.: 907-359-364
PTR No.: 4020896

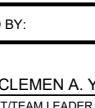 SUBMITTED BY:
CYNTHIA CLEMEN A. YU
POSITION: TEAM LEADER

 REPUBLIC OF THE PHILIPPINES
DEPARTMENT OF PUBLIC WORKS AND HIGHWAYS
BUREAU OF DESIGN
BUILDINGS DIVISION
BONIFACIO DRIVE PORT AREA, MANILA

 REVIEWED AS TO
DESIGN CONCEPT:

 JOSEPHINE P. ISTURIS
CHIEF,
BUILDINGS DIVISION, BOD

 RECOMMENDING
APPROVAL:
(SEE COVER SHEET)

 LEA N. DELFINADO, CESO IV
OFFICER-IN-CHARGE

 APPROVED:
(SEE COVER SHEET)

 EMIL K. SADAIN, CESO I
UNDERSECRETARY FOR UPMO
OPERATIONS & TECHNICAL SERVICES

 CONCURRED:
(SEE COVER SHEET)

 ROWENA CANDICE M. RUIZ
EXECUTIVE DIRECTOR

 PROPOSED:

 PROPOSED SEVEN (7) STOREY
GOVERNMENT PROCUREMENT POLICY
BOARD (GPPB)
UP DILIMAN COMPOUND, DILIMAN,
QUEZON CITY

PROJECT & LOCATION / BARANGAY:

 SECOND FLOOR REFLECTED
CEILING PLAN

SHEET CONTENTS:

 SECOND FLOOR REFLECTED
CEILING PLAN

SET NO.

 BOD
A-22

SHEET NO.


 24
216

CEILING FINISHES:

- (CL1) EXPOSED UNDERSIDE OF CONCRETE SLAB (PAINTED FINISH)
- (CL2) 4.5mm THICK FIBER CEMENT BOARD (PAINTED) ON METAL FURRING CHANNELS @ 400mm O.C. B.W.
- (CL3) EXPOSED UNDERSIDE OF ROOFING INSULATION
- (CL4) FABRIC WRAPPED ACOUSTICAL CEILING PANELS

LEGEND:

- LED DOWNLIGHT
- LED LIGHT
- ◆ LED LIGHT
- LINKABLE LED LINEAR BAR LIGHT
-  DRUM PENDANT CHANDELIER
-  LED BULB
-  FLUORESCENT LIGHT RECESSED TYPE

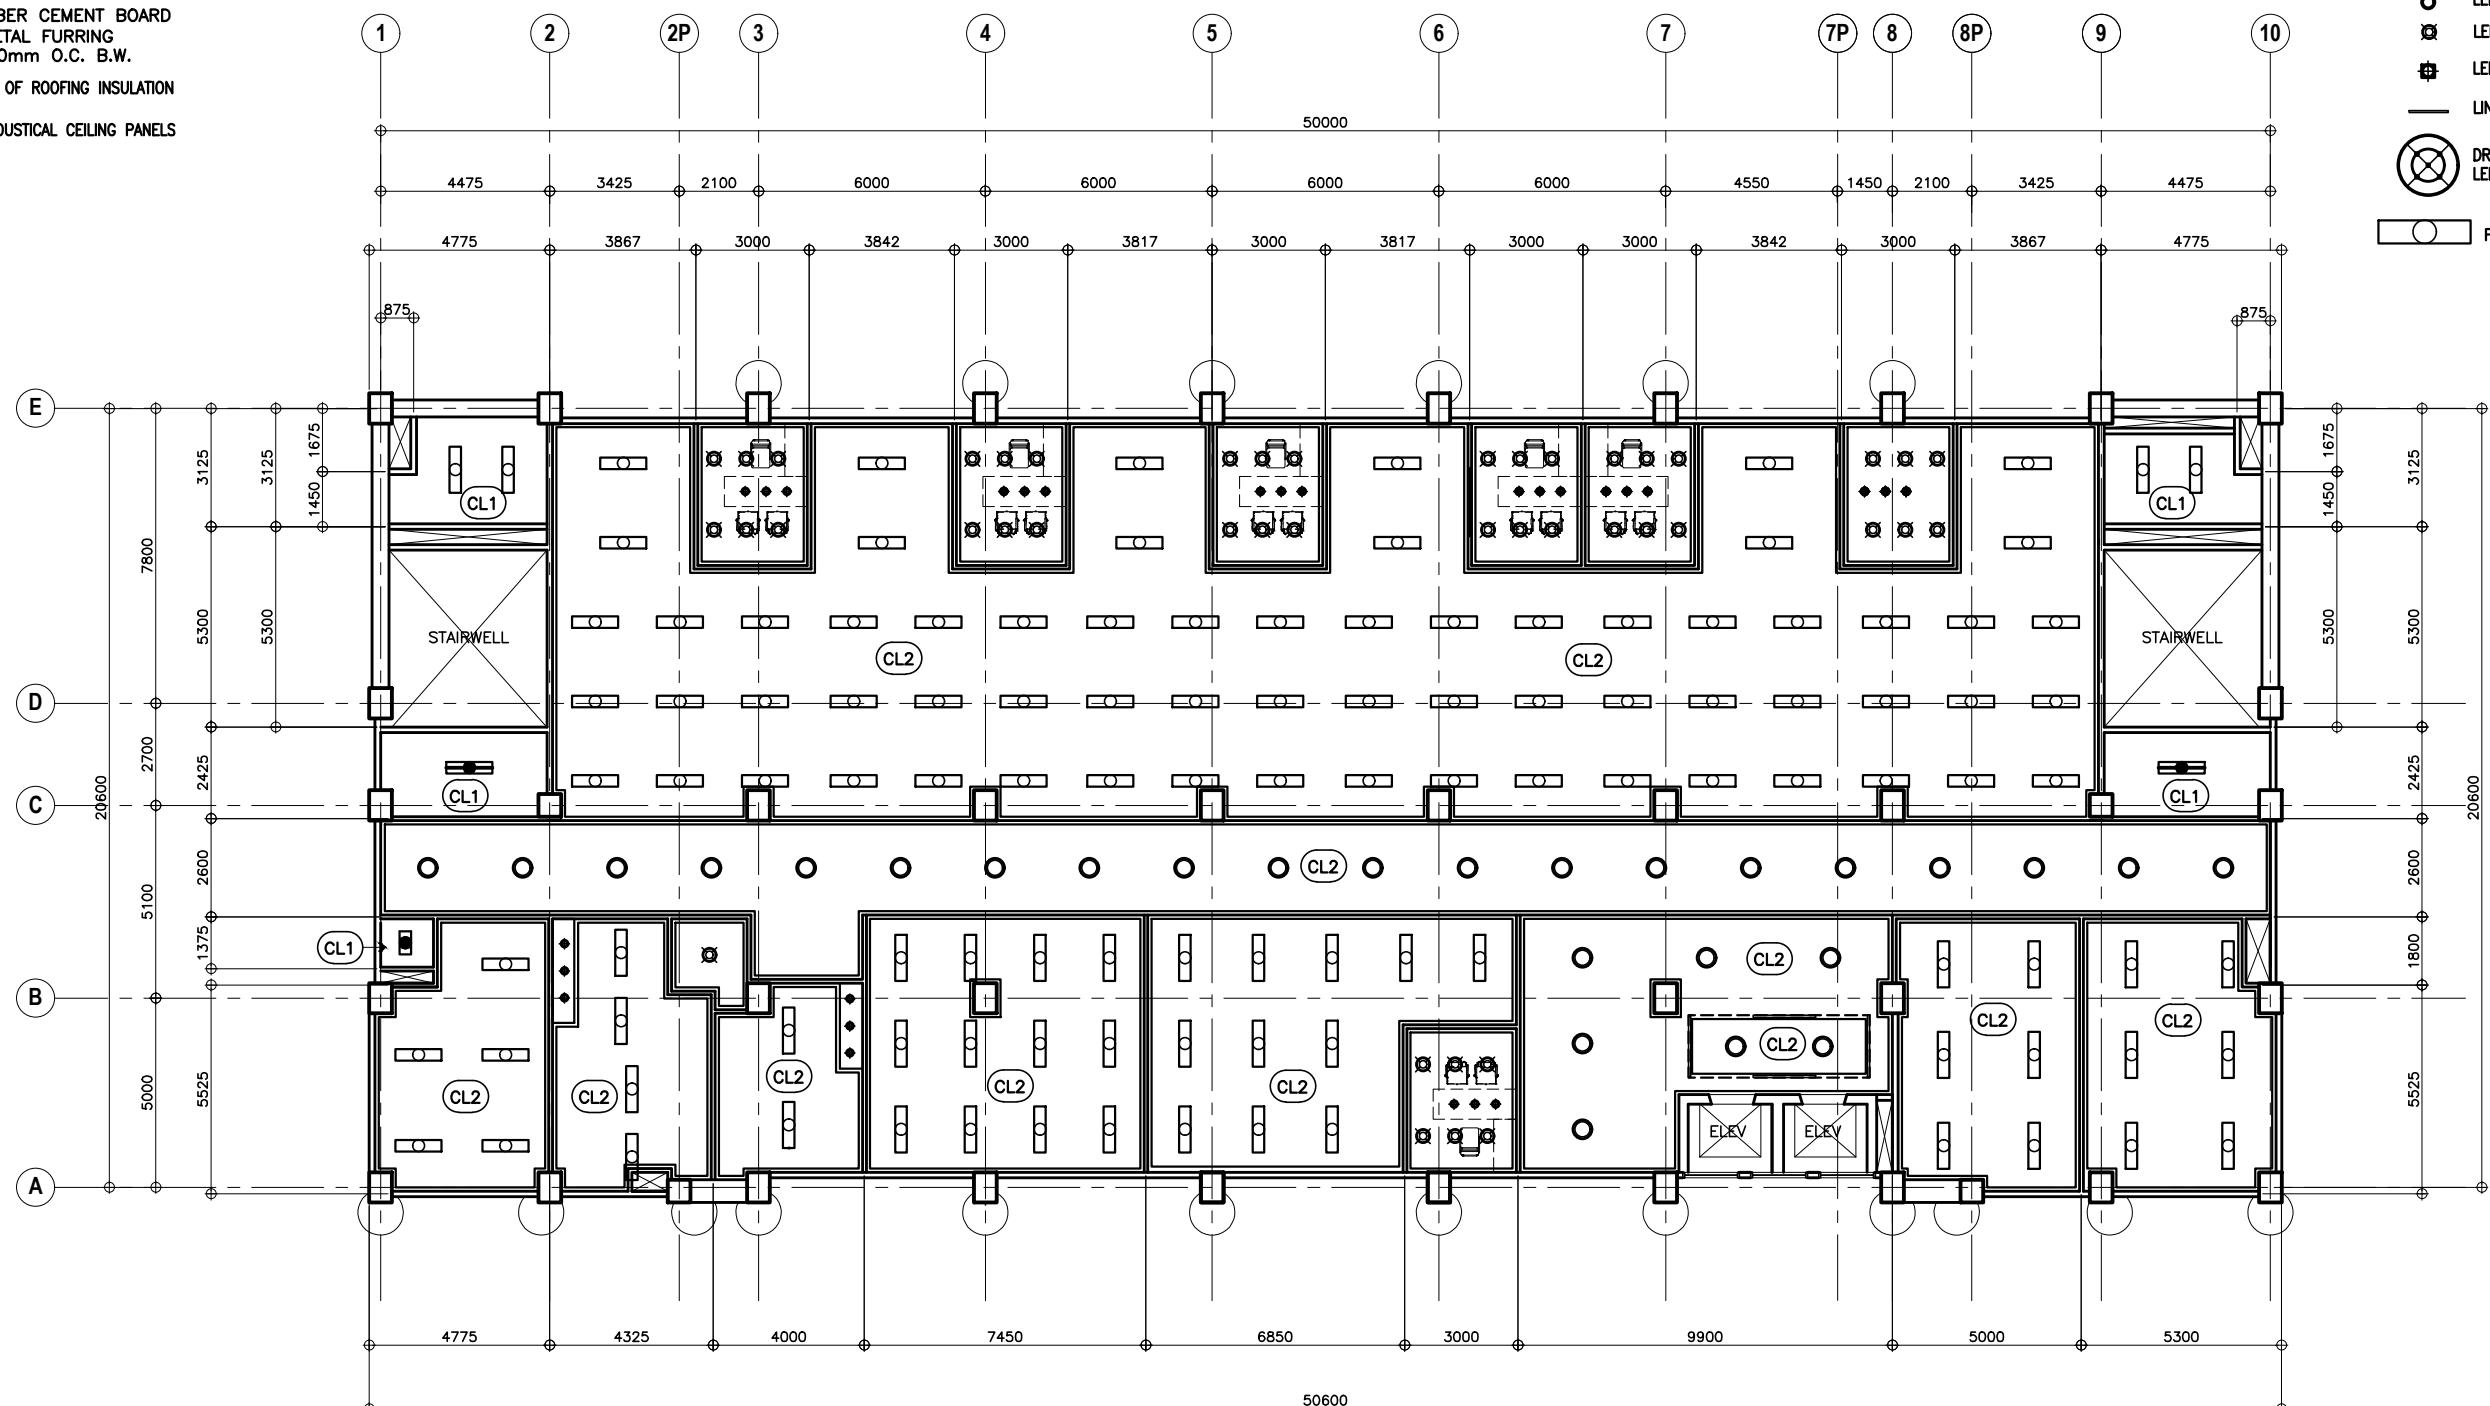
 1
A-23

THIRD FLOOR REFLECTED CEILING PLAN

SCALE


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**UNITED TECHNOLOGIES
CONSOLIDATED PARTNERSHIP**

PREPARED BY:

 ARMAN U. CUEVAS
ARCHITECTURAL DESIGN POSITION: ARCHITECT
PRC No.: 0018679 TIN No.: 907-359-364
PTR No.: 4020896

SUBMITTED BY:

 CYNTHIA CLEMEN A. YU
ARCHITECT/TEAM LEADER

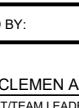 REPUBLIC OF THE PHILIPPINES
 DEPARTMENT OF PUBLIC WORKS AND HIGHWAYS
BUREAU OF DESIGN
 BUILDINGS DIVISION
 BONIFACIO DRIVE PORT AREA, MANILA
REVIEWED AS TO
DESIGN CONCEPT:
 JOSEPHINE P. ISTURIS
CHIEF,
BUILDINGS DIVISION, BOD
RECOMMENDING
APPROVAL:
 (SEE COVER SHEET)
 LEA N. DELFINADO, CESO IV
OFFICER-IN-CHARGE

APPROVED:

 (SEE COVER SHEET)
 EMIL K. SADAIN, CESO I
UNDERSECRETARY FOR UPMO
OPERATIONS & TECHNICAL SERVICES

CONCURRED:

 (SEE COVER SHEET)
 ROWENA CANDICE M. RUIZ
EXECUTIVE DIRECTOR

PROJECT & LOCATION / BARANGAY:

 PROPOSED:
 PROPOSED SEVEN (7) STOREY
 GOVERNMENT PROCUREMENT POLICY
 BOARD (GPPB)
 UP DILIMAN COMPOUND, DILIMAN,
 QUEZON CITY

SHEET CONTENTS:

 THIRD FLOOR REFLECTED CEILING
 PLAN

SET NO.


 25
 BOD
 A-23
 216

CEILING FINISHES:

- (CL1) EXPOSED UNDERSIDE OF CONCRETE SLAB (PAINTED FINISH)
- (CL2) 4.5mm THICK FIBER CEMENT BOARD (PAINTED) ON METAL FURRING CHANNELS @ 400mm O.C. B.W.
- (CL3) EXPOSED UNDERSIDE OF ROOFING INSULATION
- (CL4) FABRIC WRAPPED ACOUSTICAL CEILING PANELS

LEGEND:

- LED DOWNLIGHT
- ◎ LED LIGHT
- LED LIGHT
- LINKABLE LED LINEAR BAR LIGHT
-  DRUM PENDANT CHANDELIER
-  LED BULB
-  FLOURESCENT LIGHT RECESSED TYPE

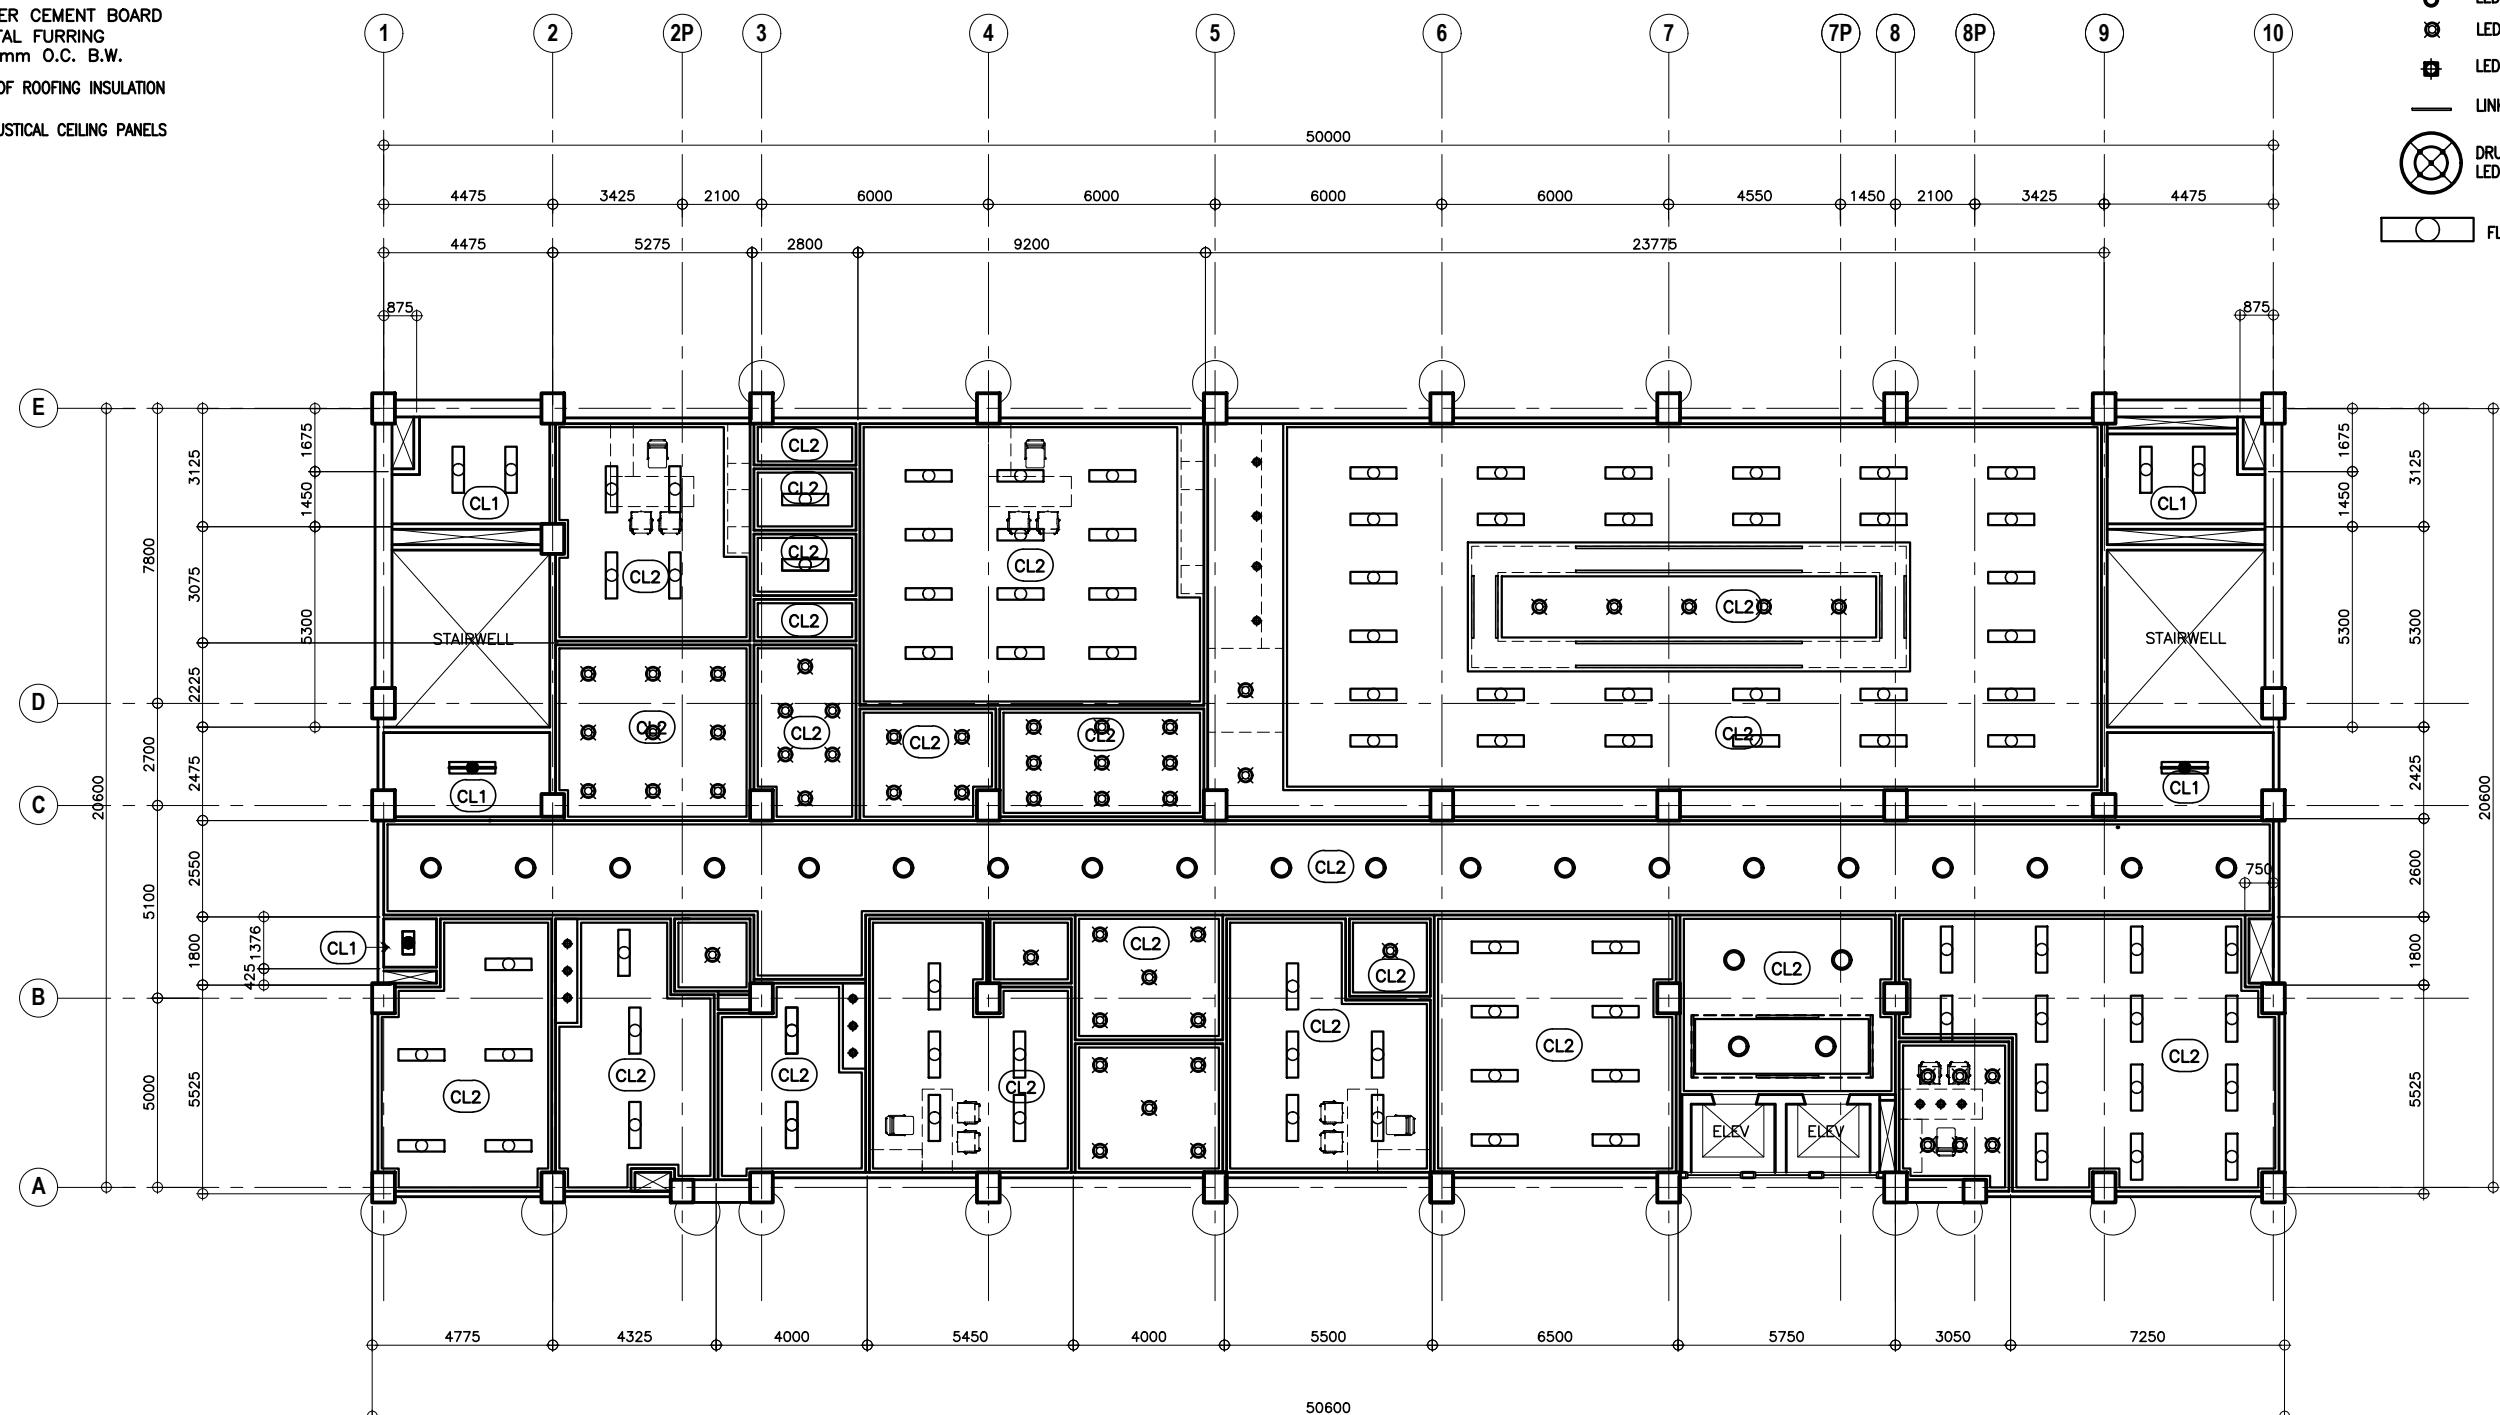
 1
A-24

FOURTH FLOOR REFLECTED CEILING PLAN

SCALE


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**UNITED TECHNOLOGIES
CONSOLIDATED PARTNERSHIP**

PREPARED BY:

 ARMAN U. CUEVAS
POSITION: ARCHITECT
PRC No.: 0018679 TIN No.: 907-359-364
PTR No.: 4020896

SUBMITTED BY:

 CYNTHIA CLEMEN A. YU
POSITION: TEAM LEADER

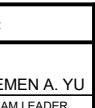 REPUBLIC OF THE PHILIPPINES
 DEPARTMENT OF PUBLIC WORKS AND HIGHWAYS
BUREAU OF DESIGN
 BUILDINGS DIVISION
 BONIFACIO DRIVE PORT AREA, MANILA
REVIEWED AS TO
DESIGN CONCEPT:
 JOSEPHINE P. ISTURIS
CHIEF,
BUILDINGS DIVISION, BOD
RECOMMENDING
APPROVAL:
 (SEE COVER SHEET)
 LEA N. DELFINADO, CESO IV
OFFICER-IN-CHARGE

APPROVED:

 (SEE COVER SHEET)
 EMIL K. SADAIN, CESO I
UNDERSECRETARY FOR UPMO
OPERATIONS & TECHNICAL SERVICES

CONCURRED:

 (SEE COVER SHEET)
 ROWENA CANDICE M. RUIZ
EXECUTIVE DIRECTOR

PROJECT & LOCATION / BARANGAY:

 PROPOSED:
 PROPOSED SEVEN (7) STOREY
 GOVERNMENT PROCUREMENT POLICY
 BOARD (GPPB)
 UP DILIMAN COMPOUND, DILIMAN,
 QUEZON CITY

SHEET CONTENTS:

 FOURTH FLOOR REFLECTED
 CEILING PLAN

SET NO.

 BOD
 A-24

SHEET NO.


 26
 216

CEILING FINISHES:

- (CL1) EXPOSED UNDERSIDE OF CONCRETE SLAB (PAINTED FINISH)
- (CL2) 4.5mm THICK FIBER CEMENT BOARD (PAINTED) ON METAL FURRING CHANNELS @ 400mm O.C. B.W.
- (CL3) EXPOSED UNDERSIDE OF ROOFING INSULATION
- (CL4) FABRIC WRAPPED ACOUSTICAL CEILING PANELS

LEGEND:

- LED DOWNLIGHT
- ◎ LED LIGHT
- LED LIGHT
- LINKABLE LED LINEAR BAR LIGHT
- DRUM PENDANT CHANDELIER
- LED BULB
- FLOURESCENT LIGHT RECESSED TYPE

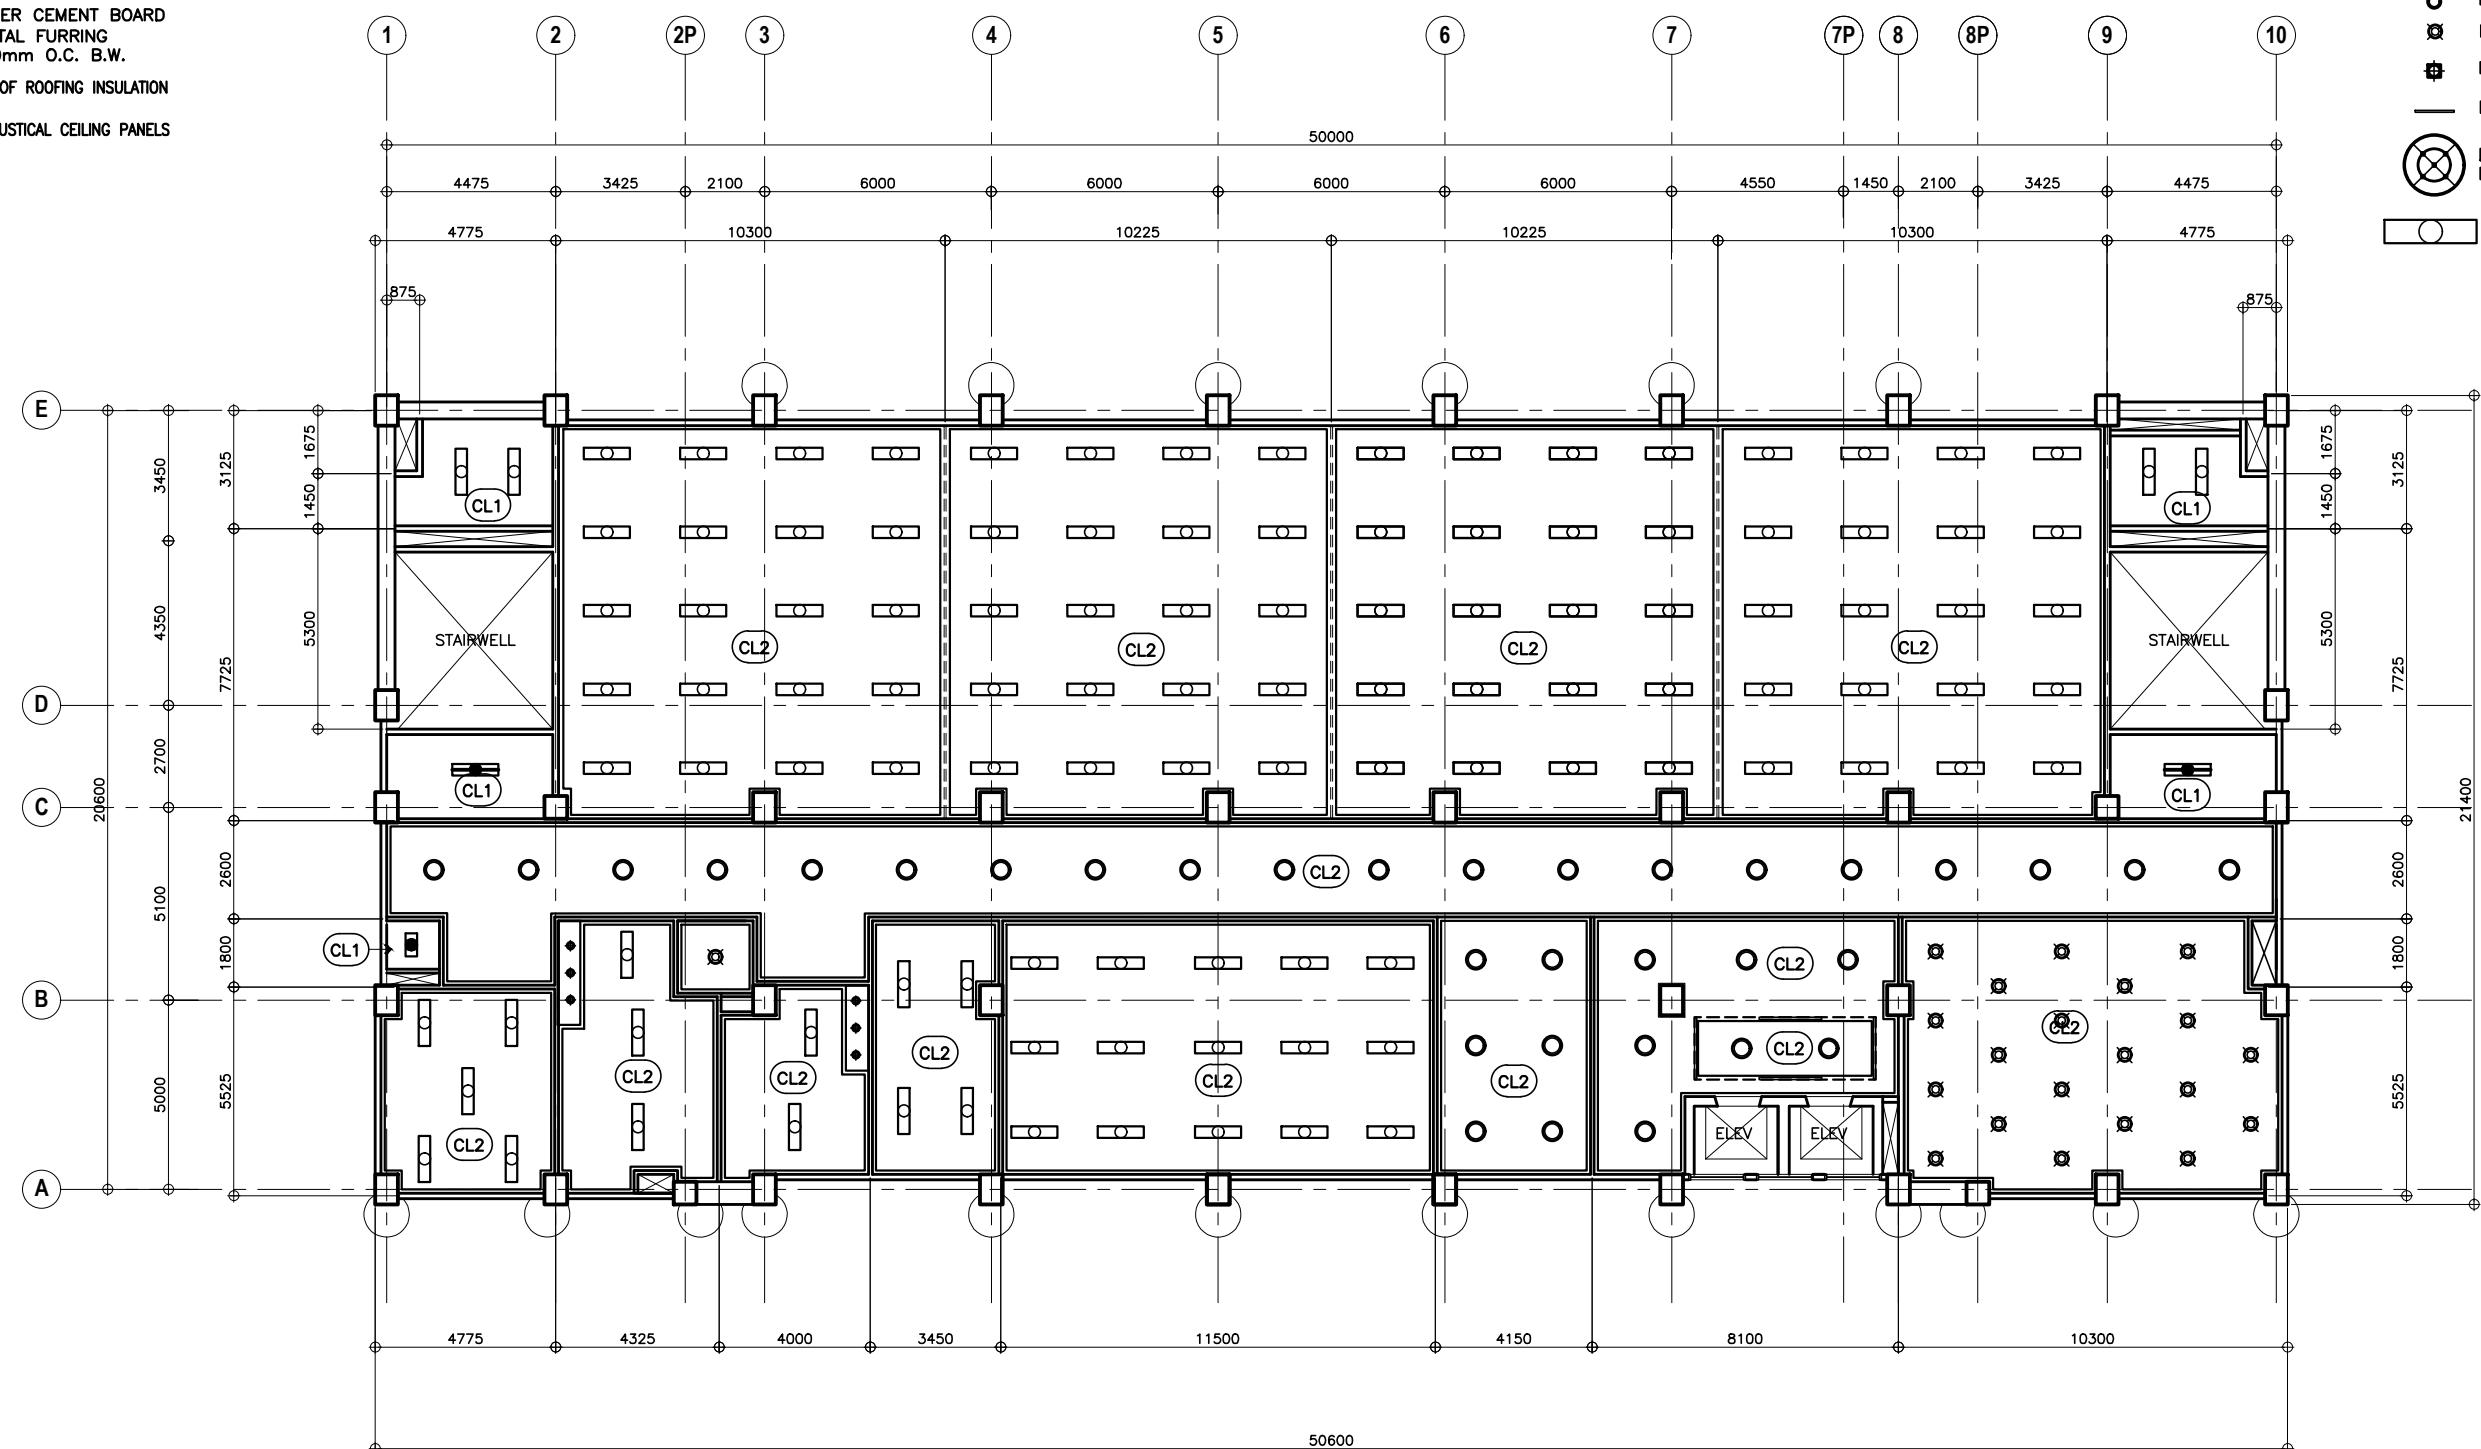
 1
A-25


FIFTH FLOOR REFLECTED CEILING PLAN

SCALE

1:100M


 UNITED TECHNOLOGIES
CONSOLIDATED PARTNERSHIP

 PREPARED BY:
ARMAN U. CUEVAS
ARCHITECTURAL DESIGN
POSITION: ARCHITECT
PRC No.: 0018679 TIN No.: 907-359-364
PTR No.: 4020896

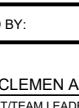 SUBMITTED BY:
CYNTHIA CLEMEN A. YU
ARCHITECT/TEAM LEADER

 REPUBLIC OF THE PHILIPPINES
DEPARTMENT OF PUBLIC WORKS AND HIGHWAYS
BUREAU OF DESIGN
BUILDINGS DIVISION
BONIFACIO DRIVE PORT AREA, MANILA

 REVIEWED AS TO
DESIGN CONCEPT:

 JOSEPHINE P. ISTURIS
CHIEF,
BUILDINGS DIVISION, BOD

 RECOMMENDING
APPROVAL:

 (SEE COVER SHEET)
LEA N. DELFINADO, CESO IV
OFFICER-IN-CHARGE

APPROVED:

 (SEE COVER SHEET)
EMIL K. SADAIN, CESO I
UNDERSECRETARY FOR UPMO
OPERATIONS & TECHNICAL SERVICES

CONCURRED:

 (SEE COVER SHEET)
ROWENA CANDICE M. RUIZ
EXECUTIVE DIRECTOR

PROJECT & LOCATION / BARANGAY:

 PROPOSED SEVEN (7) STOREY
GOVERNMENT PROCUREMENT POLICY
BOARD (GPPB)
UP DILIMAN COMPOUND, DILIMAN,
QUEZON CITY

SHEET CONTENTS:

 FIFTH FLOOR REFLECTED CEILING
PLAN

SET NO.

 BOD
A-25



SHEET NO.

 27
216

CEILING FINISHES:

- CL1** EXPOSED UNDERSIDE OF CONCRETE SLAB (PAINTED FINISH)
 - CL2** 4.5mm THICK FIBER CEMENT BOARD (PAINTED) ON METAL FURRING CHANNELS @ 400mm O.C. B.W.
 - CL3** EXPOSED UNDERSIDE OF ROOFING INSULATION
 - CL4** FABRIC WRAPPED ACOUSTICAL CEILING PANELS

LEGEND:

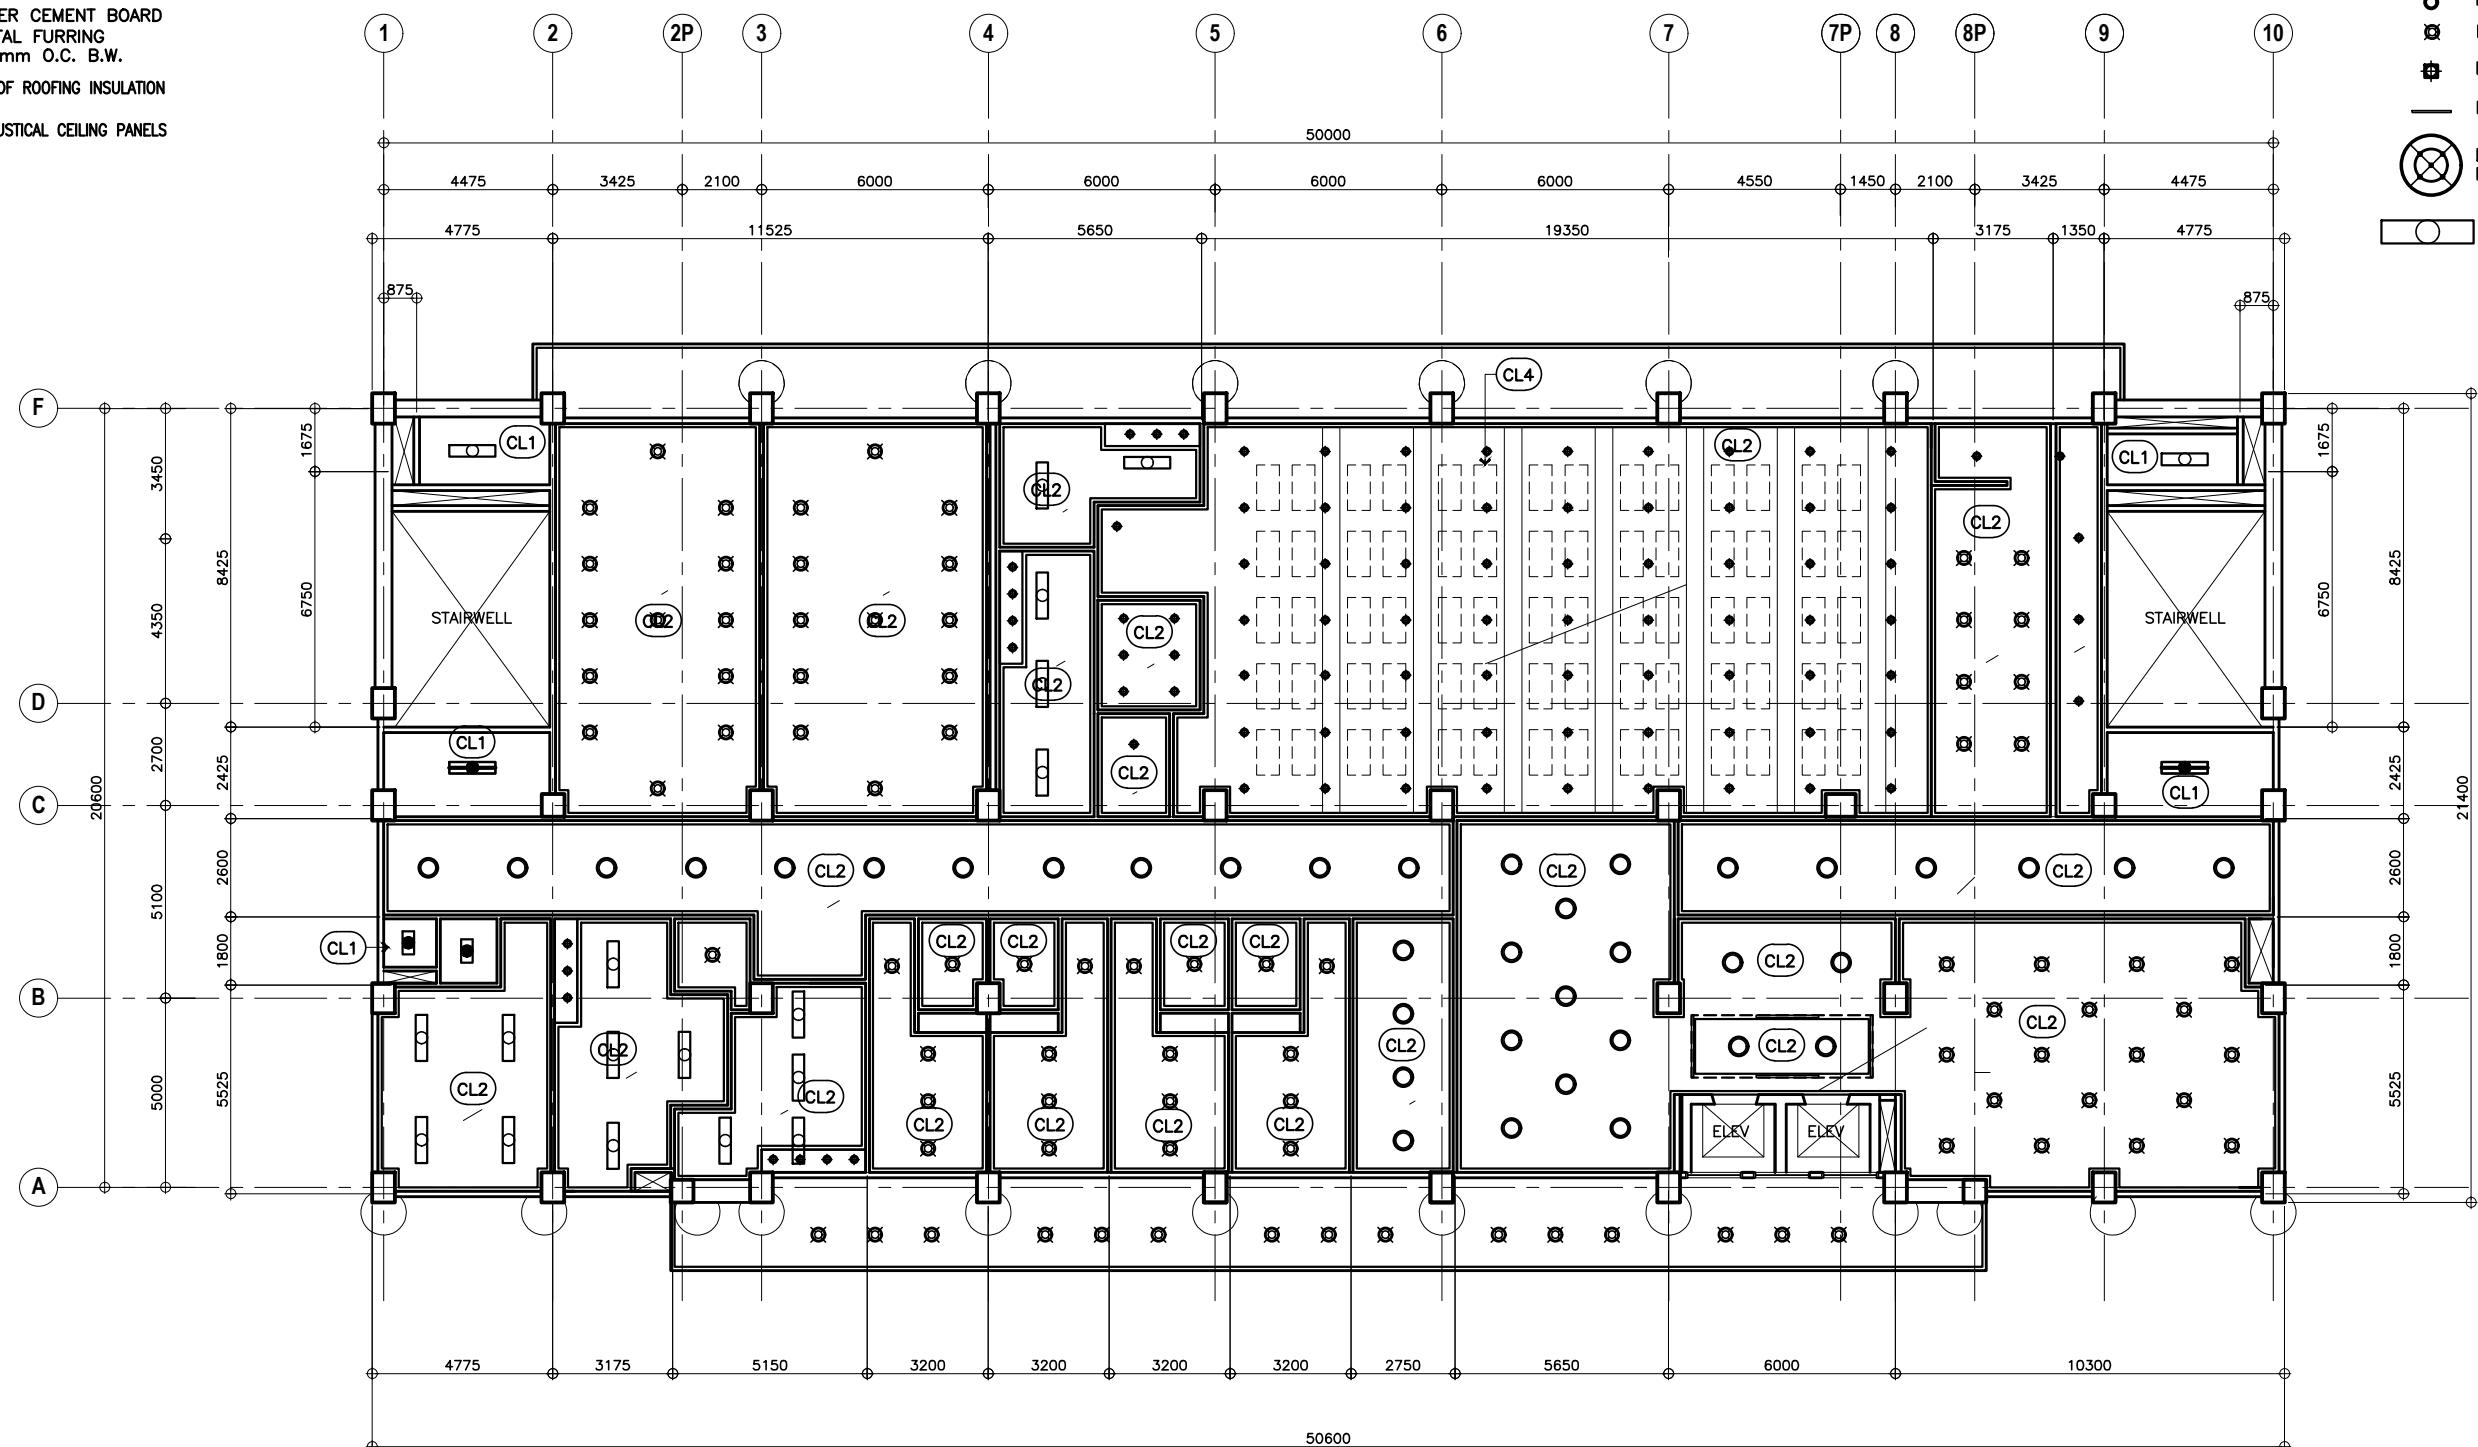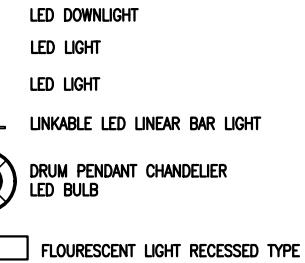

OTE:
PURSUANT TO SECTION 4 OF ANNEX "A" OF THE
REVISED IMPLEMENTING RULES AND REGULATION OF RA. 8184,
APPROVAL BY THE AUTHORIZED DPMW OFFICIALS OF DETAILED
ENGINEERING SURVEYS AND DESIGN UNDERTAKEN BY CONSULTANTS
NEITHER DIMINISHES THE RESPONSIBILITY OF THE LATTER
FOR THE TECHNICAL INTEGRITY OF THE SURVEYS AND DESIGN
NOR TRANSFER ANY PART OF THAT RESPONSIBILITY TO THE
APPROVING OFFICIALS.

THE DESIGN CONSULTANT SHALL BE HELD FULLY RESPONSIBLE FOR THE FAILURE OF THE FACILITY/IES/STRUCTURES DUE TO FAULTY DESIGN EXCEPT FOR THE CHANGES MADE WITHOUT THE CONFORMITY OF THE CONSULTANTS.



1 SIXTH FLOOR REFLECTED CEILING PLAN
A-26 SCALE 1:100M

UNITED TECHNOLOGIES CONSOLIDATED PARTNERSHIP	PREPARED BY:	SUBMITTED BY:		REPUBLIC OF THE PHILIPPINES DEPARTMENT OF PUBLIC WORKS AND HIGHWAYS BUREAU OF DESIGN BUILDINGS DIVISION BONIFACIO DRIVE PORT AREA, MANILA	REVIEWED AS TO DESIGN CONCEPT:	RECOMMENDING APPROVAL:	APPROVED:	CONCURRED:	PROJECT & LOCATION / BARANGAY:	SHEET CONTENTS:	SET NO.	SHEET NO.
	ARMAN U. CUEVAS	CYNTHIA CLEMEN A. YU							PROPOSED: PROPOSED SEVEN (7) STOREY GOVERNMENT PROCUREMENT POLICY BOARD (GPPB)	SIXTH FLOOR REFLECTED CEILING PLAN		28 216
ARCHITECTURAL DESIGN POSITION: ARCHITECT PRC No.: 0018676 TIN No.: 907-359-364 PTB No.: 4020986	ARCHITECT/TEAM LEADER	JOSEPHINE P. ISTURIS	LEA N. DELFINADO, CESO IV	CHIEF, BUILDINGS DIVISION, BOD	(SEE COVER SHEET) OFFICER-IN-CHARGE	(SEE COVER SHEET) UNDERSECRETARY FOR UPMO OPERATIONS & TECHNICAL SERVICES	EMIL K. SADAIN, CESO I	ROWENA CANDICE M. RUIZ	EXECUTIVE DIRECTOR	UP DILMAM COMPOUND, DILMAM, QUEZON CITY		

CEILING FINISHES:

- CL1** EXPOSED UNDERSIDE OF CONCRETE SLAB (PAINTED FINISH)
 - CL2** 4.5mm THICK FIBER CEMENT BOARD (PAINTED) ON METAL FURRING CHANNELS @ 400mm O.C. B.W.
 - CL3** EXPOSED UNDERSIDE OF ROOFING INSULATION
 - CL4** FABRIC WRAPPED ACOUSTICAL CEILING PANELS

LEGEND:

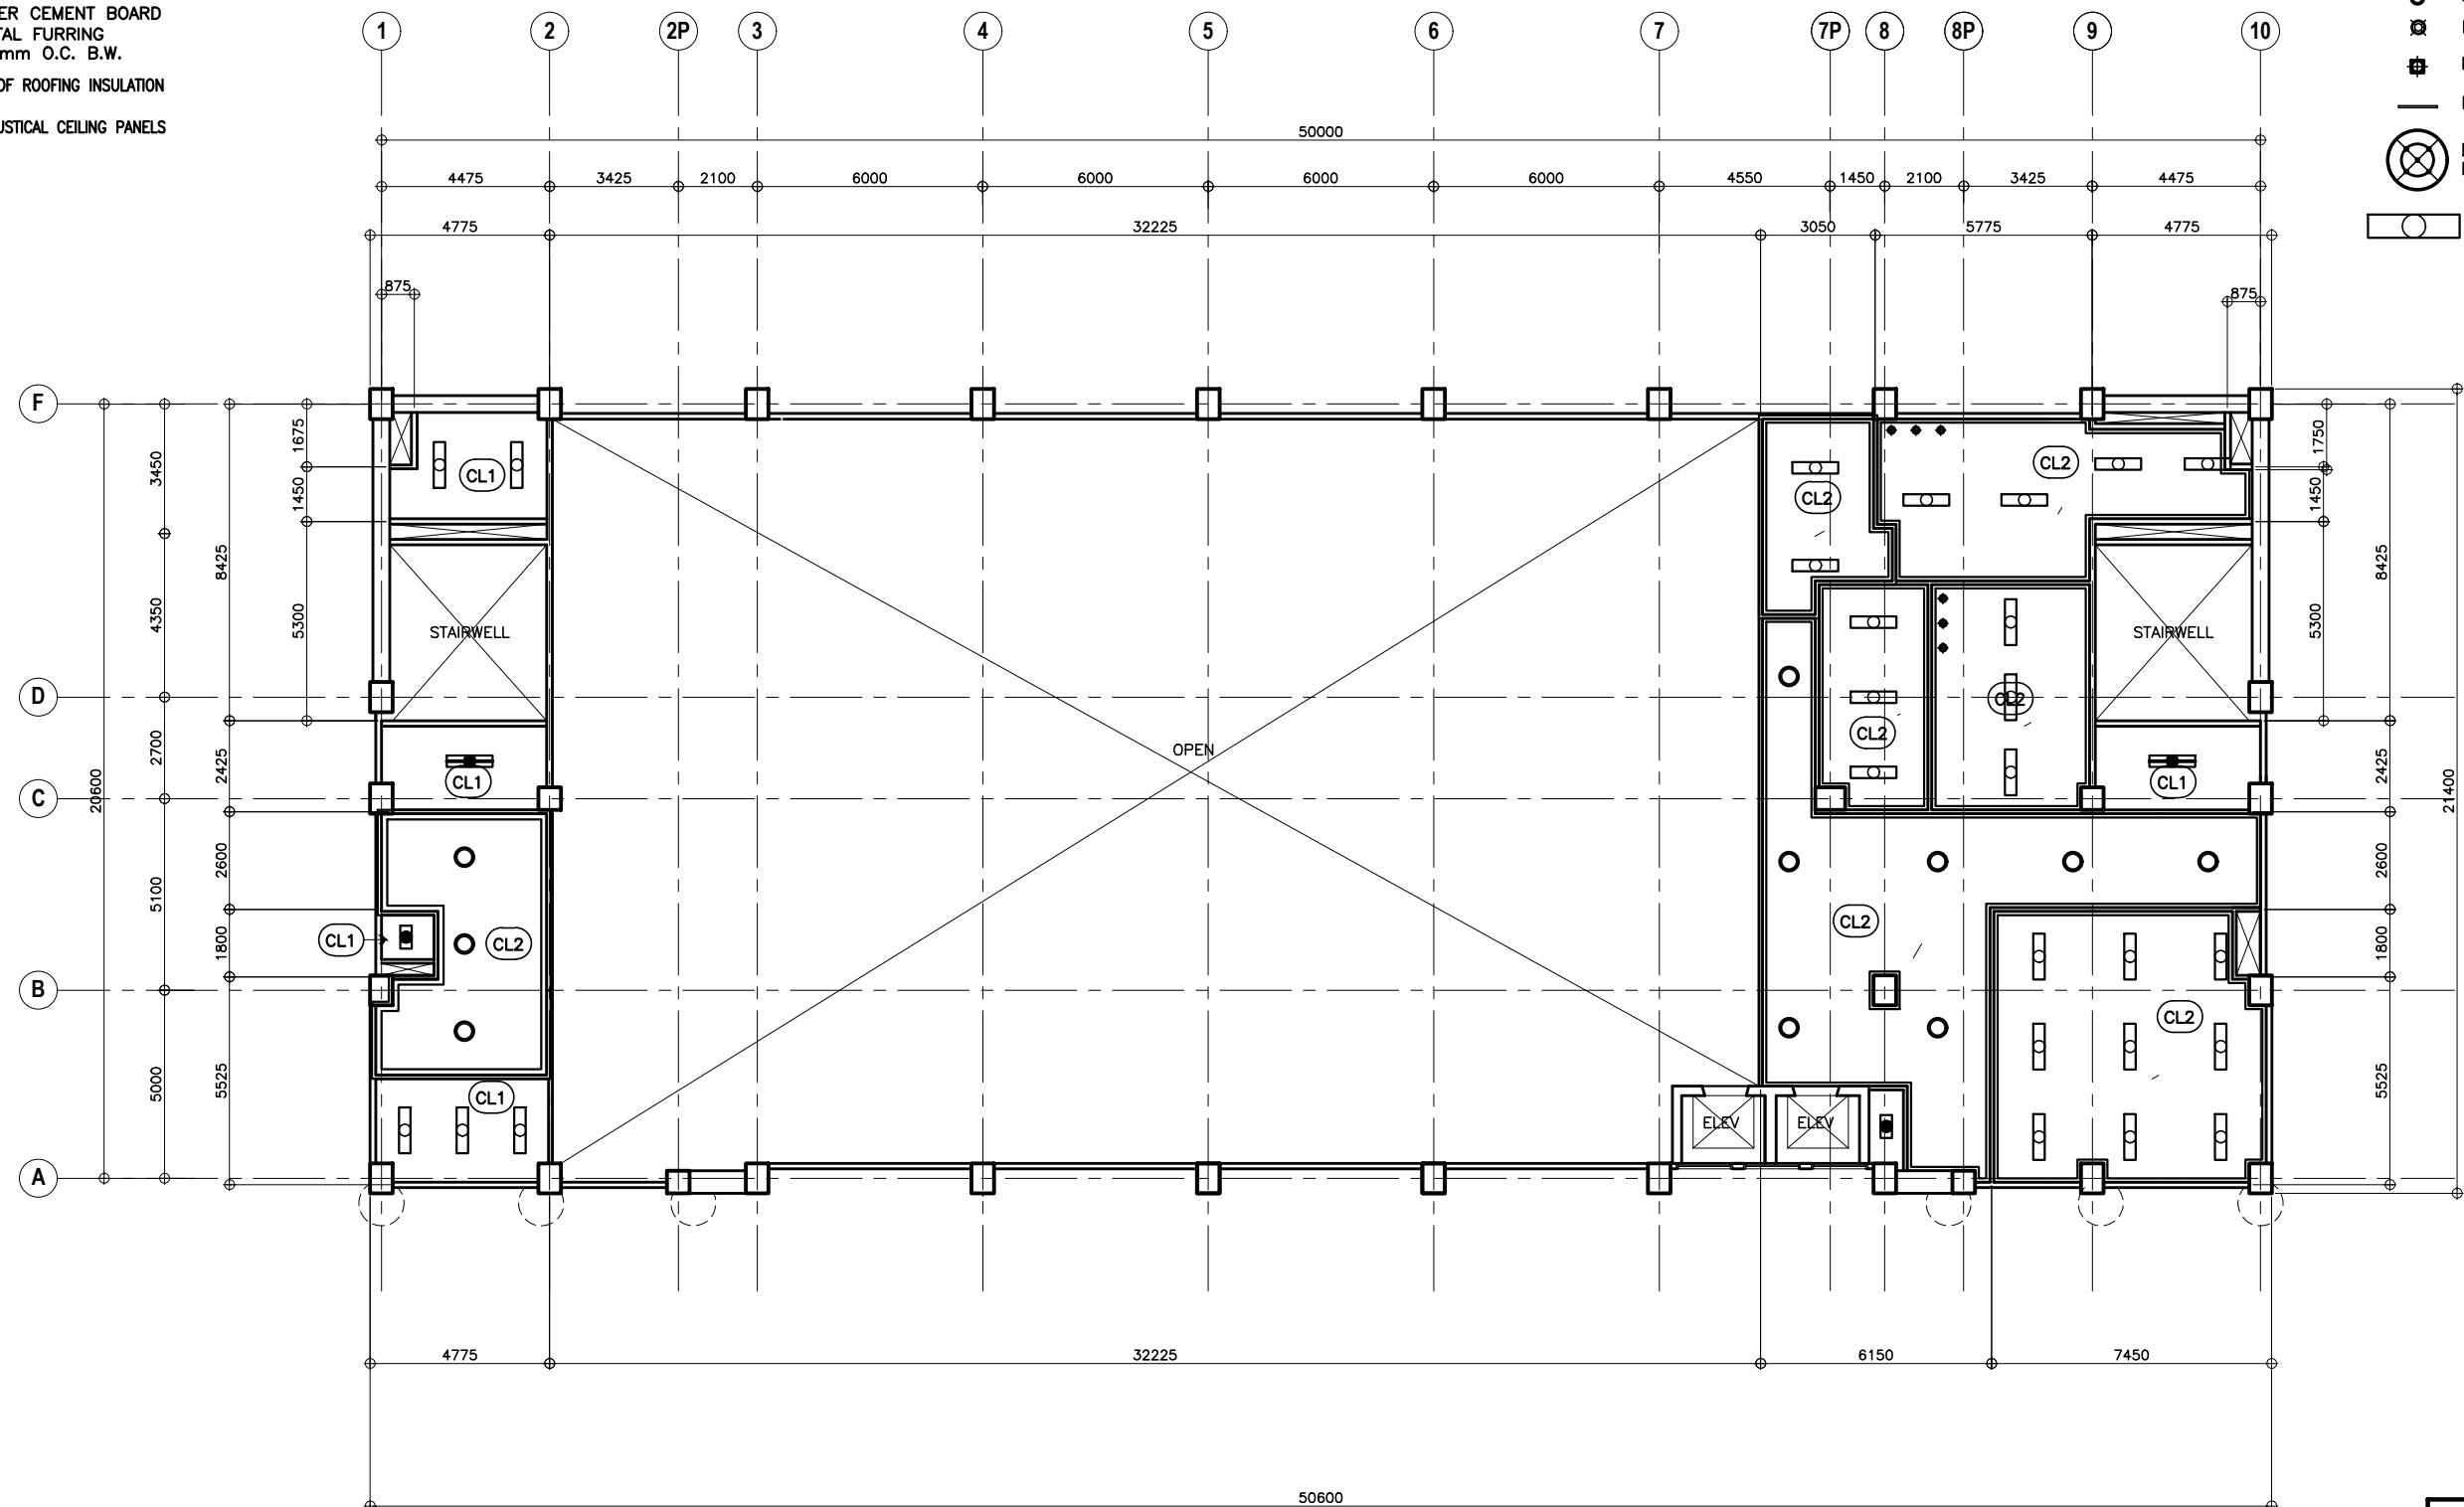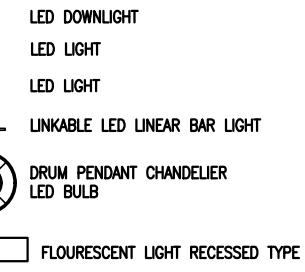

OTE: PURSUANT TO SECTION 4 OF ANNEX "A" OF THE
EVED IMPLEMENTING RULES AND REGULATION OF RA. 9184,
PROVAL BY THE AUTHORIZED DPWH OFFICIALS OF DETAILED
ENGINEERING SURVEYS AND DESIGN UNDERTAKEN BY CONSULTANTS
EITHER DIMINISHES THE RESPONSIBILITY OF THE LATTER
OR THE TECHNICAL INTEGRITY OF THE SURVEYS AND DESIGN
OR TRANSFER ANY PART OF THAT RESPONSIBILITY TO THE
PROVING OFFICIALS.

THE DESIGN CONSULTANT SHALL BE HELD FULLY RESPONSIBLE FOR THE FAILURE OF THE FACILITY/IES/STRUCTURES DUE TO FAULTY DESIGN EXCEPT FOR THE CHANGES MADE WITHOUT THE CONFORMITY OF THE CONSULTANTS.

1 SEVENTH FLOOR REFLECTED CEILING PLAN
A-27 SCALE 1:100M



UNITED TECHNOLOGIES
CONSOLIDATED PARTNERSHIP

PREPARED BY:	SUBMITTED BY:
ARMAN U. CUEVAS ARCHITECTURAL DESIGN POSITION: ARCHITECT PRC No.: 0018676 TIN No.: 907-359-364 PTR No.: 4020896	
CYNTHIA CLEM	
ARCHITECT/TEAM	



**REPUBLIC OF THE PHILIPPINES
DEPARTMENT OF PUBLIC WORKS AND HIGHWAYS
BUREAU OF DESIGN
BUILDINGS DIVISION**

REVIEWED AS TO DESIGN CONCEPT:	RECOMMENDATION APPROVAL
JOSEPHINE P. ISTURIS CHIEF, BUILDINGS DIVISION, BOD	(SEAL) LEA N. D.

DING	APPROVED:
COVER SHEET)	(SEE COVER SHE
FINADO, CESO IV	EMIL K. SADAIN, C
ER-IN-CHARGE	UNDERSECRETARY FOR OPERATIONS & TECHNICAL

	CONCURRED:	PRO
) SO I MO RVICES	(SEE COVER SHEET) ROWENA CANDICE M. RUIZ EXECUTIVE DIRECTOR	PR

**JECT & LOCATION / BARANGAY:
POSED:**

**PROPOSED SEVEN (7) STOREY
GOVERNMENT PROCUREMENT POLICY
BOARD (GPPB)
UP DILIMAN COMPOUND, DILIMAN,
QUEZON CITY**

SHEET CONTENTS:

DOOR REFLECTED
WALKING PLAN


SET NO.	SHEET NO.
BOD A-27	29 216

CEILING FINISHES:

- (CL1) EXPOSED UNDERSIDE OF CONCRETE SLAB (PAINTED FINISH)
- (CL2) 4.5mm THICK FIBER CEMENT BOARD (PAINTED) ON METAL FURRING CHANNELS @ 400mm O.C. B.W.
- (CL3) EXPOSED UNDERSIDE OF ROOFING INSULATION
- (CL4) FABRIC WRAPPED ACOUSTICAL CEILING PANELS

LEGEND:

- LED DOWNLIGHT
- LED LIGHT
- LED LIGHT
- LINKABLE LED LINEAR BAR LIGHT
- DRUM PENDANT CHANDELIER LED BULB
- FLOURESCENT LIGHT RECESSED TYPE

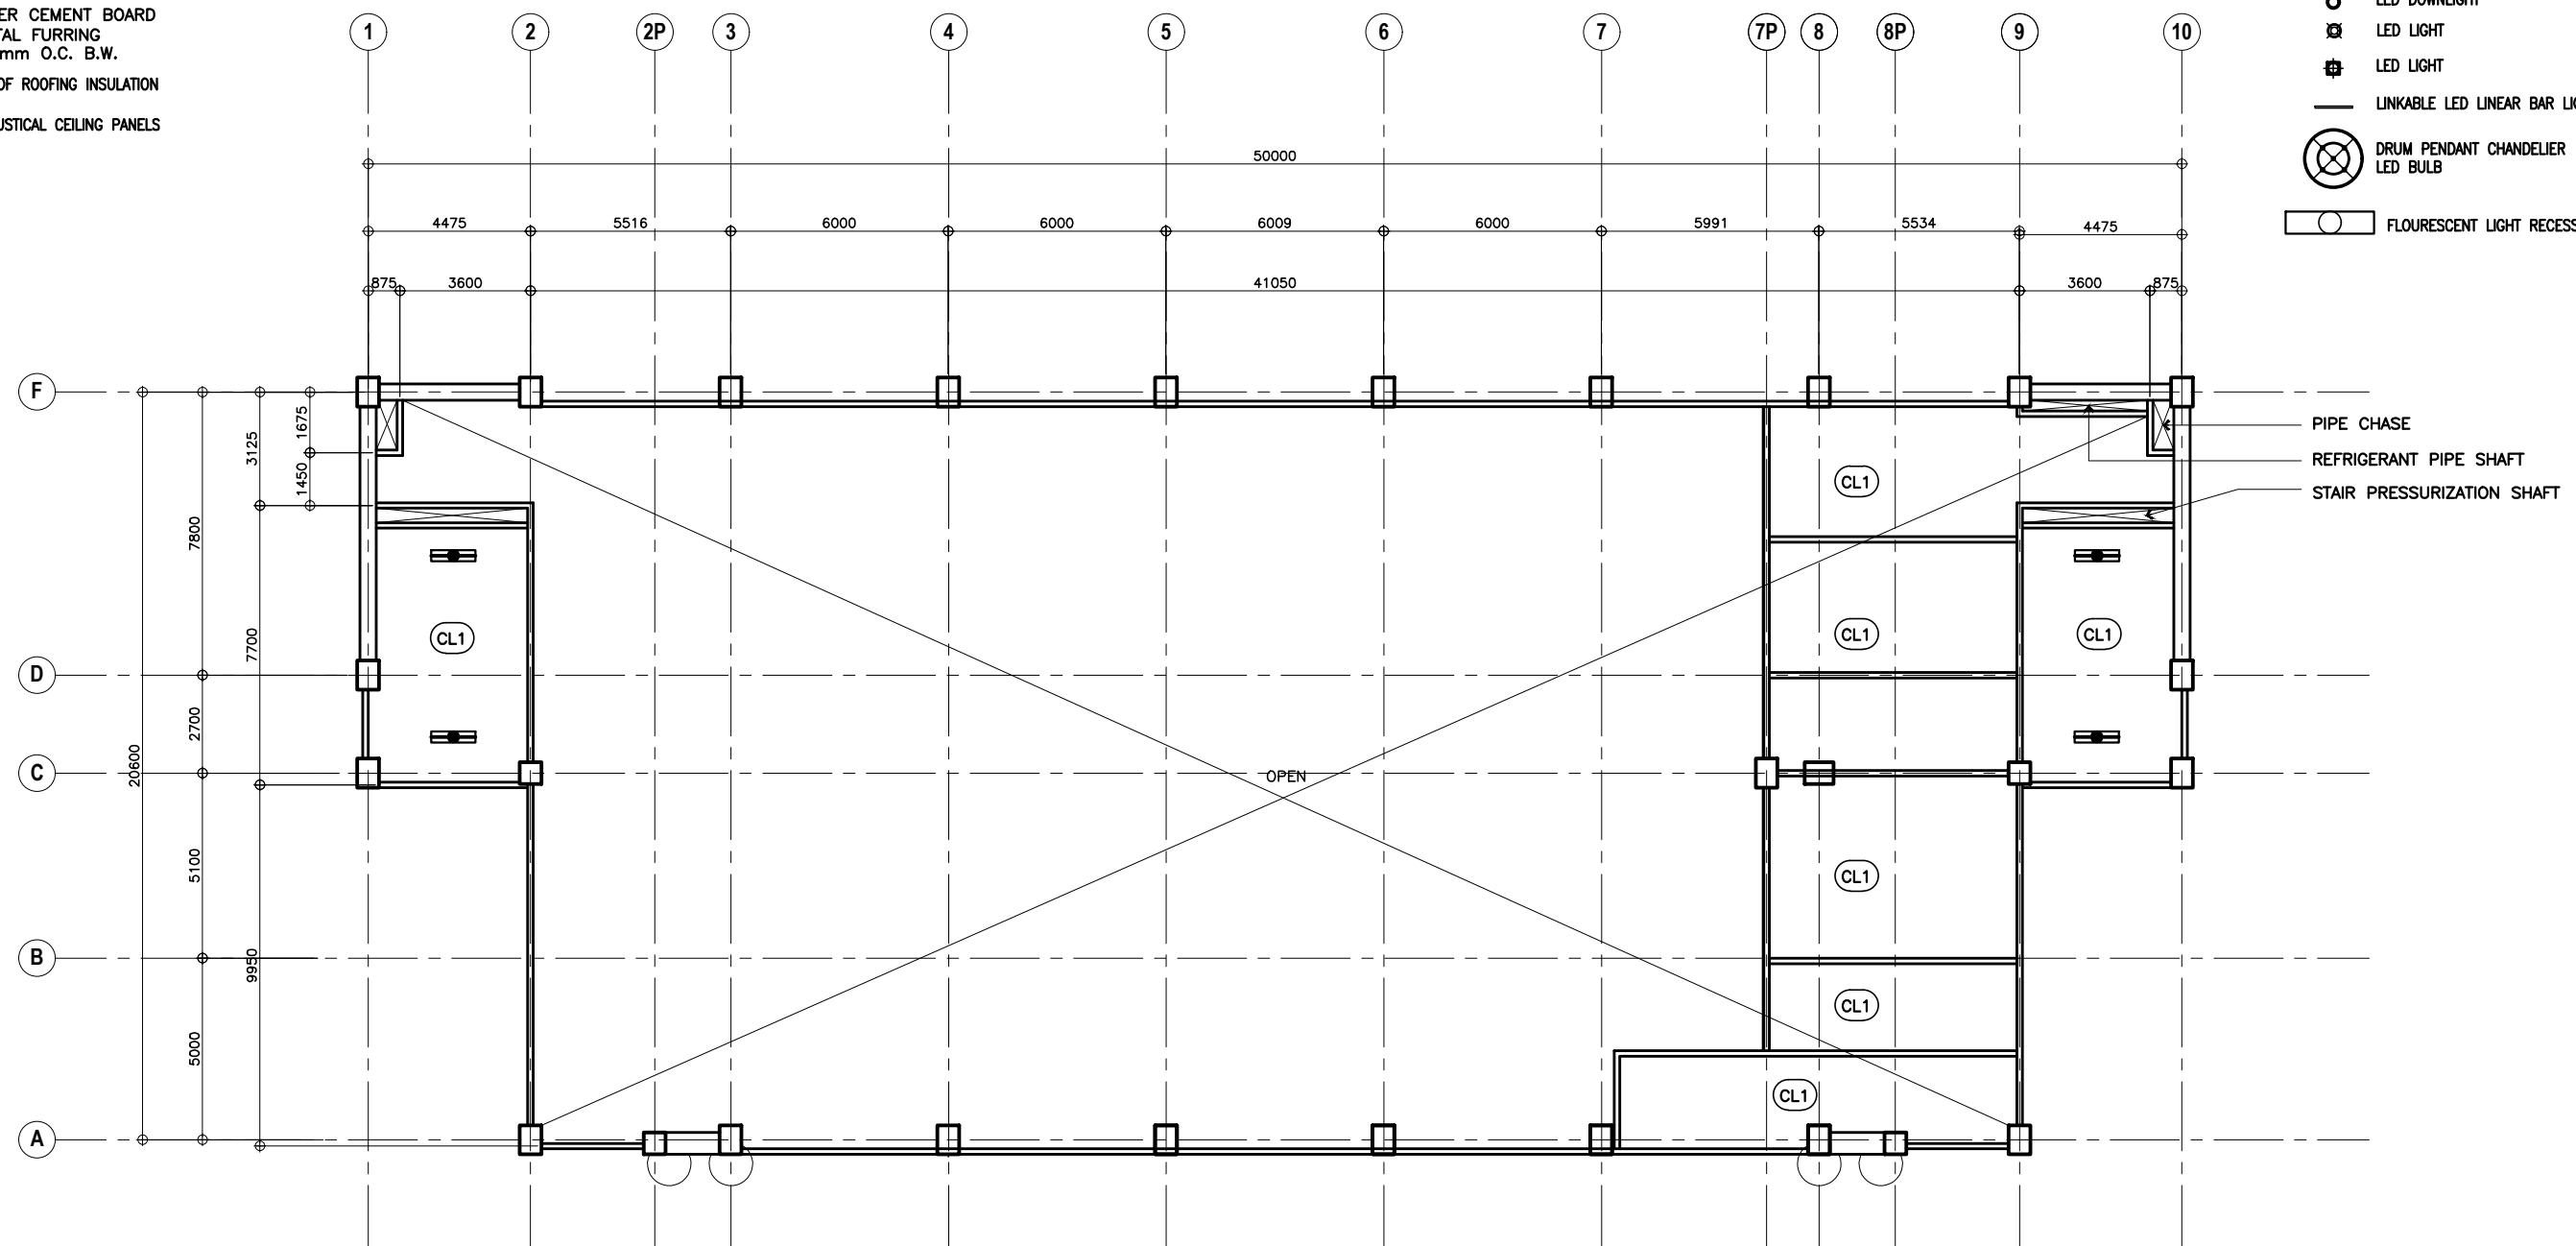

NOTE:
PURSUANT TO SECTION 4 OF ANNEX "A" OF THE REVISED IMPLEMENTING RULES AND REGULATION OF RA. 9184, APPROVAL BY THE AUTHORIZED DPWH OFFICIALS OF DETAILED ENGINEERING SURVEYS AND DESIGN UNDERTAKEN BY CONSULTANTS NEITHER DIMINISHES THE RESPONSIBILITY OF THE LATTER FOR THE TECHNICAL INTEGRITY OF THE SURVEYS AND DESIGN NOR TRANSFER ANY PART OF THAT RESPONSIBILITY TO THE APPROVING OFFICIALS.

THE DESIGN CONSULTANT SHALL BE HELD FULLY RESPONSIBLE FOR THE FAILURE OF THE FACILITY/IES/STRUCTURES DUE TO FAULTY DESIGN EXCEPT FOR THE CHANGES MADE WITHOUT THE CONFORMITY OF THE CONSULTANTS.


1
A-28 REFLECTED CEILING PLAN OVER STAIRWELL
SCALE 1:100M

CEILING FINISHES:

- (CL1) EXPOSED UNDERSIDE OF CONCRETE SLAB (PAINTED FINISH)
- (CL2) 4.5mm THICK FIBER CEMENT BOARD (PAINTED) ON METAL FURRING CHANNELS @ 400mm O.C. B.W.
- (CL3) EXPOSED UNDERSIDE OF ROOFING INSULATION
- (CL4) FABRIC WRAPPED ACOUSTICAL CEILING PANELS

LEGEND:

- LED DOWNLIGHT
- ⊗ LED LIGHT
- ⊕ LED LIGHT
- LINKABLE LED LINEAR BAR LIGHT
- DRUM PENDANT CHANDELIER LED BULB
- FLOURESCENT LIGHT RECESSED TYPE

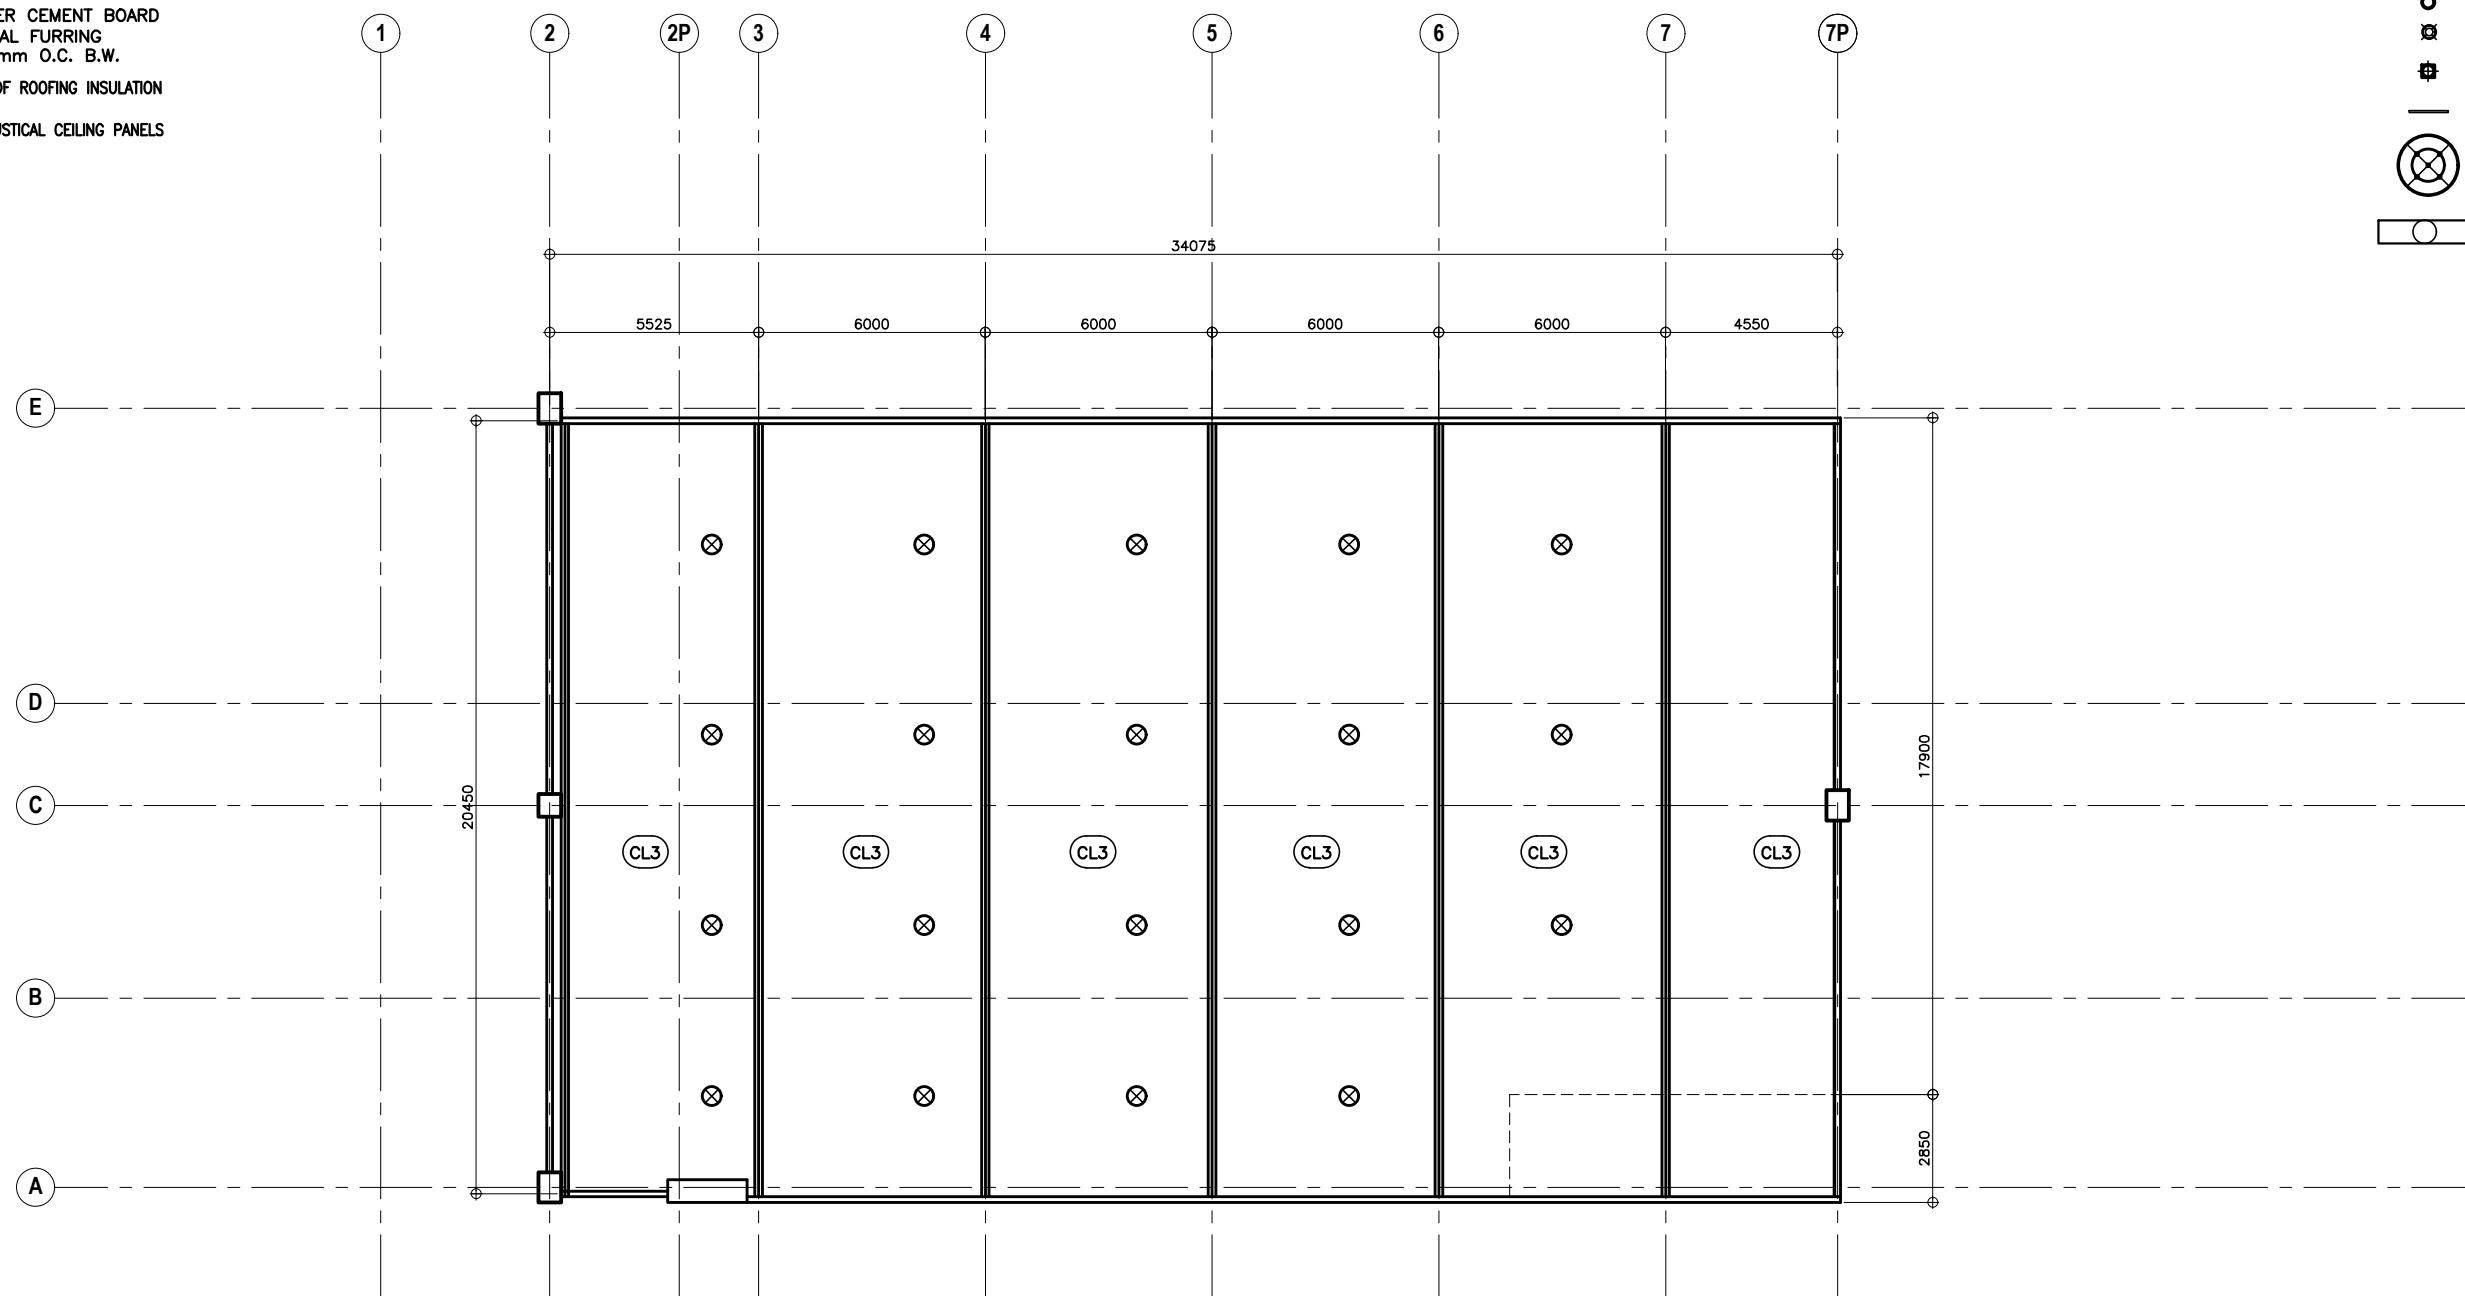


NOTE:
PURSUANT TO SECTION 4 OF ANNEX "A" OF THE REVISED IMPLEMENTING RULES AND REGULATION OF RA. 9184, APPROVAL BY THE AUTHORIZED DPWH OFFICIALS OF DETAILED ENGINEERING SURVEYS AND DESIGN UNDERTAKEN BY CONSULTANTS NEITHER DIMINISHES THE RESPONSIBILITY OF THE LATTER FOR THE TECHNICAL INTEGRITY OF THE SURVEYS AND DESIGN NOR TRANSFER ANY PART OF THAT RESPONSIBILITY TO THE APPROVING OFFICIALS.






THE DESIGN CONSULTANT SHALL BE HELD FULLY RESPONSIBLE FOR THE FAILURE OF THE FACILITY/IES/STRUCTURES DUE TO FAULTY DESIGN EXCEPT FOR THE CHANGES MADE WITHOUT THE CONFORMITY OF THE CONSULTANTS.

1
A-29 SCALE 1:100M

REFLECTED CEILING PLAN OVER BASKETBALL COURT









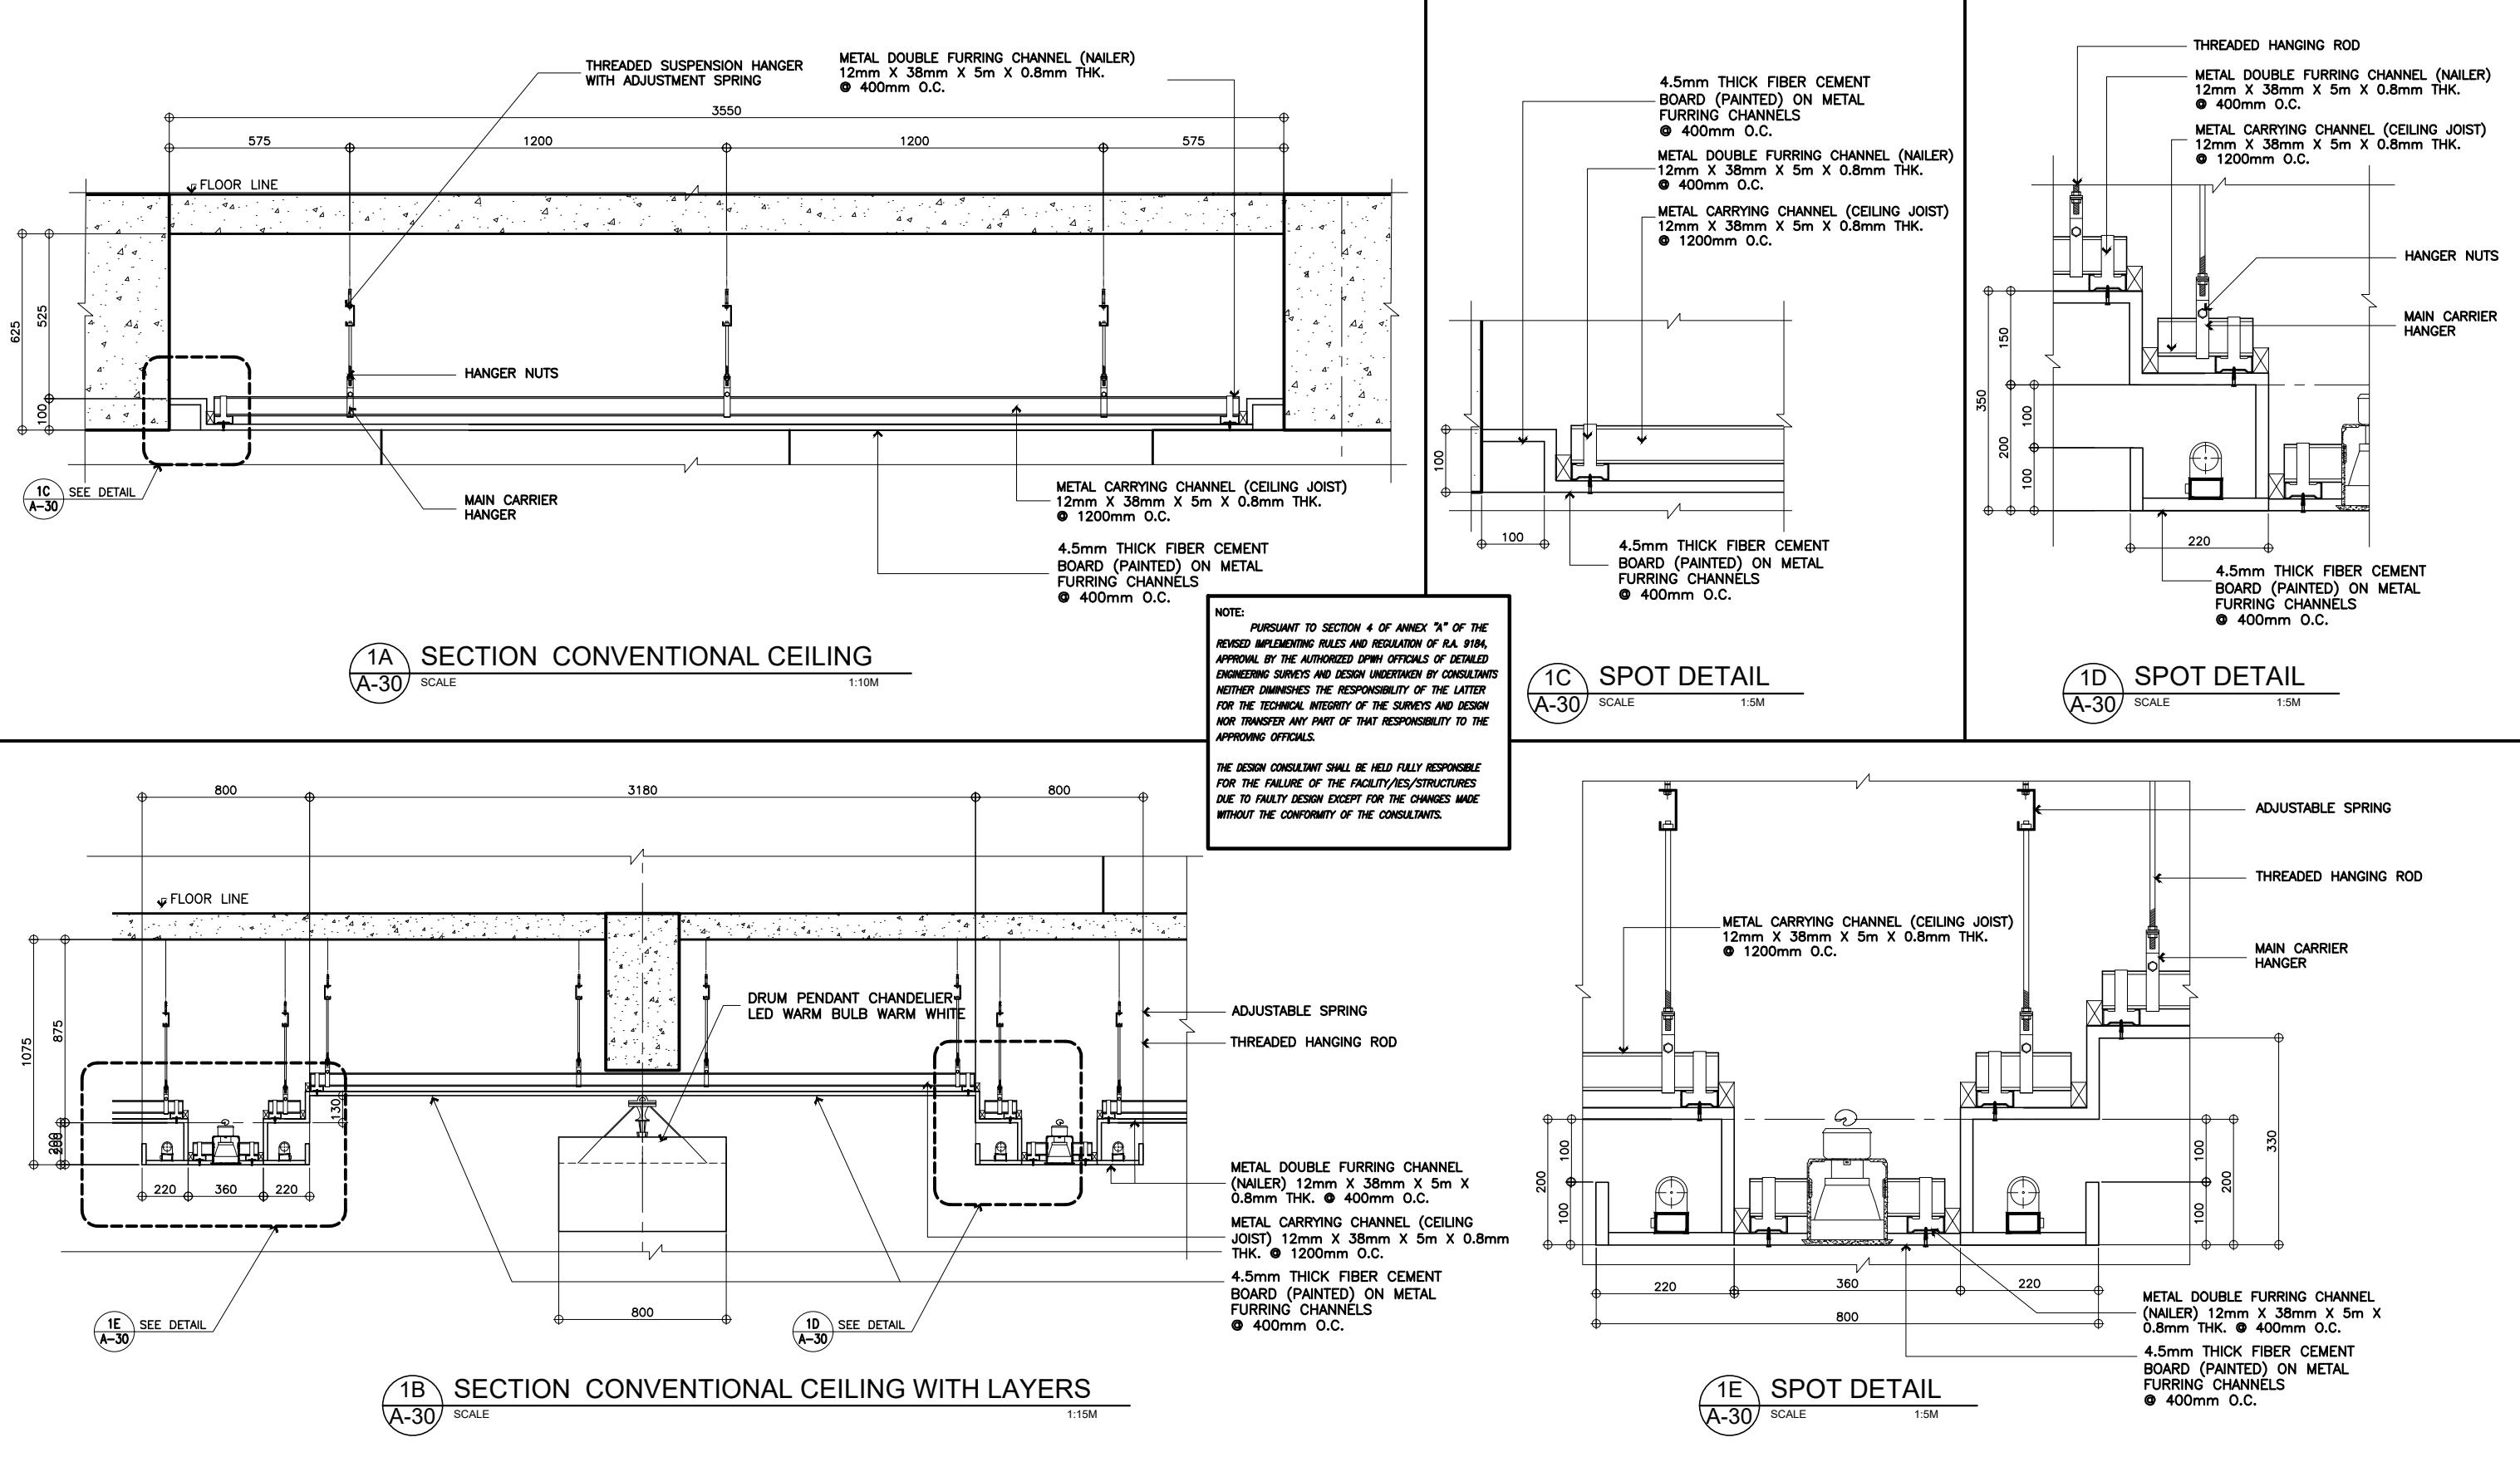


 UNITED TECHNOLOGIES CONSOLIDATED PARTNERSHIP	PREPARED BY:	SUBMITTED BY:	 REPUBLIC OF THE PHILIPPINES DEPARTMENT OF PUBLIC WORKS AND HIGHWAYS BUREAU OF DESIGN BUILDINGS DIVISION BONIFACIO DRIVE PORT AREA, MANILA	REVIEWED AS TO DESIGN CONCEPT:	RECOMMENDING APPROVAL:	APPROVED:	CONCURRED:	PROJECT & LOCATION / BARANGAY:	SHEET CONTENTS:	SET NO.	SHEET NO.
	ARMAN U. CUEVAS	CYNTHIA CLEMEN A. YU		(SEE COVER SHEET)	(SEE COVER SHEET)	(SEE COVER SHEET)	(SEE COVER SHEET)	PROPOSED:	TYPICAL CEILING DETAIL	 BOD A-30	 32 216
	ARCHITECTURAL DESIGN POSITION: ARCHITECT PRC No.: 0018676 TIN No.: 907-359-364 PTB No.: 4920896	ARCHITECT/TEAM LEADER	JOSEPHINE P. ISTURIS	LEA N. DELFINADO, CESO IV	EMIL K. SADAIN, CESO I	ROWENA CANDICE M. RUIZ	PROPOSED SEVEN (7) STOREY GOVERNMENT PROCUREMENT POLICY BOARD (GPPB) UP DILIMAN COMPOUND, DILIMAN, QUEZON CITY				
			CHIEF, BUILDINGS DIVISION, BOD	OFFICER-IN-CHARGE	UNDERSECRETARY FOR UPMO OPERATIONS & TECHNICAL SERVICES	EXECUTIVE DIRECTOR					

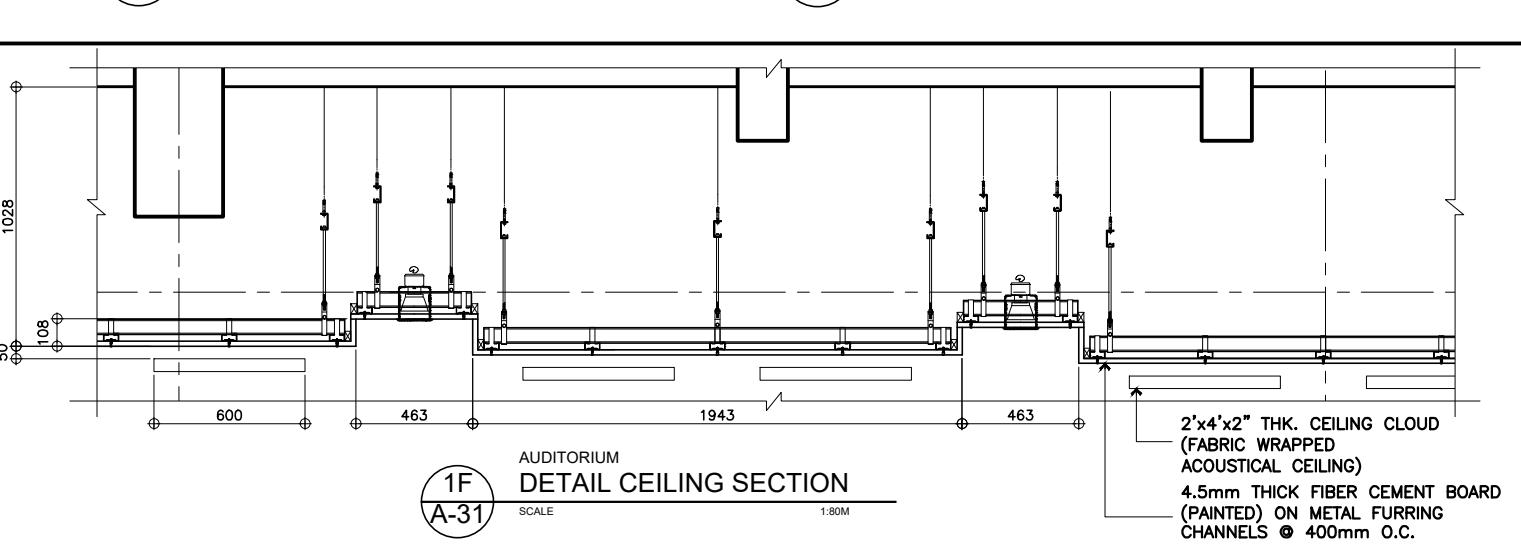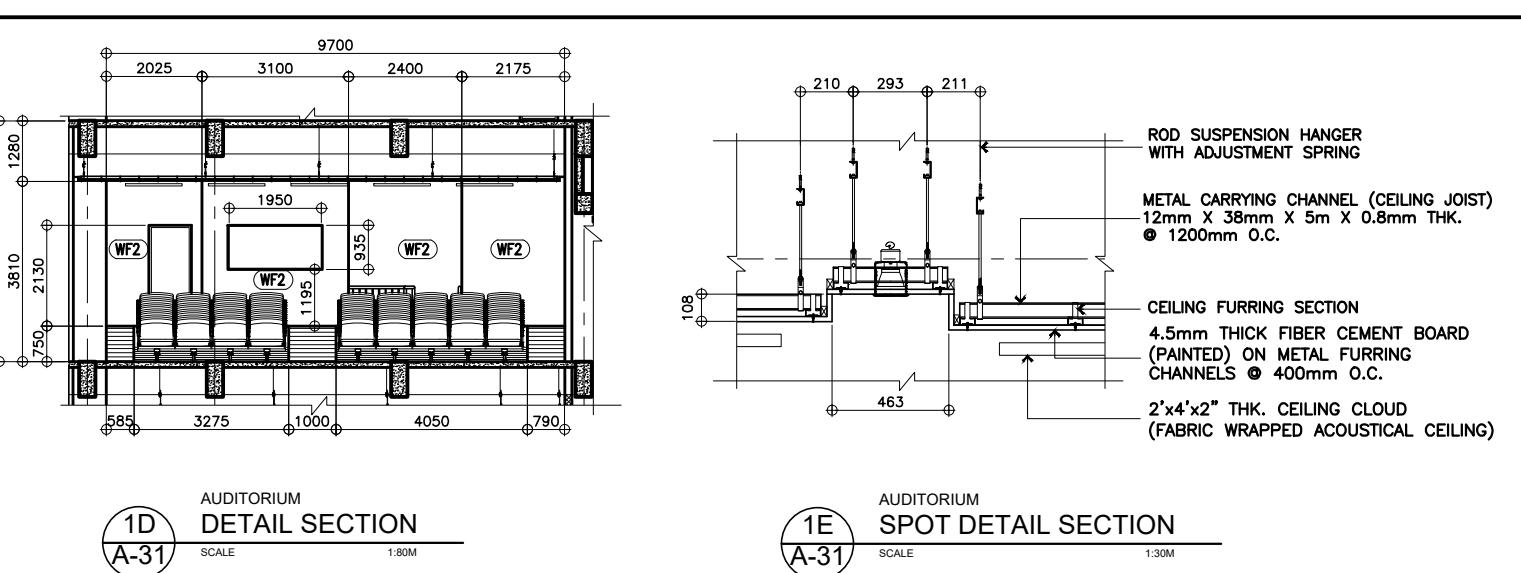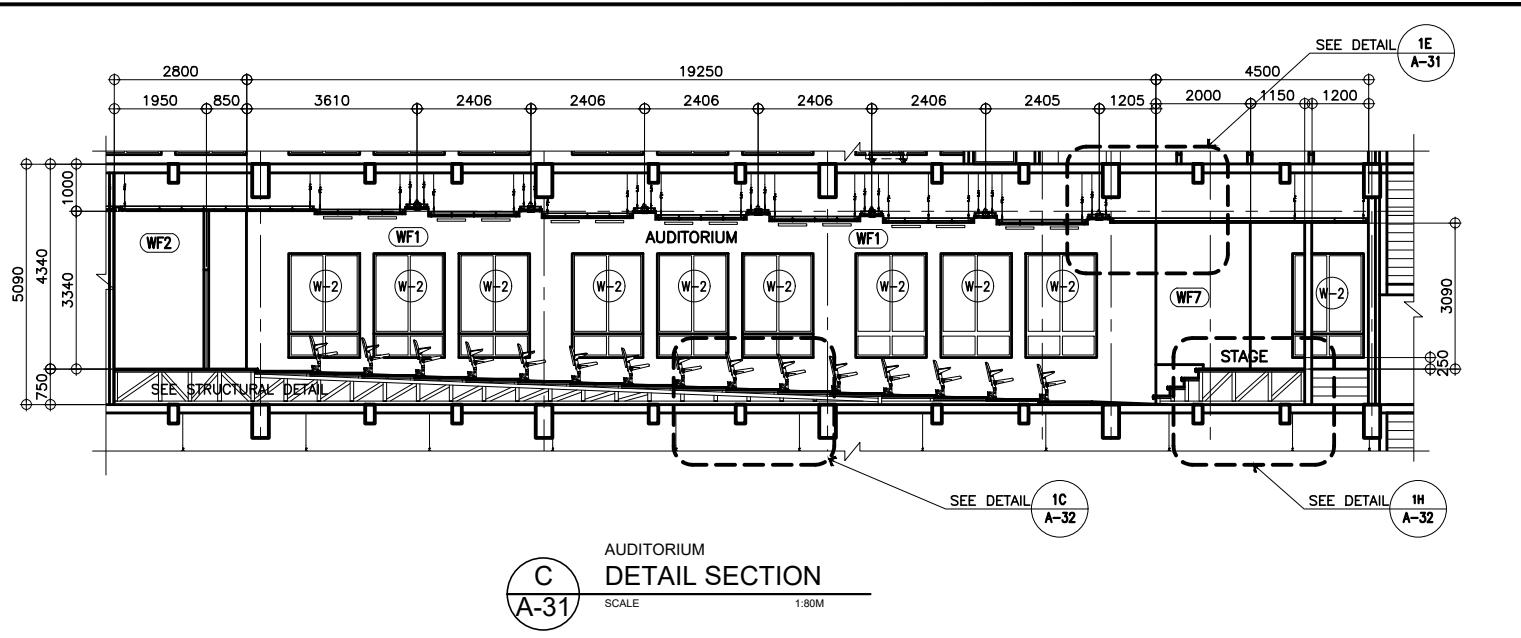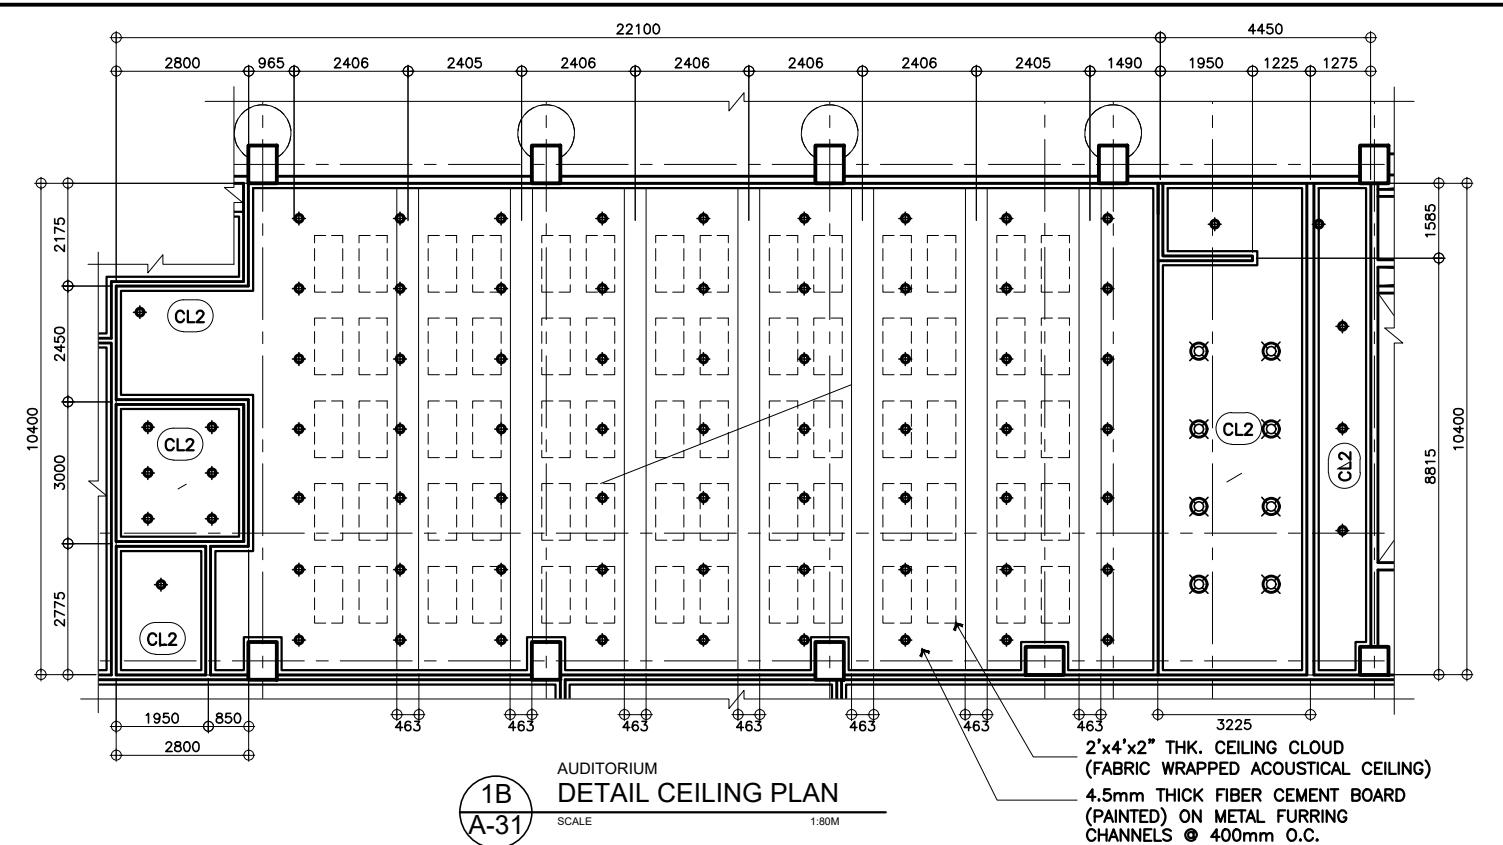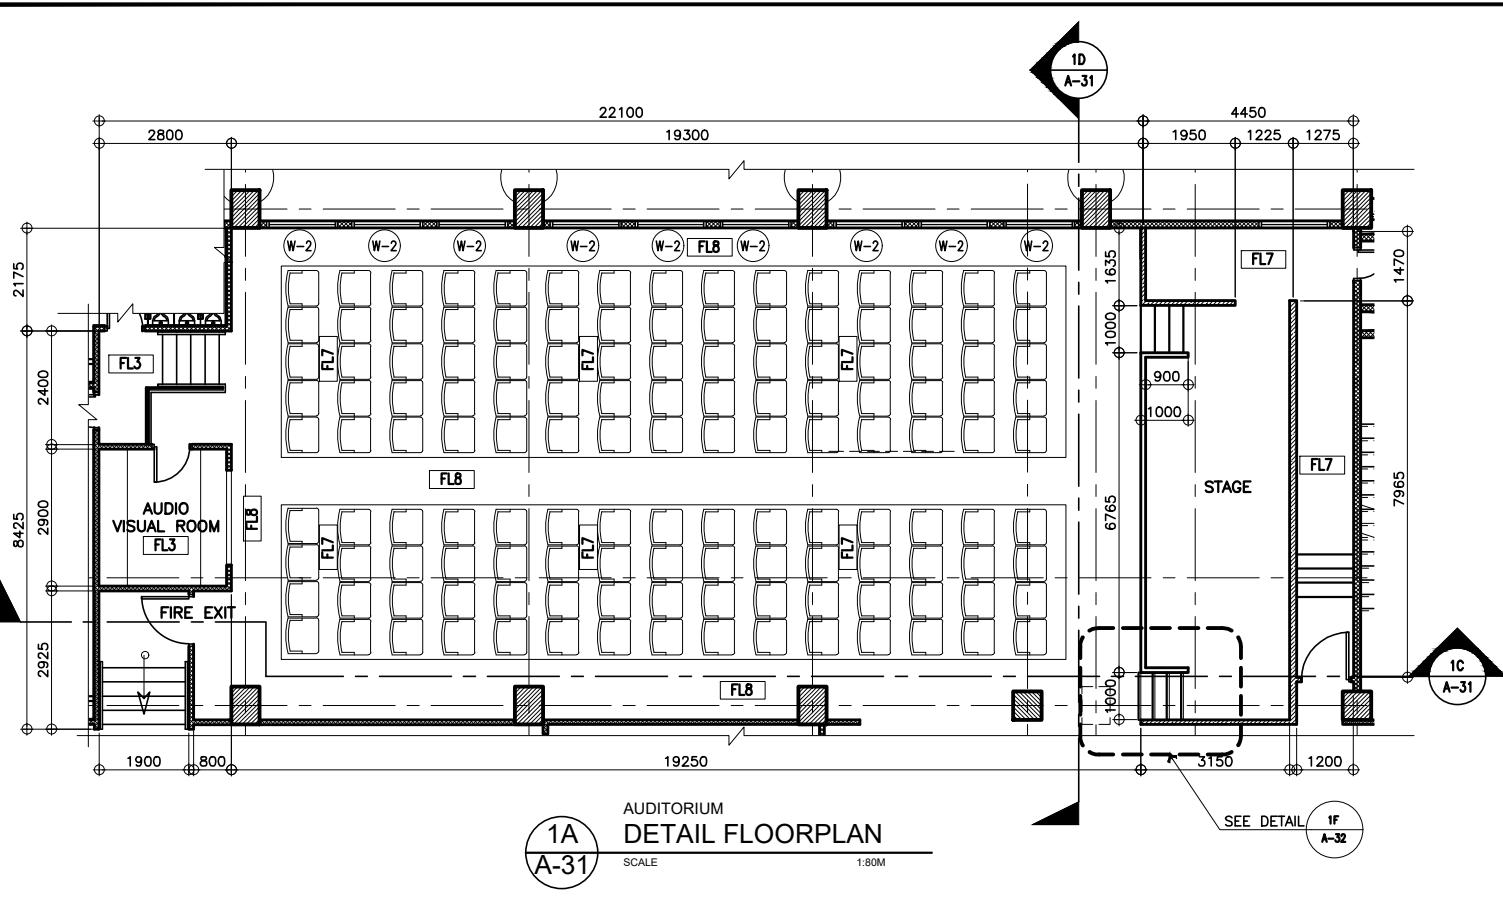











1
A-31
DETAILS OF AUDITORIUM
SCALE AS SHOWN

UNITED TECHNOLOGIES CONSOLIDATED PARTNERSHIP	PREPARED BY: ARMAN U. CUEVAS	SUBMITTED BY: CYNTHIA CLEMEN A. YU	REVIEWED AS TO DESIGN CONCEPT: JOSEPHINE P. ISTURIS	RECOMMENDING APPROVAL: (SEE COVER SHEET) LEA N. DELFINADO, CESO IV	APPROVED: (SEE COVER SHEET)	CONCURRED: (SEE COVER SHEET)	PROJECT & LOCATION / BARANGAY: PROPOSED SEVEN (7) STOREY GOVERNMENT PROCUREMENT POLICY BOARD (GPPB) UP DILIMAN COMPOUND, DILIMAN, QUEZON CITY	SET NO. BOD A-31	Sheet No. 33
	ARCHITECTURAL DESIGN POSITION ARCHITECT PRC No.: 0018676 TIN No.: 907-359-364 PTR No.: 4020896	ARCHITECT/TEAM LEADER	BUREAU OF DESIGN BUILDINGS DIVISION BONIFACIO DRIVE PORT AREA, MANILA	CHIEF, BUILDINGS DIVISION, BOD	OFFICER-IN-CHARGE	UNDERSECRETARY FOR UPMO OPERATIONS & TECHNICAL SERVICES	EXECUTIVE DIRECTOR	DETAILS OF AUDITORIUM	216

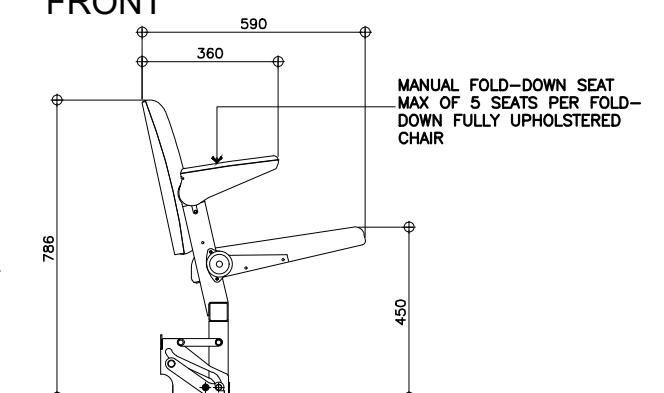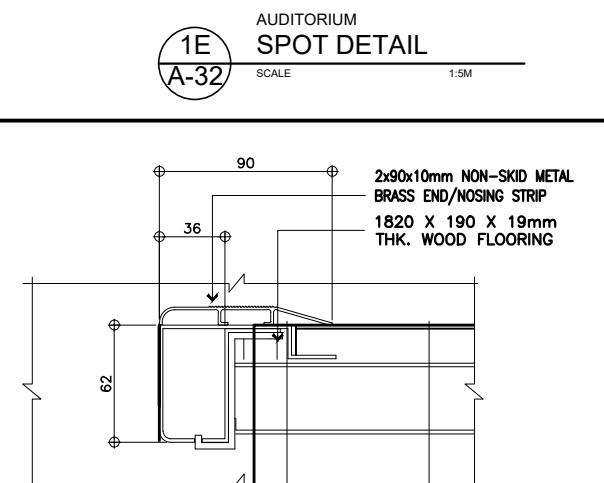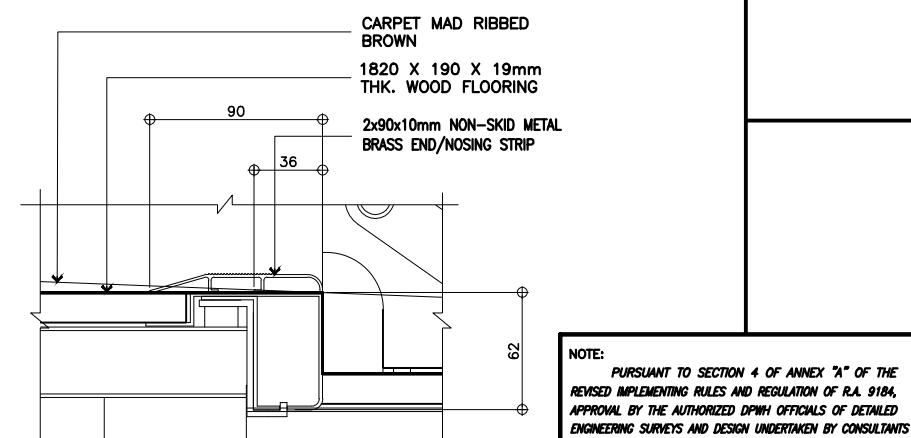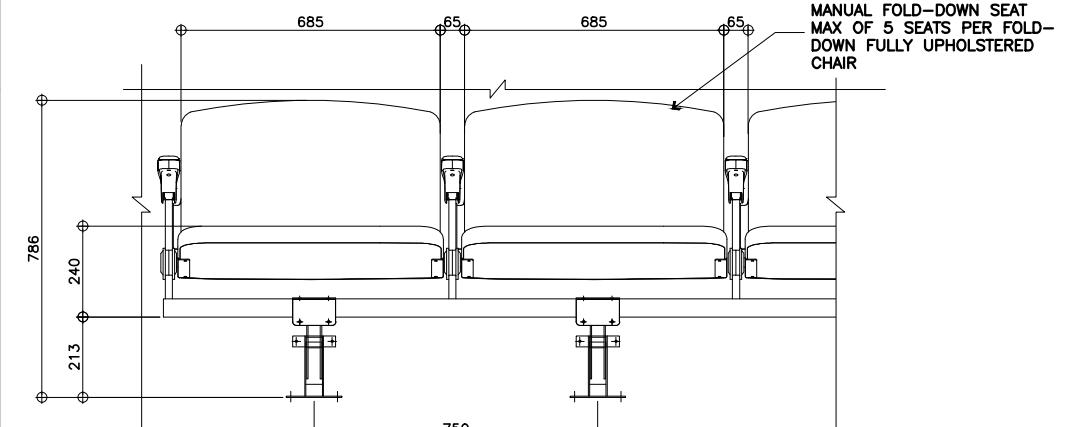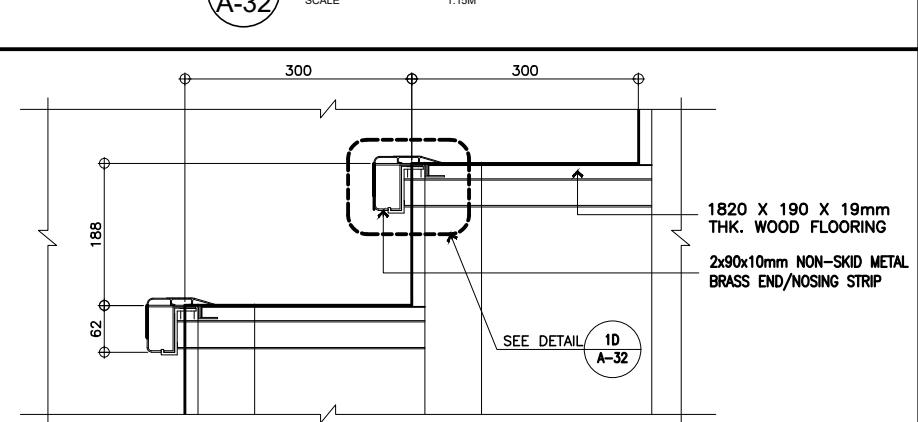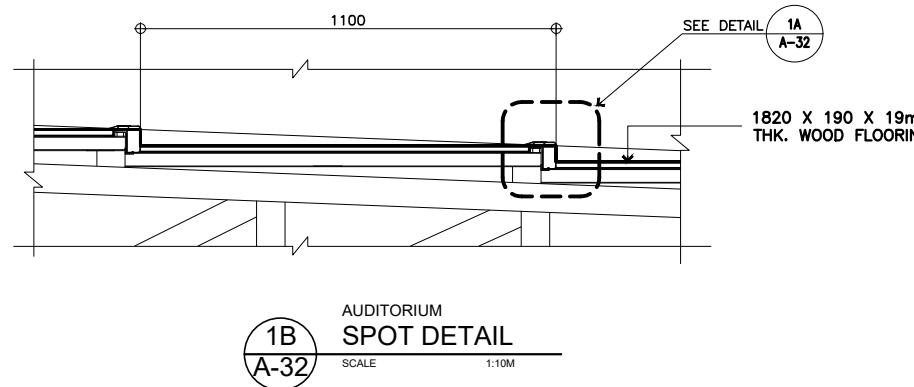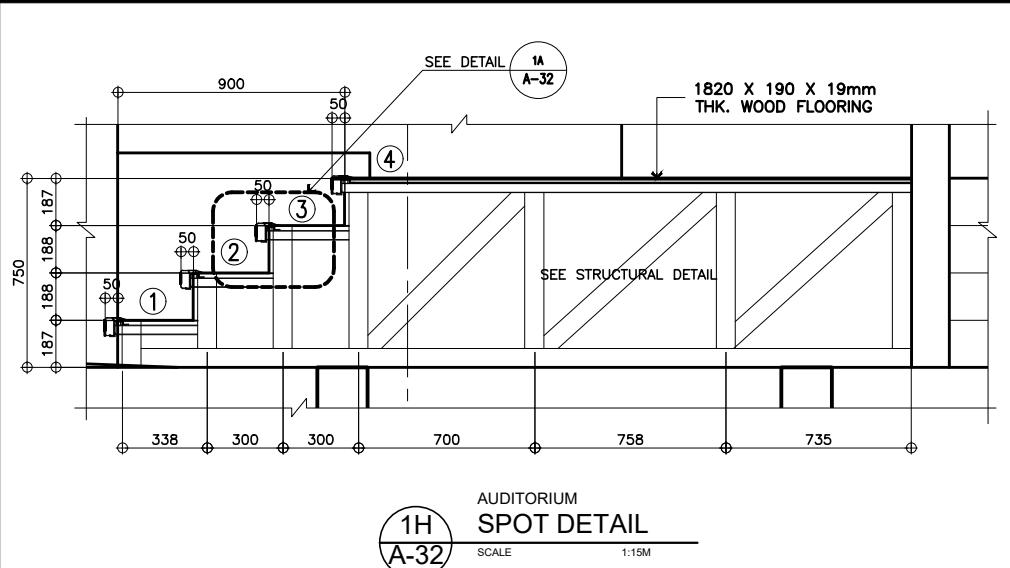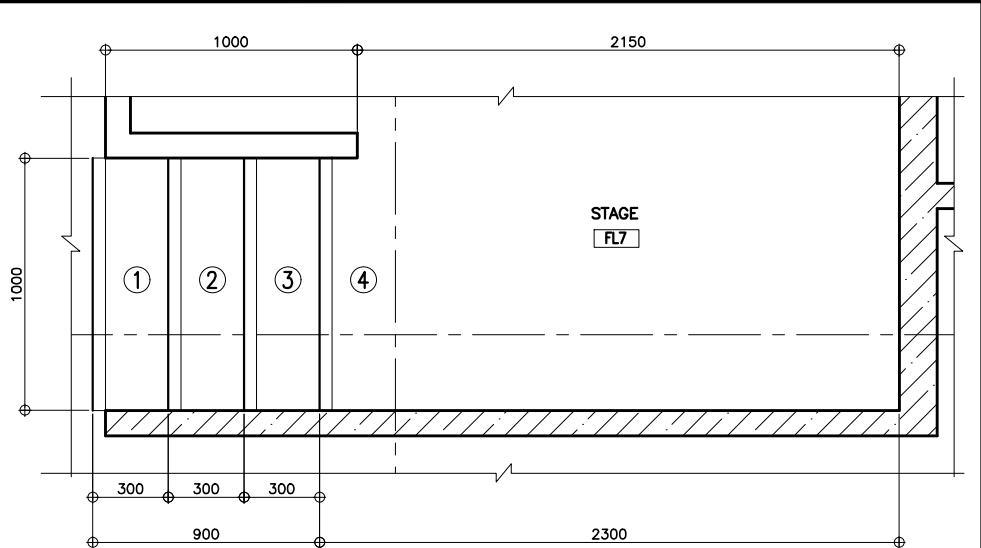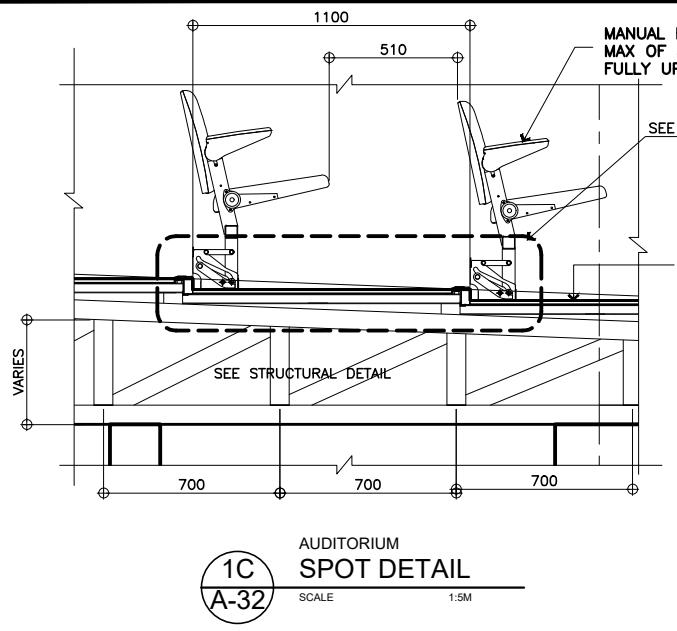







1 SPOT DETAILS OF AUDITORIUM SEATING AND STAIR

 UNITED TECHNOLOGIES CONSOLIDATED PARTNERSHIP	PREPARED BY:	SUBMITTED BY:		REPUBLIC OF THE PHILIPPINES DEPARTMENT OF PUBLIC WORKS AND HIGHWAYS BUREAU OF DESIGN BUILDINGS DIVISION BONIFACIO DRIVE PORT AREA, MANILA	REVIEWED AS TO DESIGN CONCEPT:	RECOMMENDING APPROVAL:	APPROVED:	CONCURRED:	PROJECT & LOCATION / BARANGAY:	SHEET CONTENTS:	SET NO.	SHEET NO.
	ARMAN U. CUEVAS	CYNTHIA CLEMEN A. YU			JOSEPHINE P. ISTURIS	(SEE COVER SHEET) LEA N. DELFINADO, CESO IV	(SEE COVER SHEET) EMIL K. SADAIN, CESO I	(SEE COVER SHEET) ROWENA CANDICE M. RUIZ	PROPOSED: PROPOSED SEVEN (7) STOREY GOVERNMENT PROCUREMENT POLICY BOARD (GPPB) UP DILIMAN COMPOUND, DILIMAN, QUEZON CITY	SPOT DETAIL OF AUDITORIUM SEATING AND STAIR		34 216

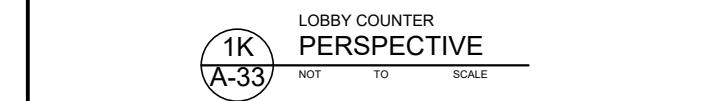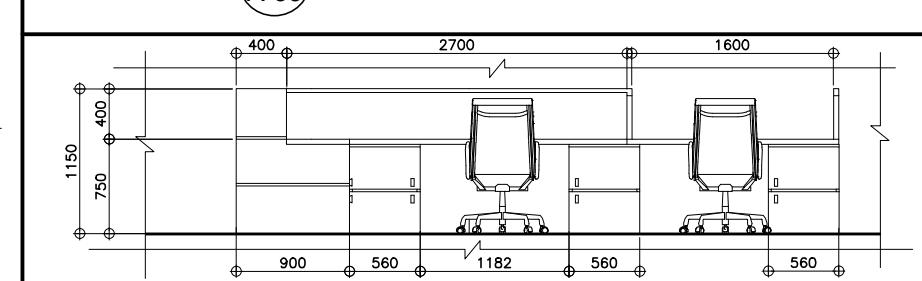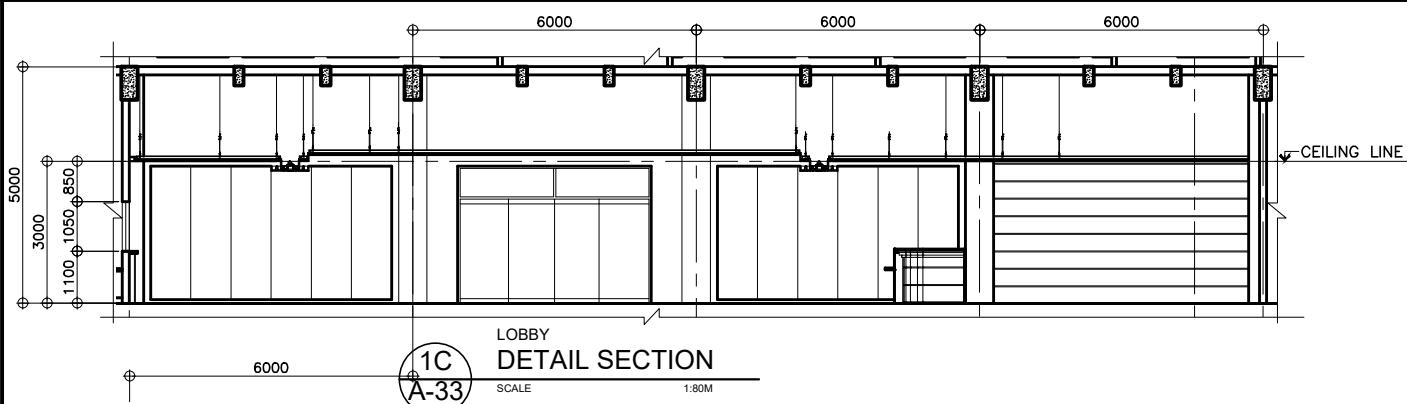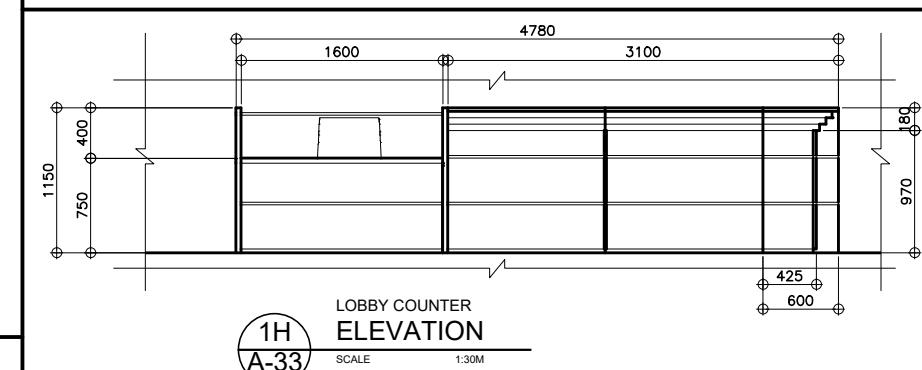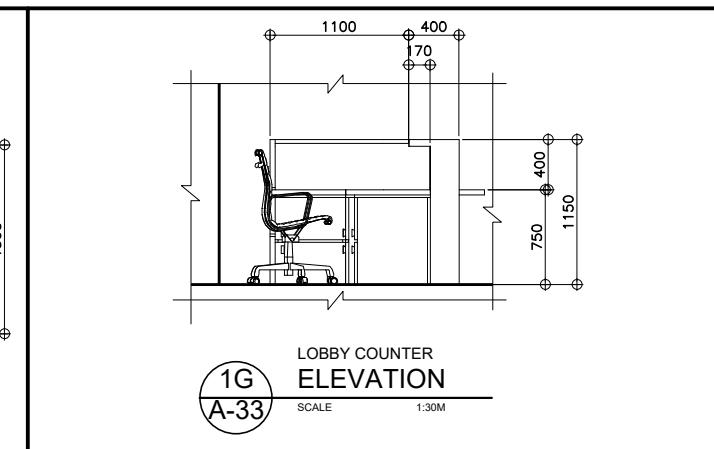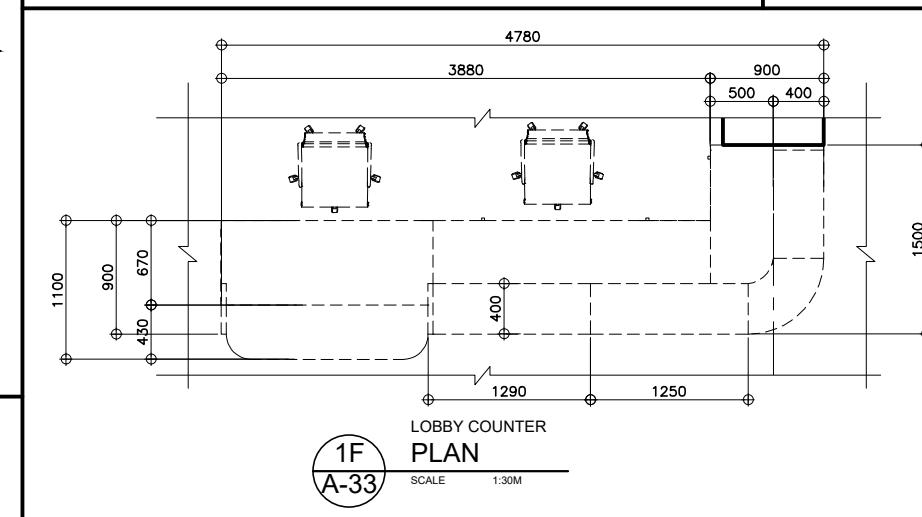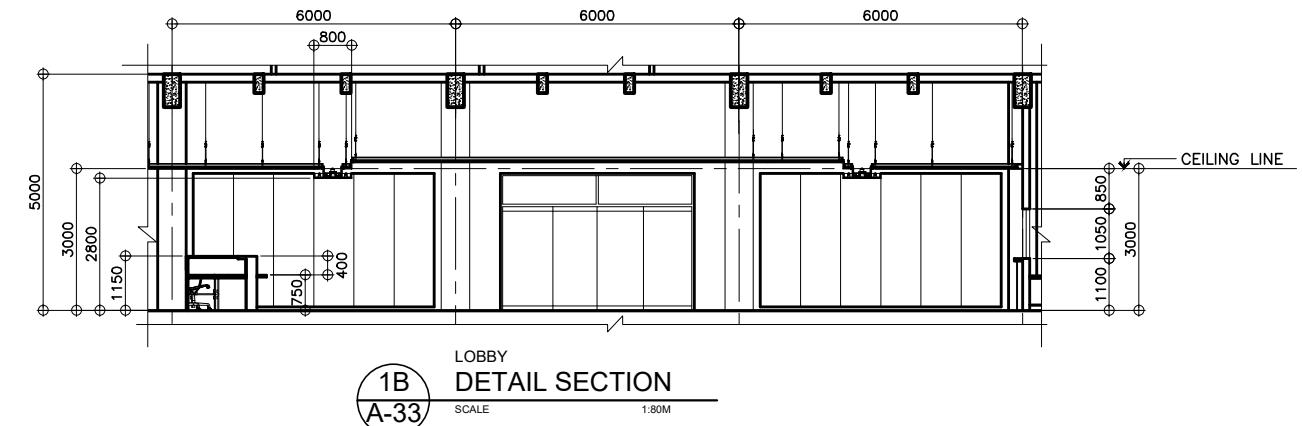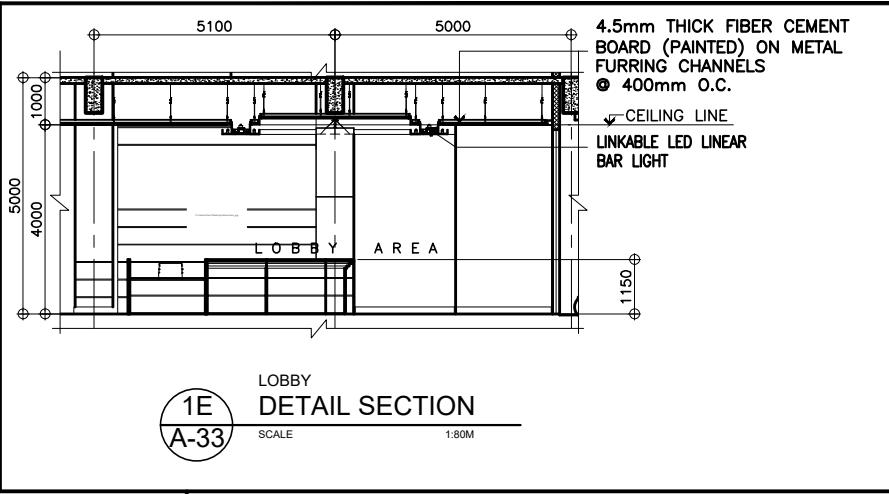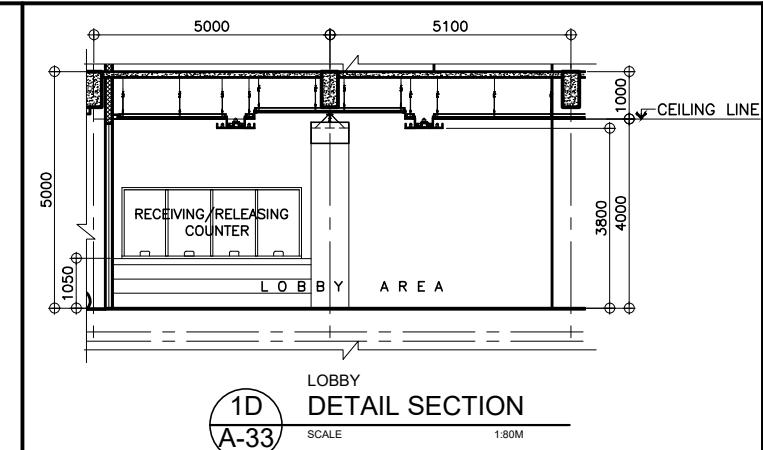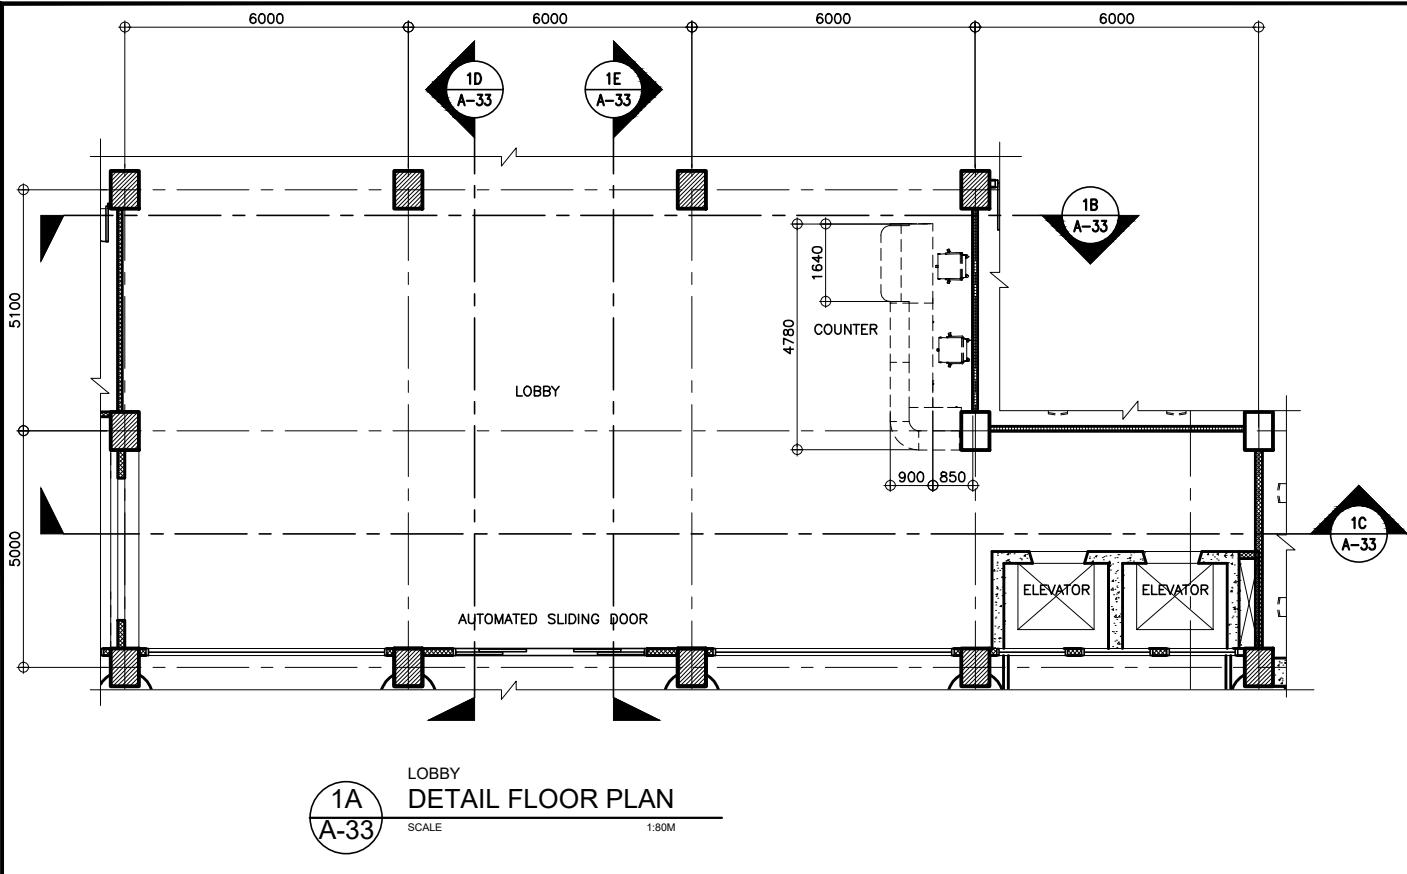


GROUND FLOOR
1
DETAILS OF LOBBY AND COUNTER
A-33

SCALE AS SHOWN

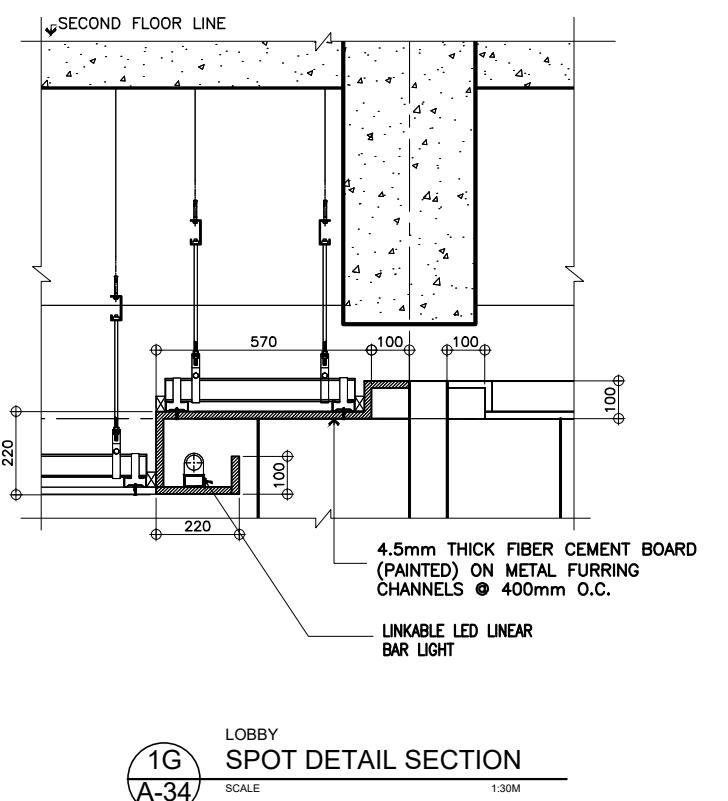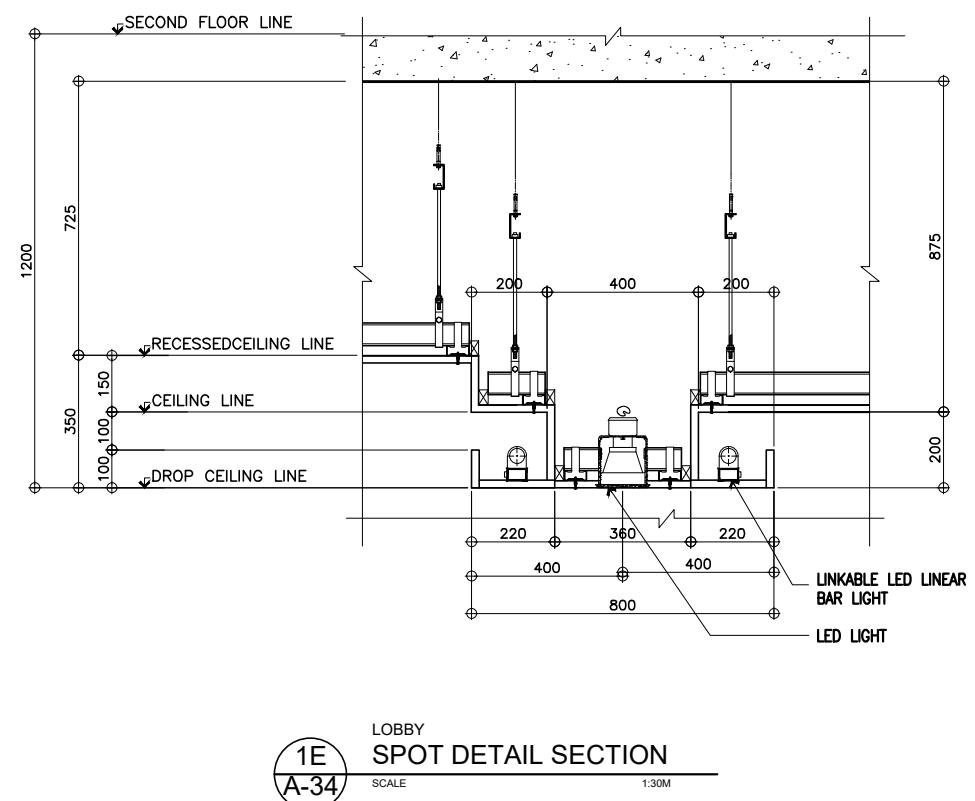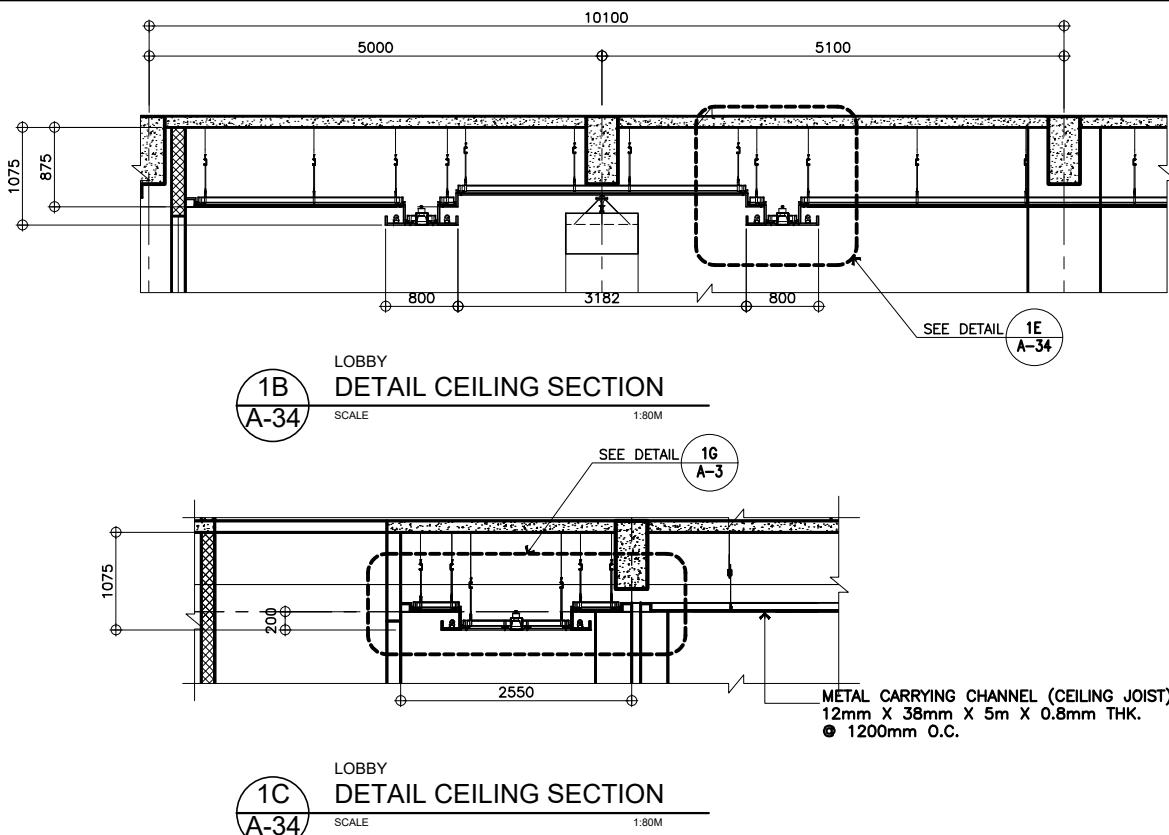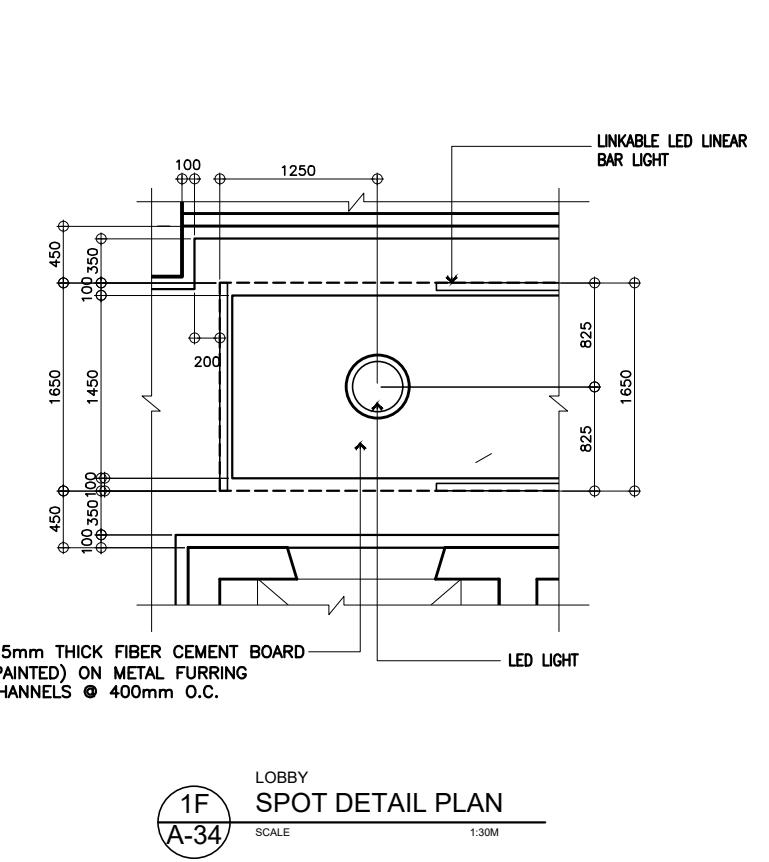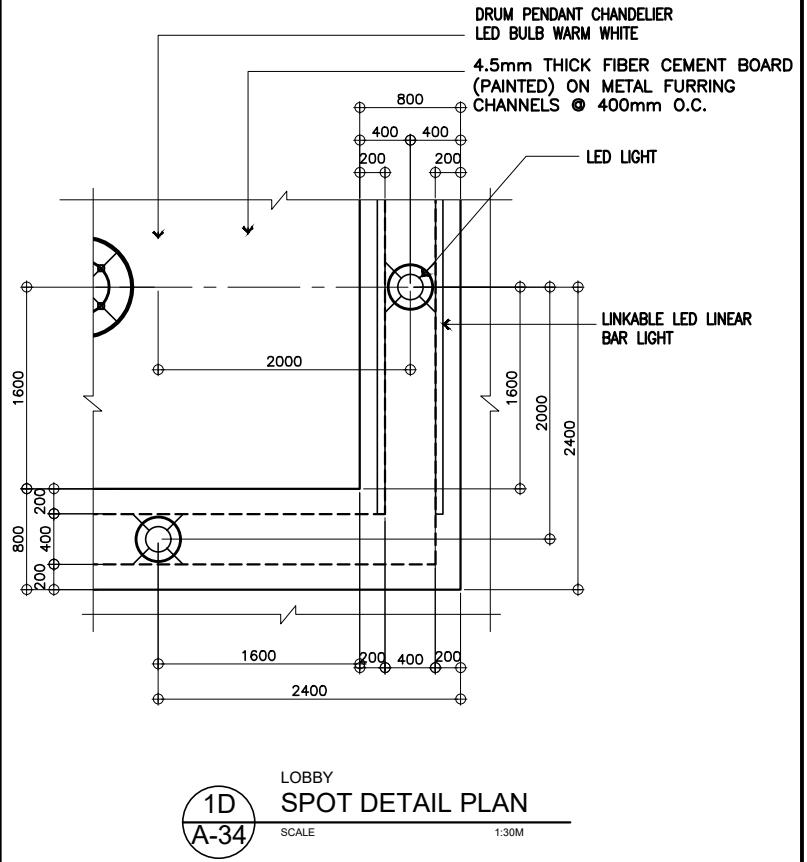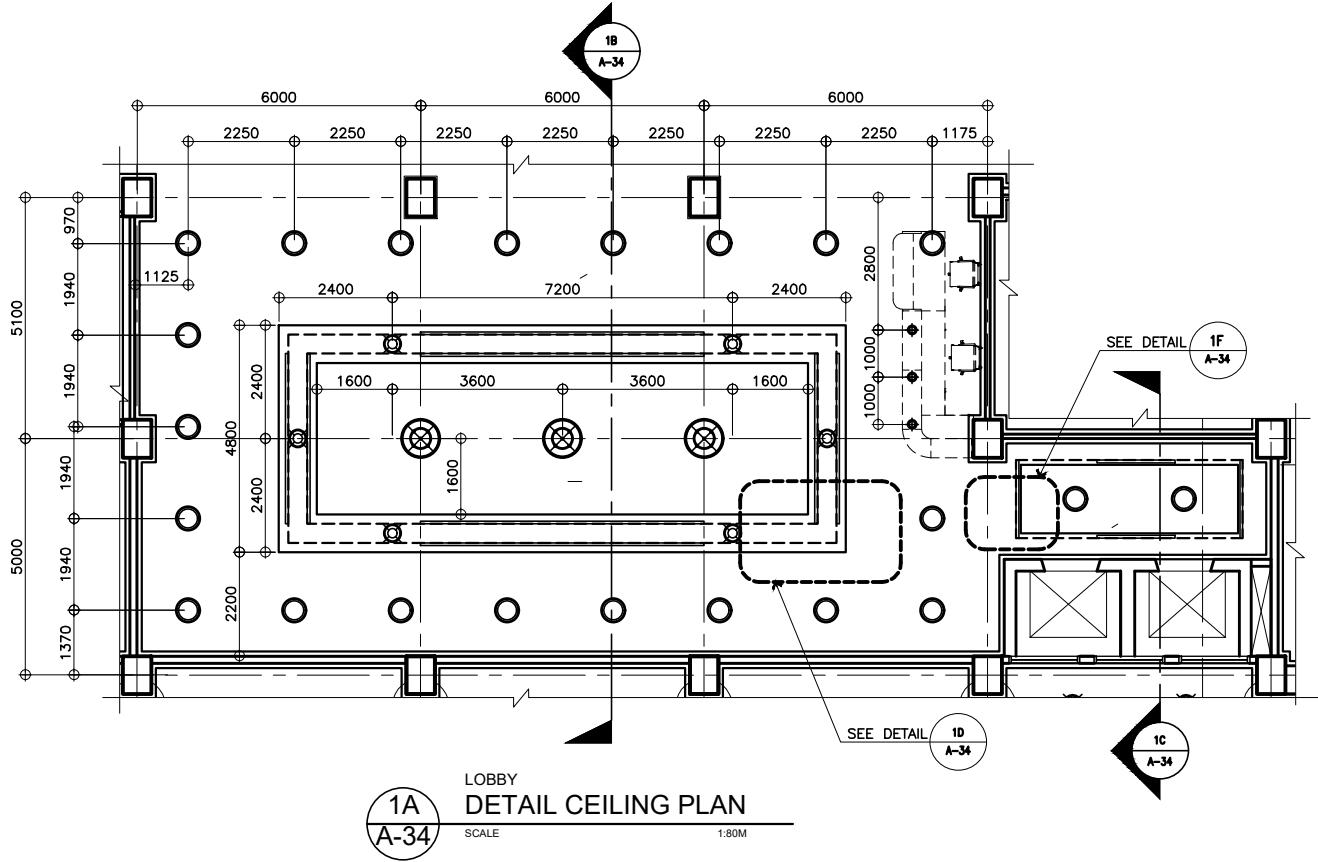

GROUND FLOOR
DETAILS OF LOBBY CEILING



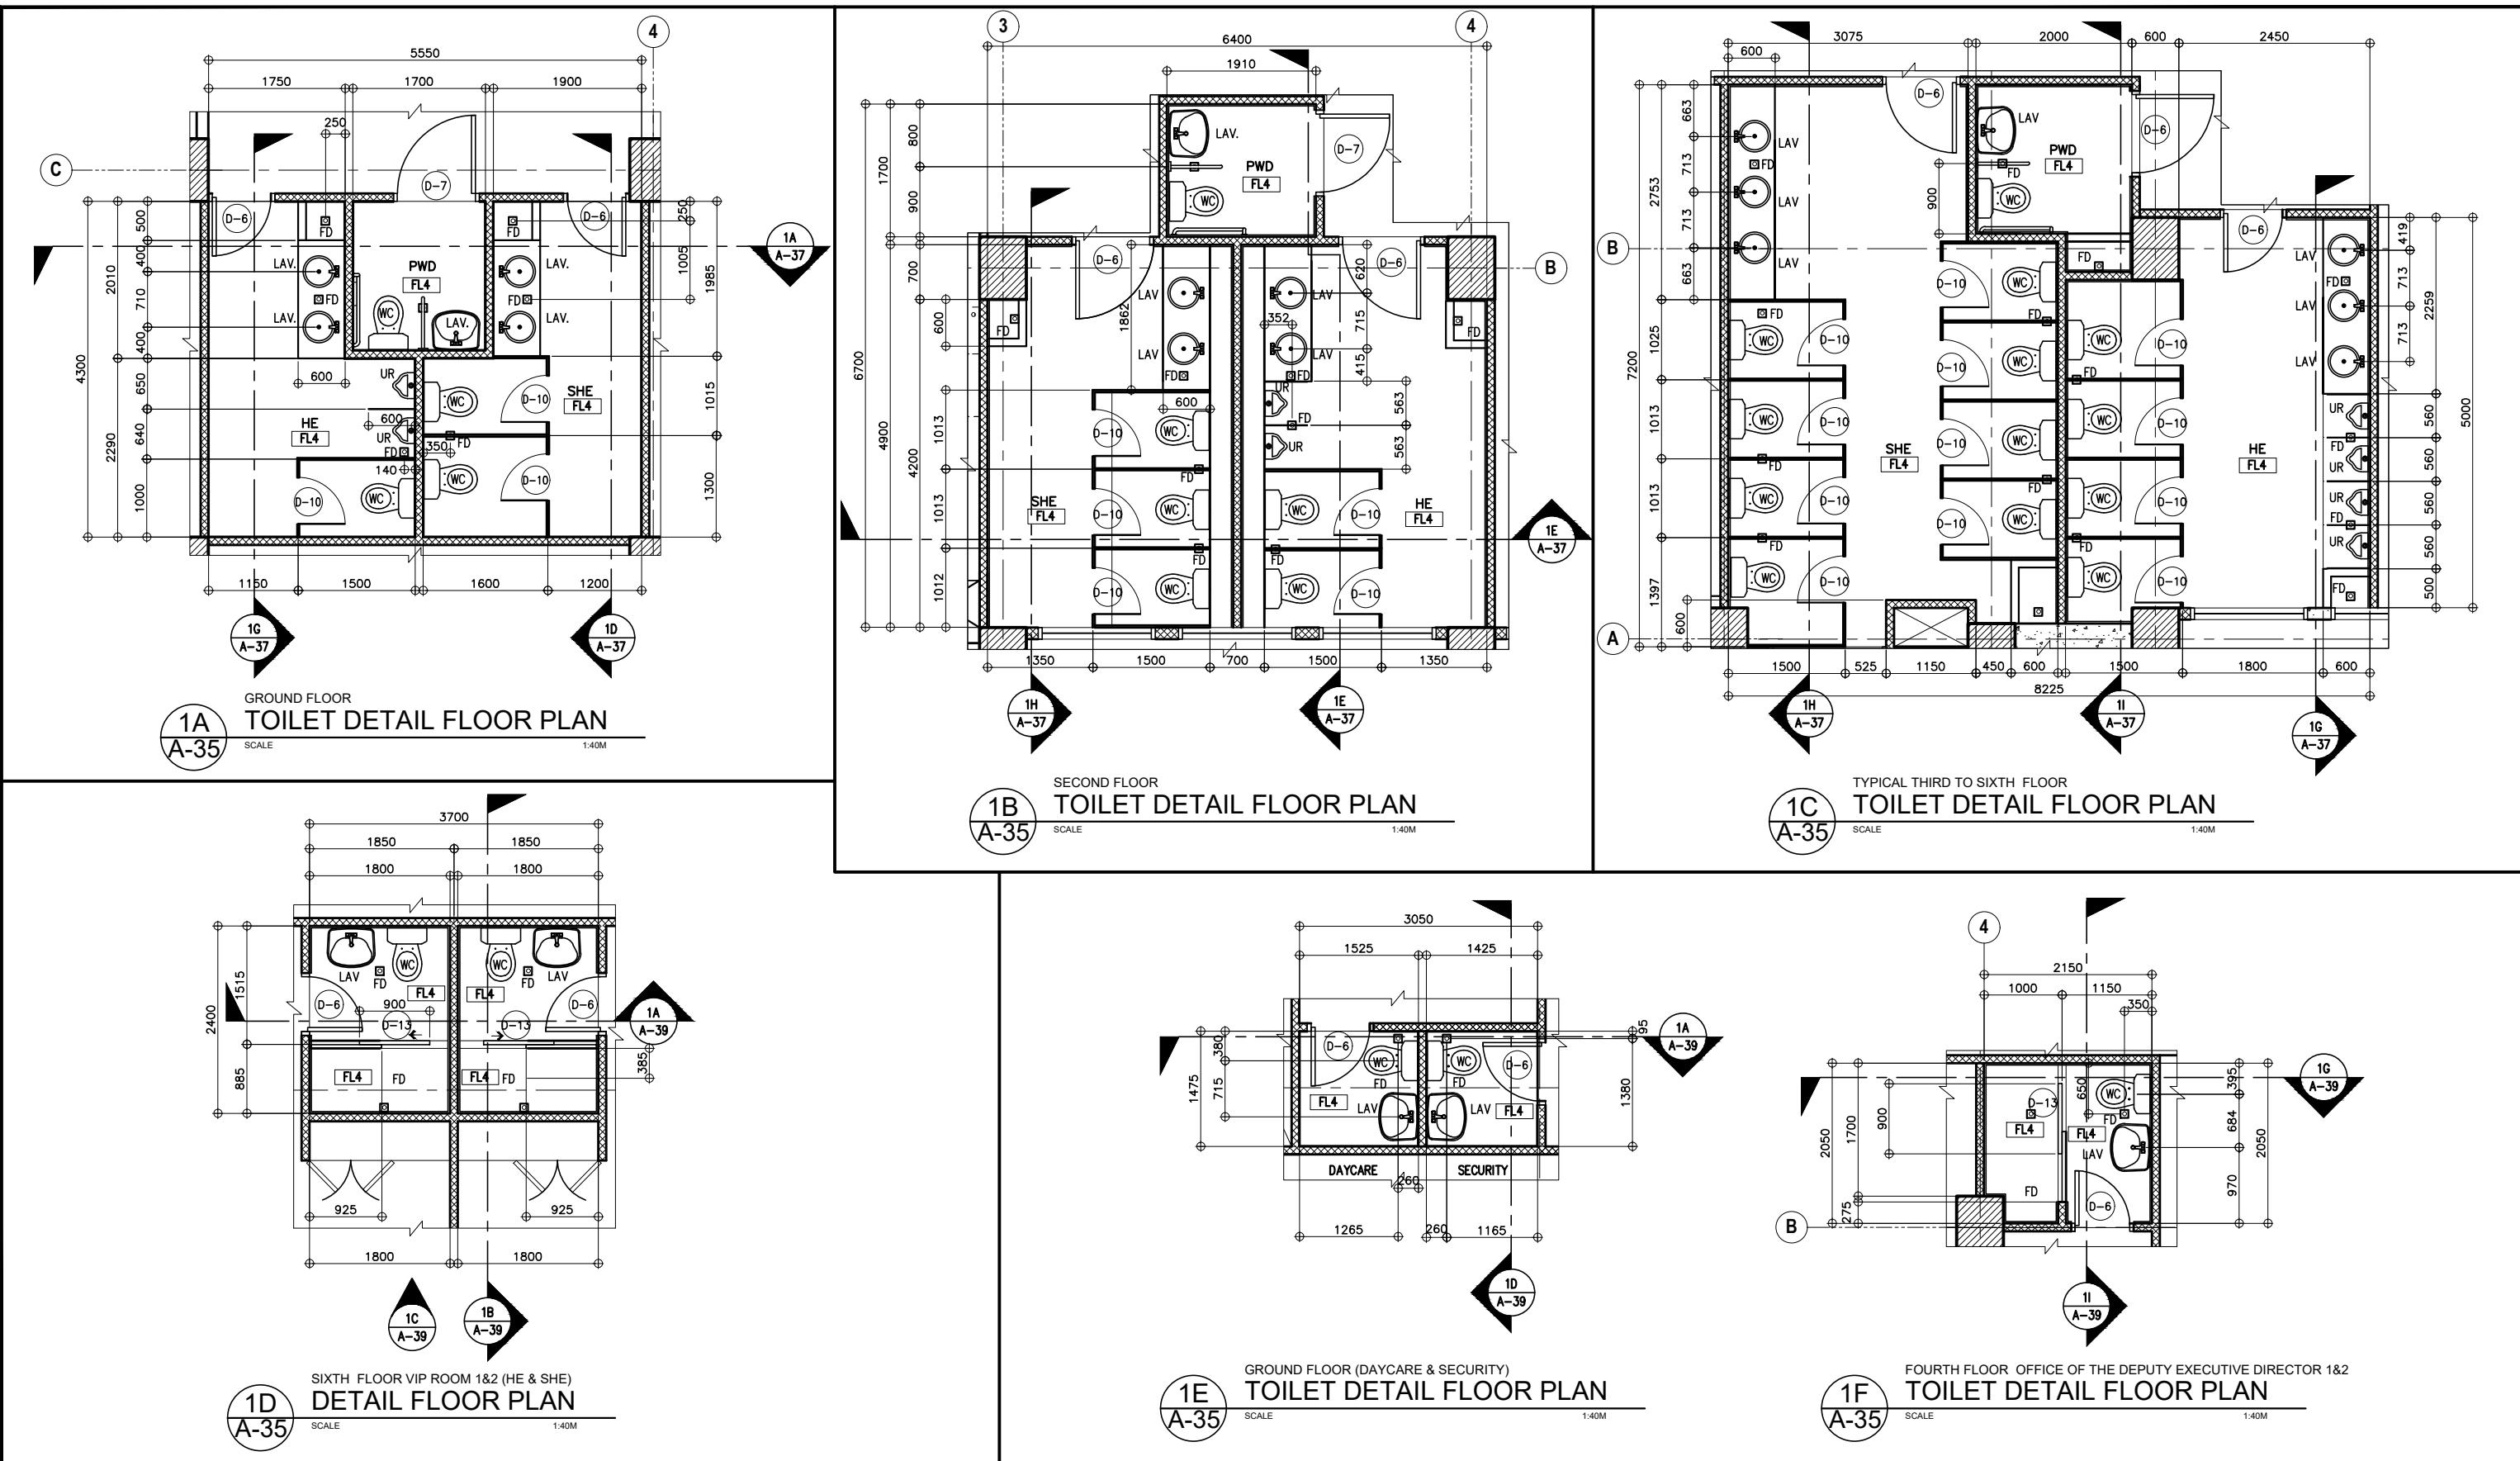


1 TOILET PLAN DETAILS

UNITED TECHNOLOGIES CONSOLIDATED PARTNERSHIP	PREPARED BY:	SUBMITTED BY:		REPUBLIC OF THE PHILIPPINES DEPARTMENT OF PUBLIC WORKS AND HIGHWAYS BUREAU OF DESIGN BUILDINGS DIVISION BONIFACIO DRIVE PORT AREA, MANILA	REVIEWED AS TO DESIGN CONCEPT:	RECOMMENDING APPROVAL:	APPROVED:	CONCURRED:	PROJECT & LOCATION / BARANGAY:	SHEET CONTENTS:	SET NO.	SHEET NO.
					JOSEPHINE P. ISTURIS CHIEF BUILDINGS DIVISION, BOD	(SEE COVER SHEET) LEA N. DELFINADO, CESO IV OFFICER-IN-CHARGE	(SEE COVER SHEET) EMIL K. SADAIN, CESO I UNDERSECRETARY FOR UPMO OPERATIONS & TECHNICAL SERVICES	(SEE COVER SHEET) ROWENA CANDICE M. RUIZ EXECUTIVE DIRECTOR	PROPOSED: PROPOSED SEVEN (7) STOREY GOVERNMENT PROCUREMENT POLICY BOARD (GPPB) UP DILIMAN COMPOUND, DILIMAN, QUEZON CITY	TOILET PLAN DETAILS	BOD A-35	37 216

NOTE:
PURSUANT TO SECTION 4 OF ANNEX "A" OF THE
REVISED IMPLEMENTING RULES AND REGULATION OF R.A. 9184,
APPROVAL BY THE AUTHORIZED DPWH OFFICIALS OF DETAILED
ENGINEERING SURVEYS AND DESIGN UNDERTAKEN BY CONSULTANTS
NEITHER DIMINISHES THE RESPONSIBILITY OF THE LATTER
FOR THE TECHNICAL INTEGRITY OF THE SURVEYS AND DESIGN
NOR TRANSFER ANY PART OF THAT RESPONSIBILITY TO THE
APPROVING OFFICIALS.

THE DESIGN CONSULTANT SHALL BE HELD FULLY RESPONSIBLE
FOR THE FAILURE OF THE FACILITY/IES/STRUCTURES
DUE TO FAULTY DESIGN EXCEPT FOR THE CHANGES MADE
WITHOUT THE CONFORMITY OF THE CONSULTANTS.

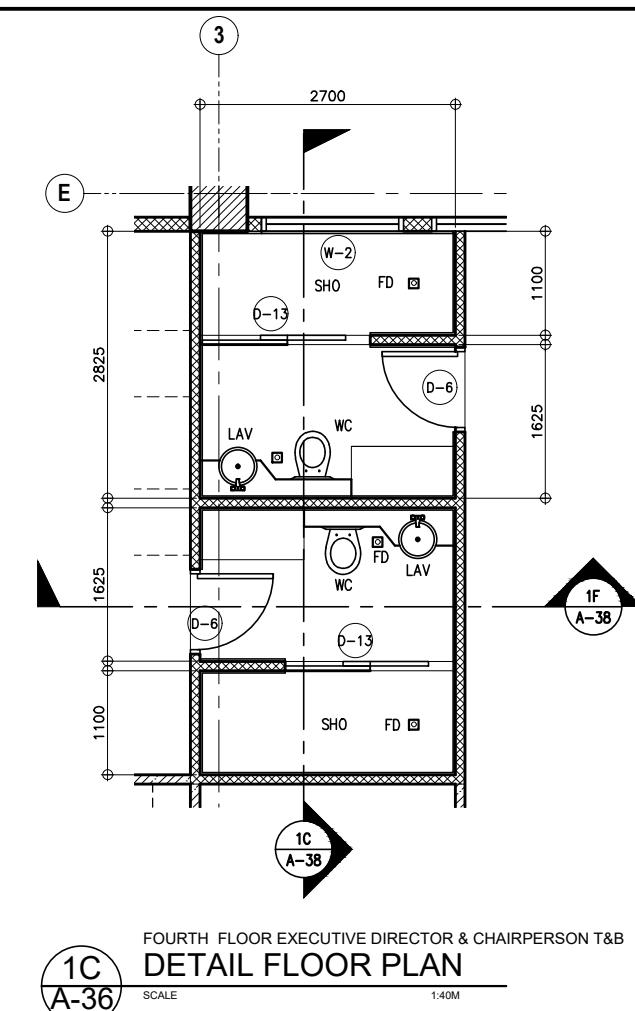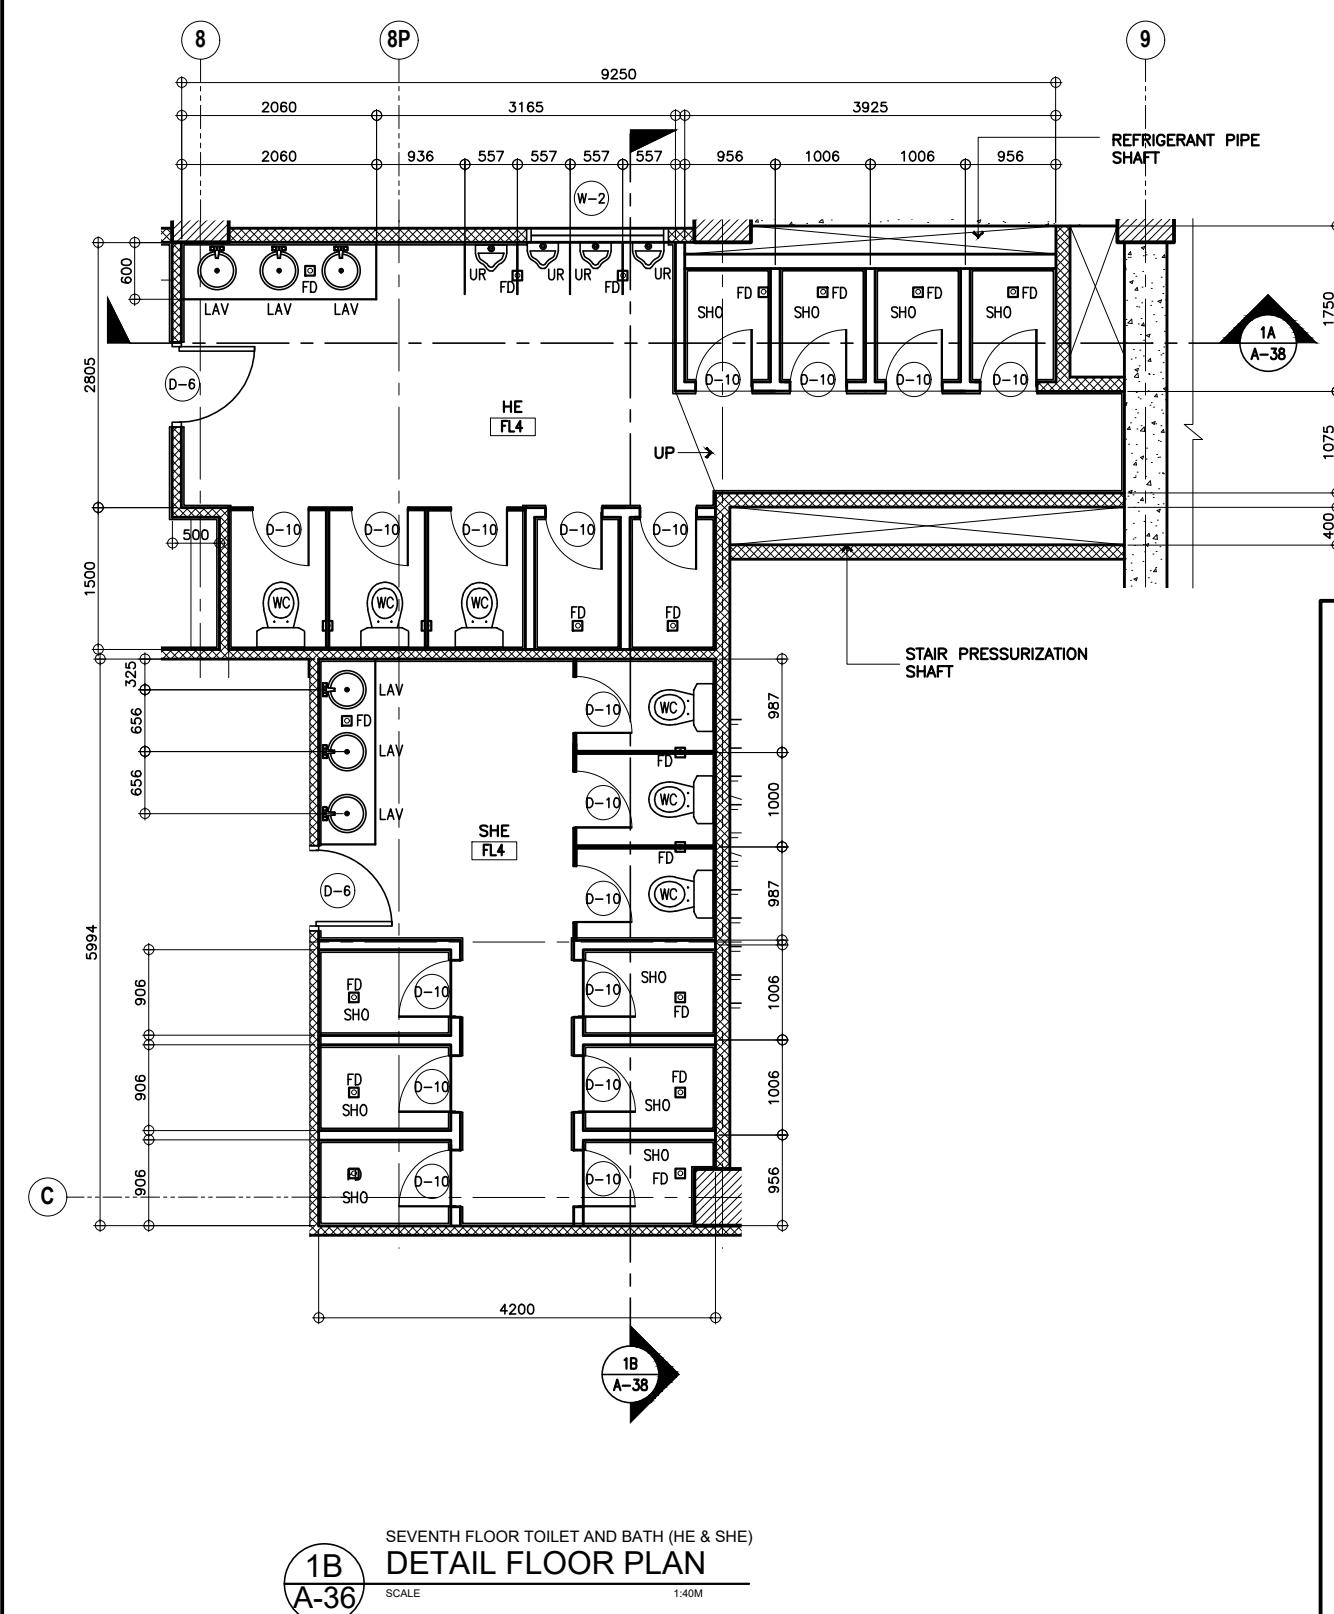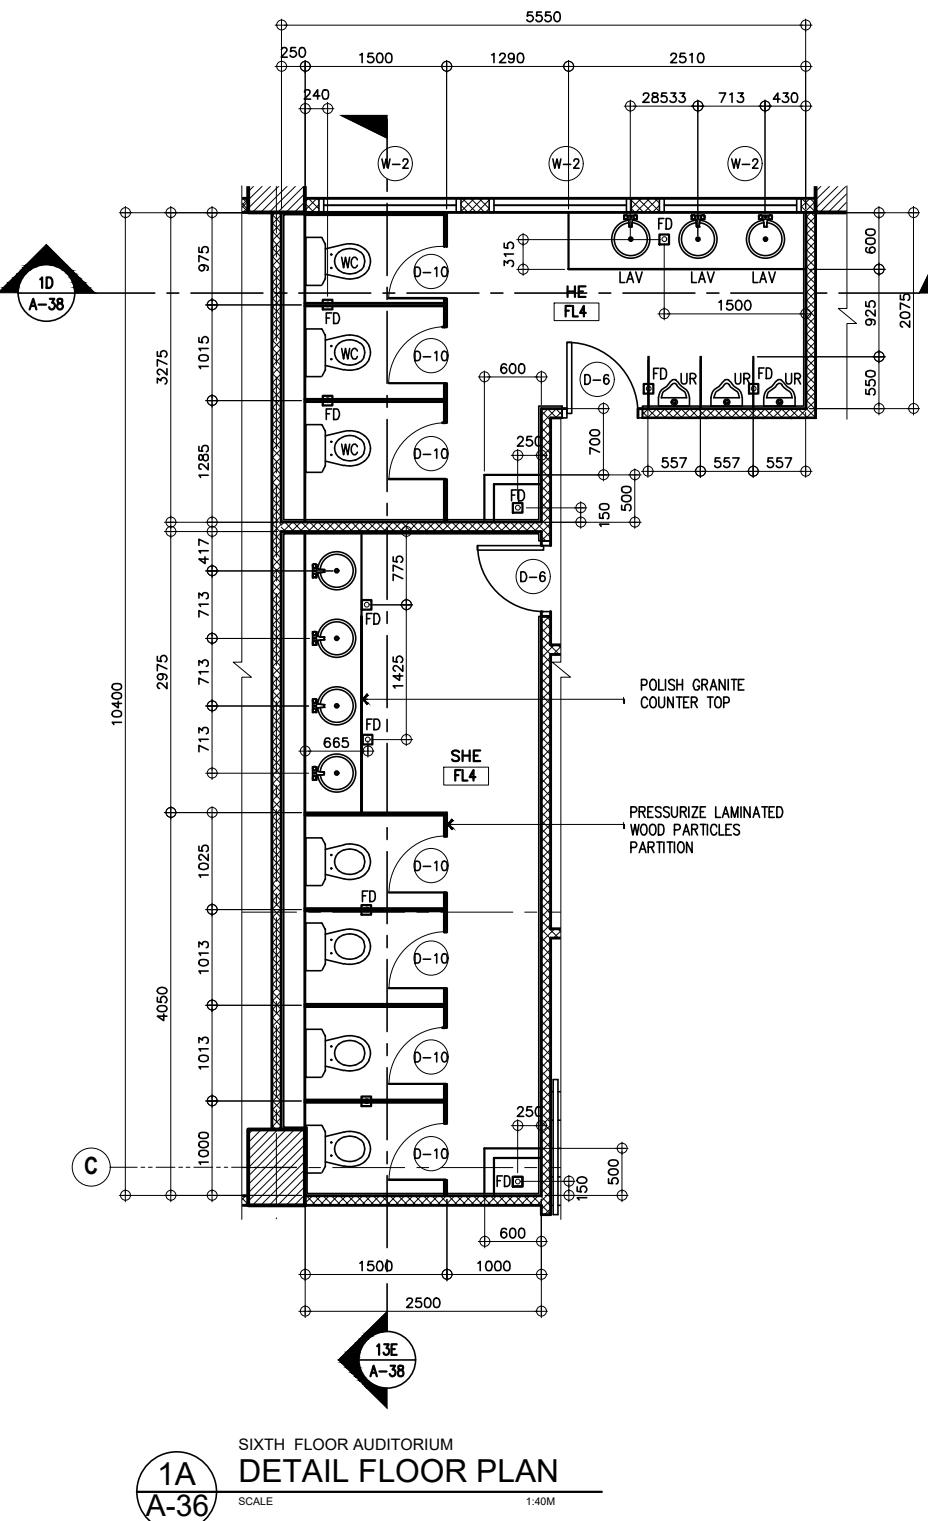


1 TOILET PLAN DETAILS
A-36


SCALE AS SHOWN

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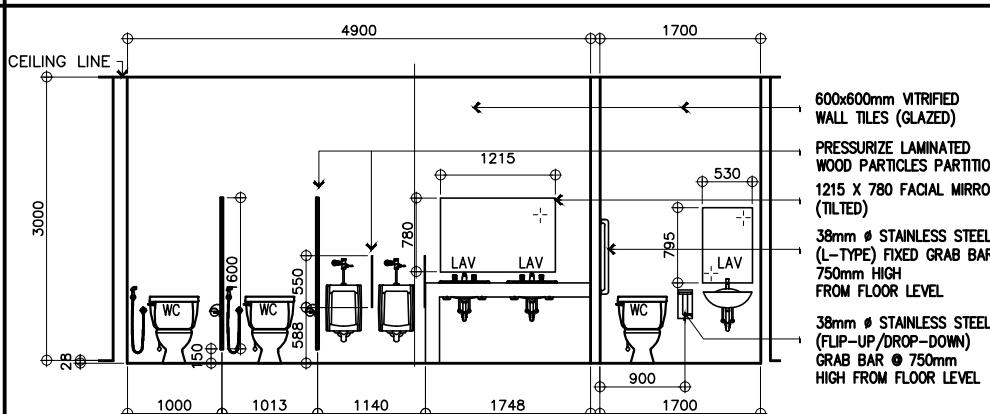
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ARMAN U. CUEVAS	CYNTHIA CLEMEN A. YU	JOSEPHINE P. ISTURIS	(SEE COVER SHEET)	(SEE COVER SHEET)	(SEE COVER SHEET)	PROPOSED: GOVERNMENT PROCUREMENT POLICY BOARD (GPPB) UP DILIMAN COMPOUND, DILIMAN, QUEZON CITY	TOILET PLAN DETAILS	BOD-A-36	38 216

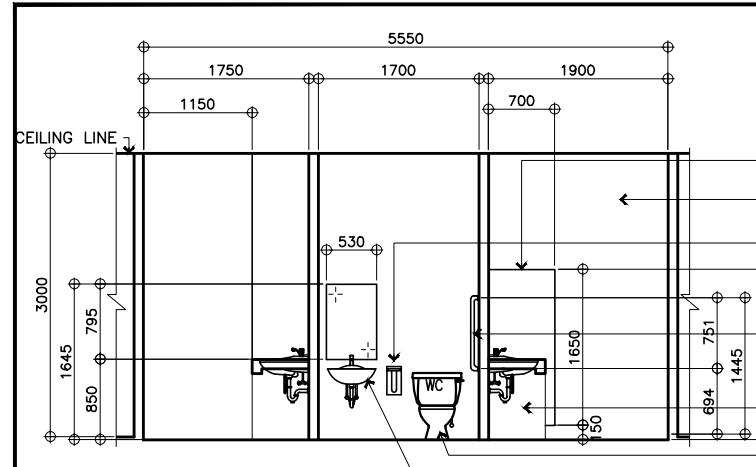


GROUND FLOOR
TOILET DETAIL SECTION
1A
A-37

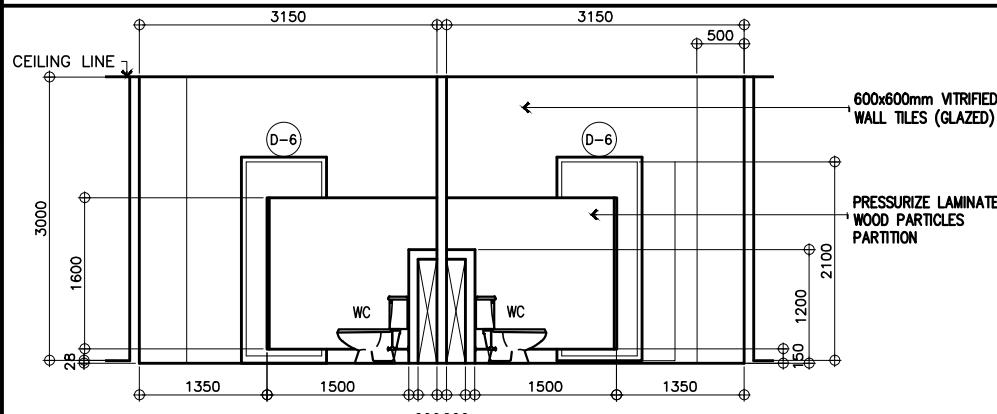


SECOND FLOOR
TOILET DETAIL SECTION
1B
A-37




SECOND FLOOR
TOILET DETAIL SECTION
1E
A-37

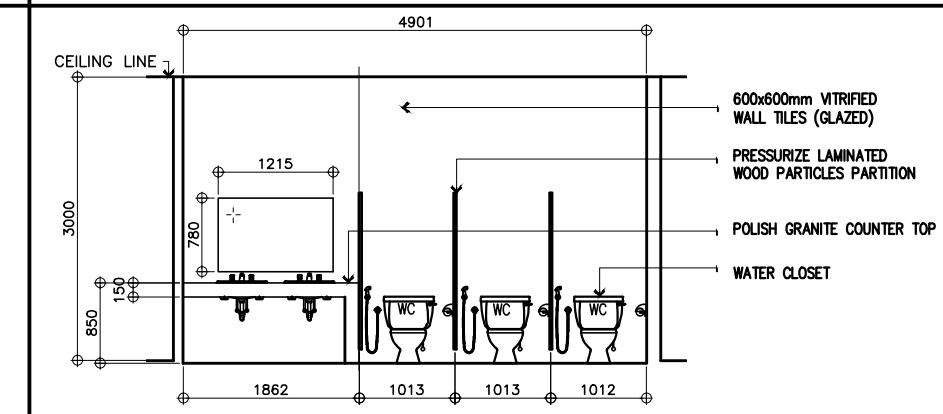


SECOND FLOOR
TOILET DETAIL SECTION
1H
A-37

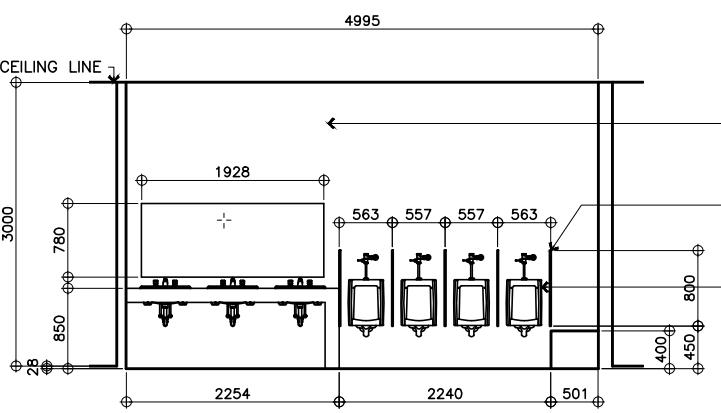

TYPICAL THIRD TO SIXTH FLOOR
TOILET DETAIL SECTION
1C
A-37






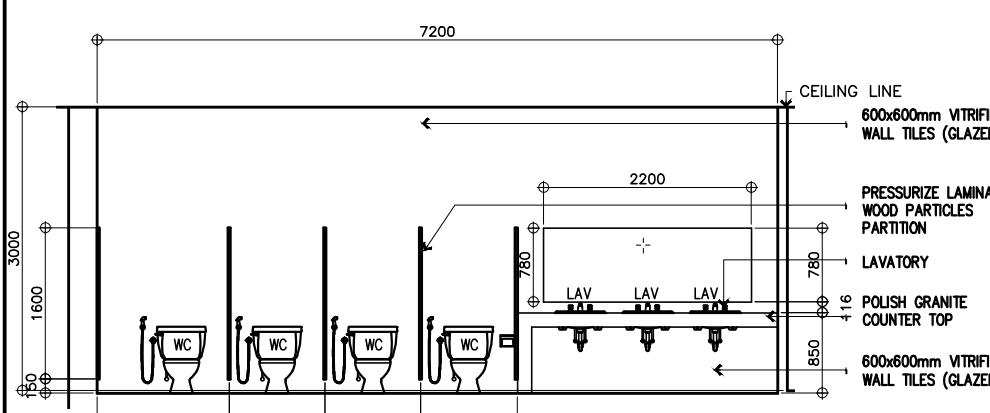


TYPICAL THIRD TO SIXTH FLOOR
TOILET DETAIL SECTION
1F
A-37

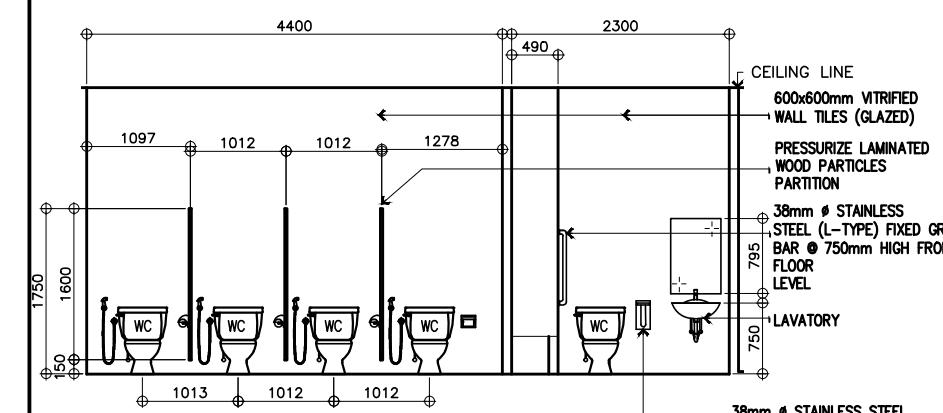

TYPICAL THIRD TO SIXTH FLOOR
TOILET DETAIL SECTION
11
A-37

1
TOILET SECTION DETAILS
A-37

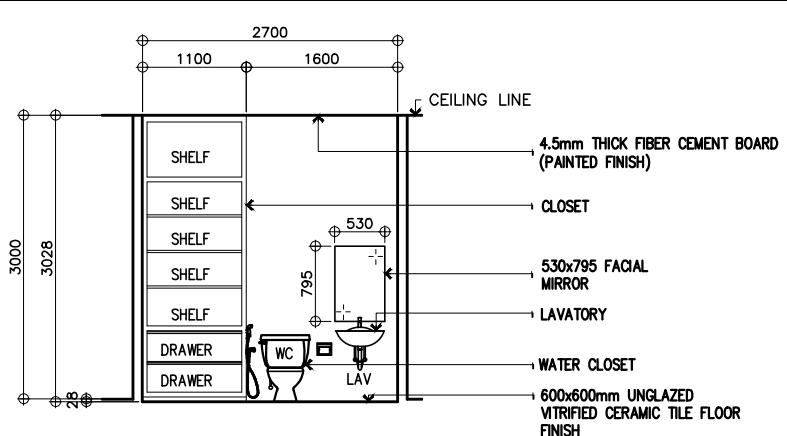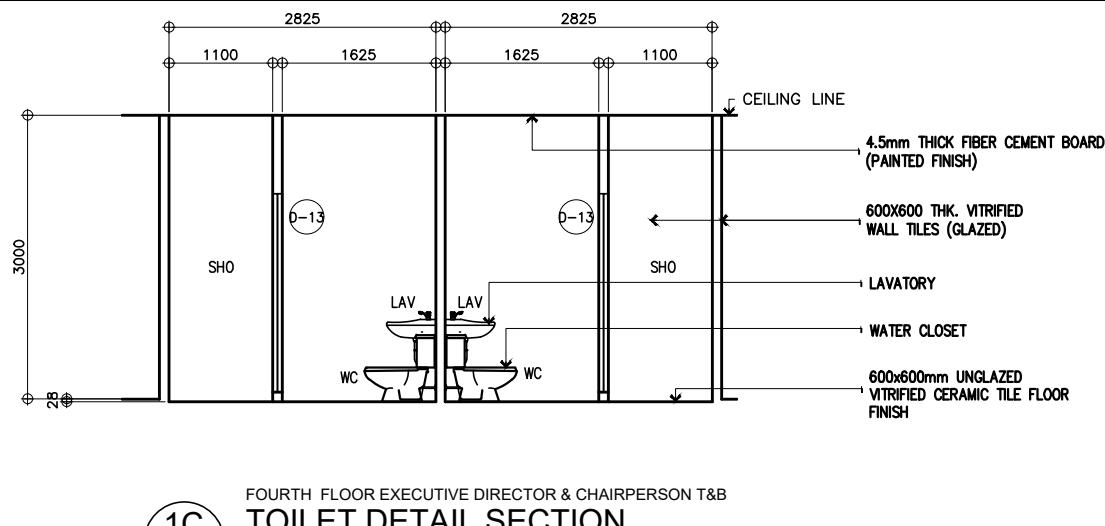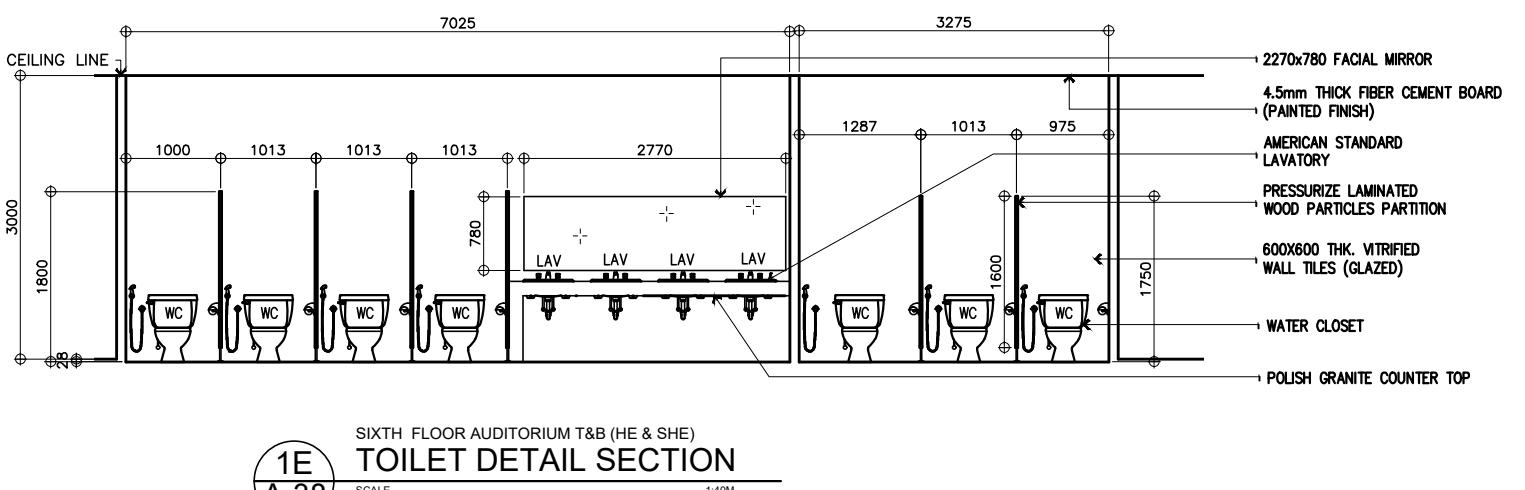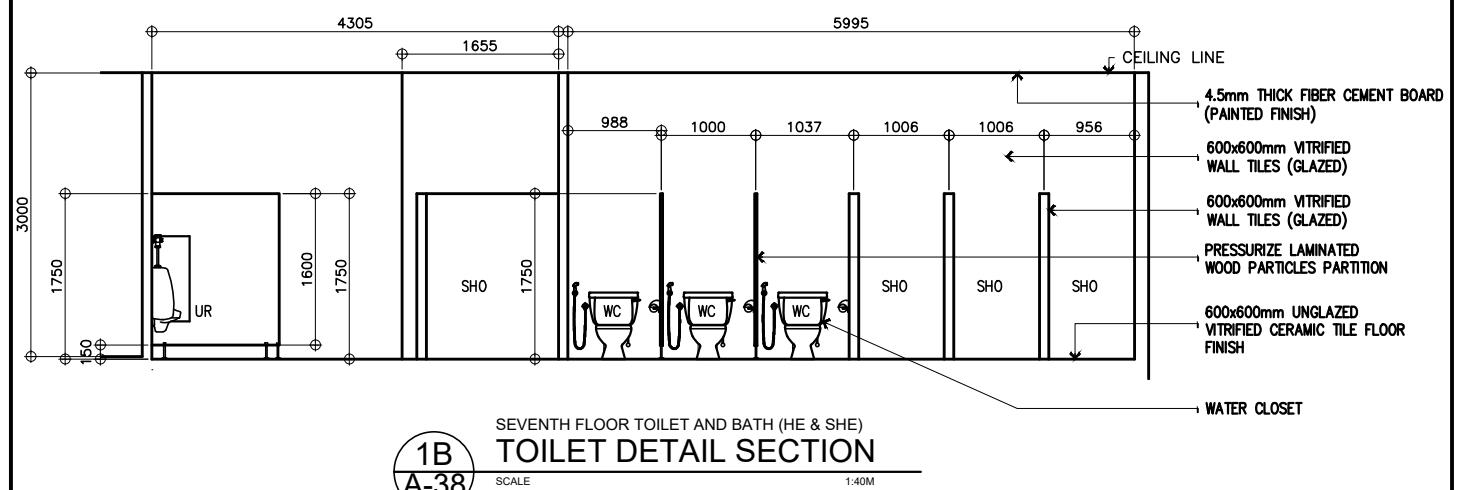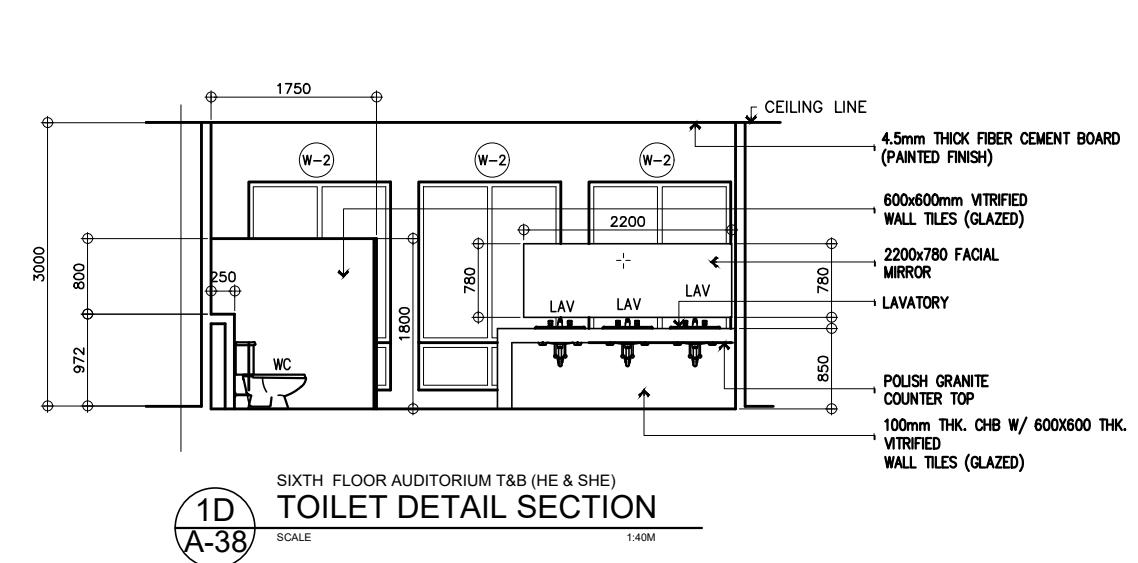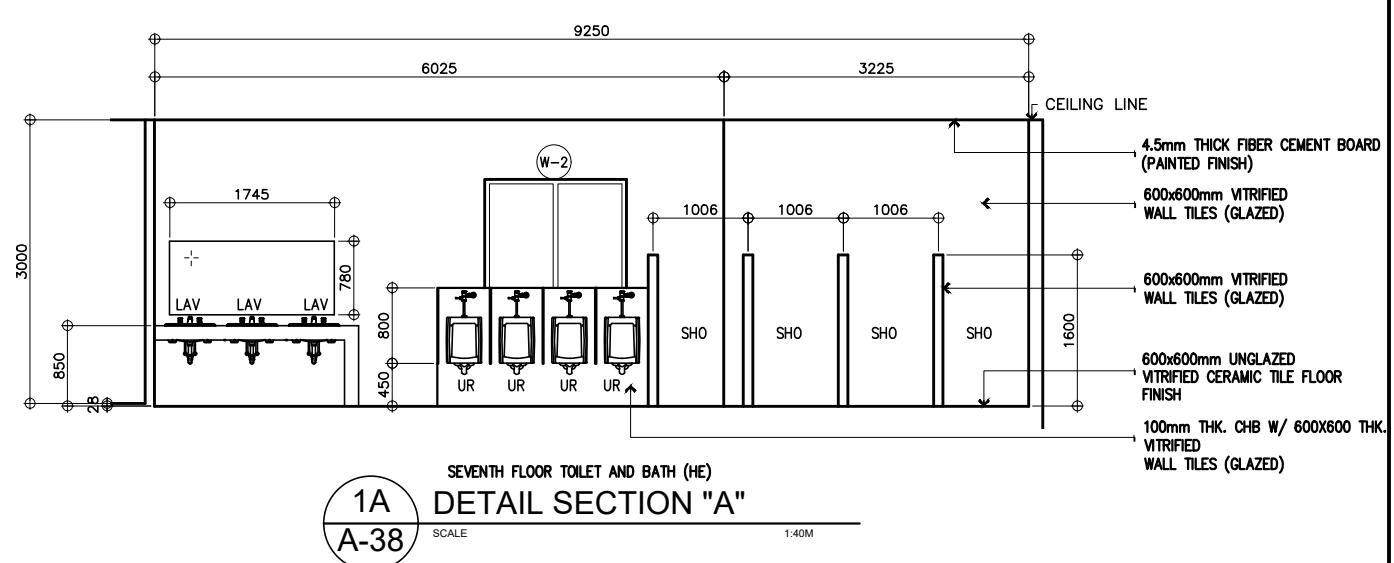


1 TOILET SECTION DETAILS
A-38 SCALE AS SHOWN


NOTE: PURSUANT TO SECTION 4 OF ANNEX "A" OF THE REVISED IMPLEMENTING RULES AND REGULATION OF R.A. 9184, APPROVAL BY THE AUTHORIZED DPWH OFFICIALS OF DETAILED ENGINEERING SURVEYS AND DESIGN UNDERTAKEN BY CONSULTANTS NEITHER DIMINISHES THE RESPONSIBILITY OF THE LATTER FOR THE TECHNICAL INTEGRITY OF THE SURVEYS AND DESIGN NOR TRANSFER ANY PART OF THAT RESPONSIBILITY TO THE APPROVING OFFICIALS.

THE DESIGN CONSULTANT SHALL BE HELD FULLY RESPONSIBLE FOR THE FAILURE OF THE FACILITY/IES/STRUCTURES DUE TO FAULTY DESIGN EXCEPT FOR THE CHANGES MADE WITHOUT THE CONFORMITY OF THE CONSULTANTS.


 UNITED TECHNOLOGIES CONSOLIDATED PARTNERSHIP	PREPARED BY:	SUBMITTED BY:	 REPUBLIC OF THE PHILIPPINES DEPARTMENT OF PUBLIC WORKS AND HIGHWAYS BUREAU OF DESIGN BUILDINGS DIVISION BONIFACIO DRIVE PORT AREA, MANILA	REVIEWED AS TO DESIGN CONCEPT:	RECOMMENDING APPROVAL:	APPROVED:	CONCURRED:	PROJECT & LOCATION / BARANGAY:	SHEET CONTENTS:	SET NO.	SHEET NO.
	ARMAN U. CUEVAS	CYNTHIA CLEMEN A. YU		(SEE COVER SHEET)	(SEE COVER SHEET)	(SEE COVER SHEET)	(SEE COVER SHEET)	PROPOSED: PROPOSED SEVEN (7) STOREY GOVERNMENT PROCUREMENT POLICY BOARD (GPPB) UP DILIM COMPOUND, DILIMAN, QUEZON CITY	TOILET SECTION DETAILS	BOD A-38	40 216
ARCHITECTURAL DESIGN POSITION: ARCHITECT PRC No.: 0018676 TIN No.: 907-359-364 PTB No.: 4010896		ARCHITECT/TEAM LEADER	JOSEPHINE P. ISTURIS	LEA N. DELFINADO, CESO IV	EMIL K. SADAIN, CESO I	ROWENA CANDICE M. RUIZ					
			CHIEF, BUILDINGS DIVISION, BOD	OFFICER-IN-CHARGE	UNDERSECRETARY FOR UPMO OPERATIONS & TECHNICAL SERVICES	EXECUTIVE DIRECTOR					

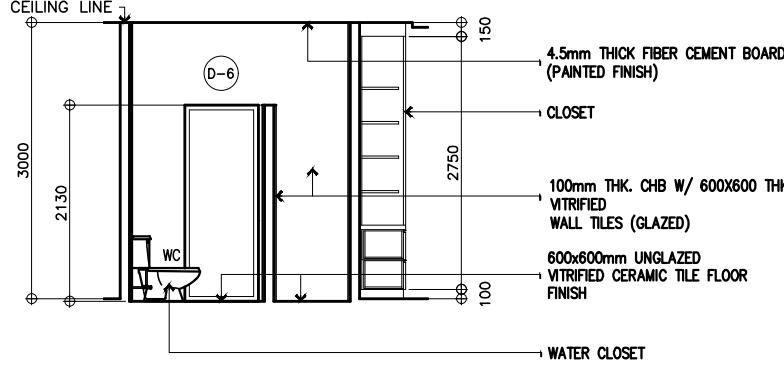


SIXTH FLOOR VIP ROOM 1&2 (SHE)
TOILET DETAIL SECTION
1A
A-39

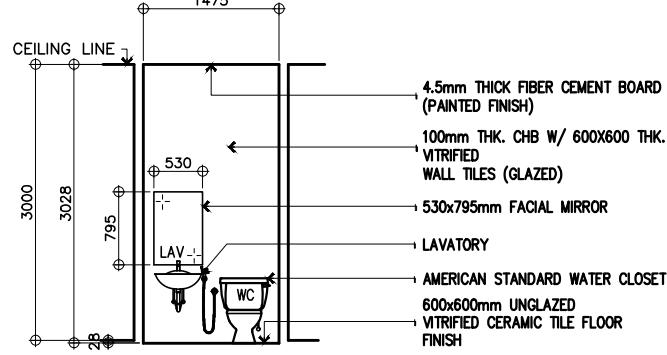


GROUND FLOOR (DAYCARE & SECURITY)
TOILET DETAIL SECTION
1D
A-39

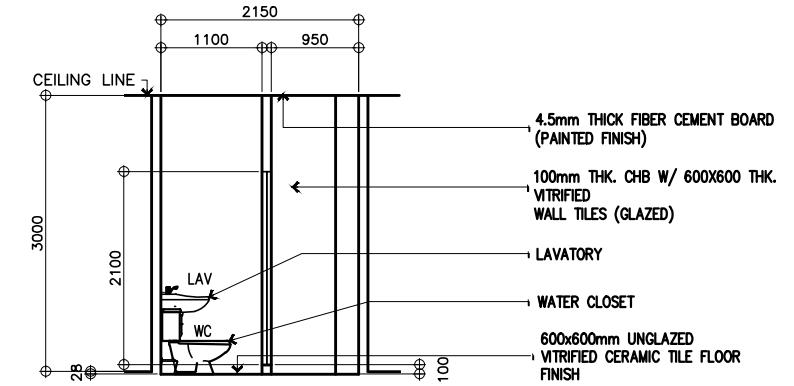


FOURTH FLOOR OFFICE OF THE DEPUTY EXECUTIVE DIRECTOR 1&2
TOILET DETAIL SECTION
1G
A-39

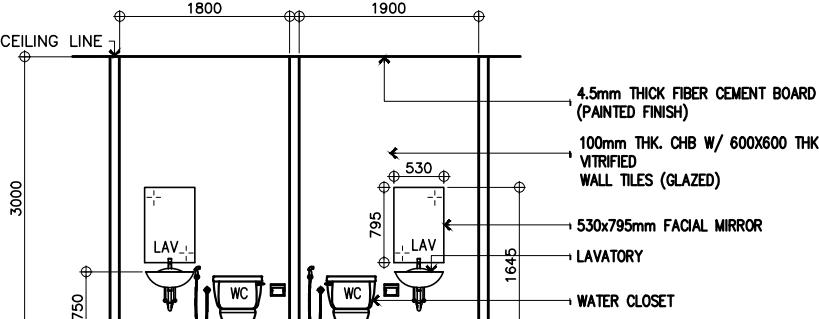

SIXTH FLOOR VIP ROOM 1&2 (SHE)
TOILET DETAIL SECTION
1B
A-39

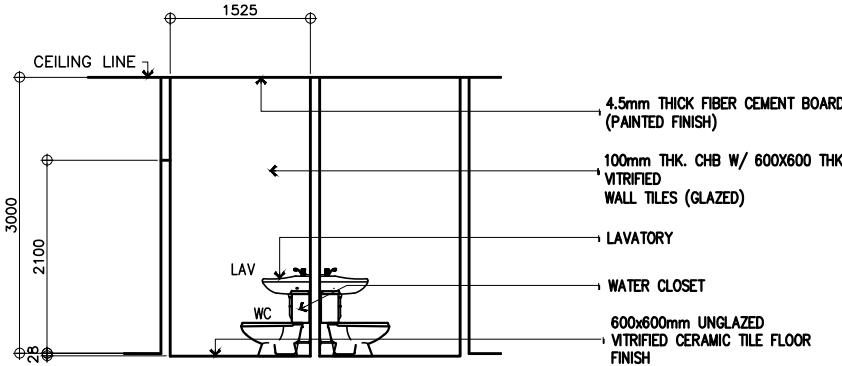


GROUND FLOOR (DAYCARE & SECURITY)
TOILET DETAIL SECTION
1E
A-39

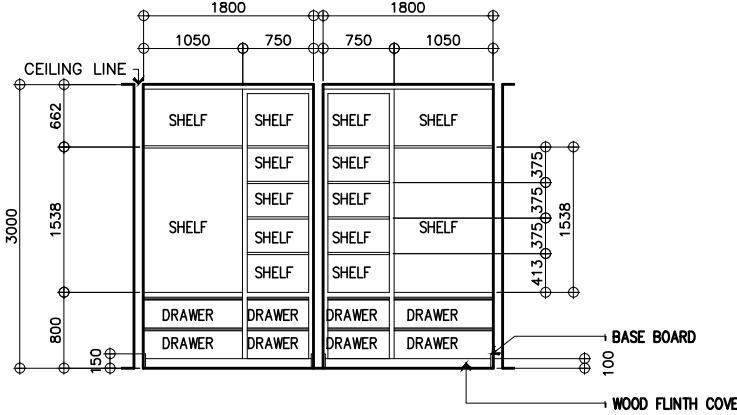


SIXTH FLOOR VIP ROOM 1&2 (SHE)
TOILET DETAIL SECTION
1C
A-39

NOTE: PURSUANT TO SECTION 4 OF ANNEX "A" OF THE REVISED IMPLEMENTING RULES AND REGULATION OF R.A. 9164, APPROVAL BY THE AUTHORIZED DPWH OFFICIALS OF DETAILED ENGINEERING SURVEYS AND DESIGN UNDERTAKEN BY CONSULTANTS NEITHER DIMINISHES THE RESPONSIBILITY OF THE LATTER FOR THE TECHNICAL INTEGRITY OF THE SURVEYS AND DESIGN NOR TRANSFER ANY PART OF THAT RESPONSIBILITY TO THE APPROVING OFFICIALS.


THE DESIGN CONSULTANT SHALL BE HELD FULLY RESPONSIBLE FOR THE FAILURE OF THE FACILITY/IES/STRUCTURES DUE TO FAULTY DESIGN EXCEPT FOR THE CHANGES MADE WITHOUT THE CONFORMITY OF THE CONSULTANTS.

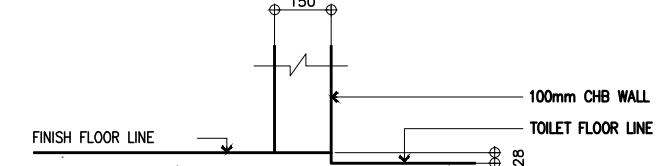

FOURTH FLOOR OFFICE OF THE DEPUTY EXECUTIVE DIRECTOR 1&2
TOILET DETAIL SECTION
1H
A-39














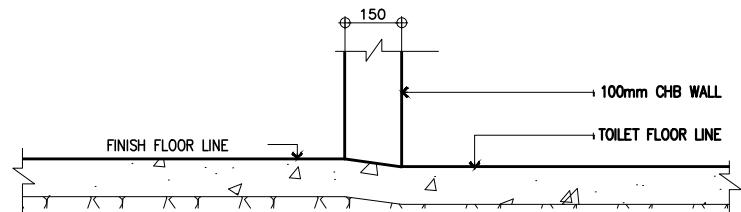


DETAIL SECTION FLR. DROP
1F
A-39

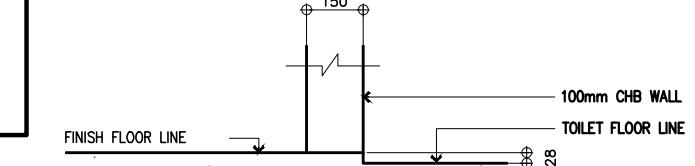

DETAIL SECTION FLR. DROP
1I
A-39

1 TOILET SECTION DETAILS A-39

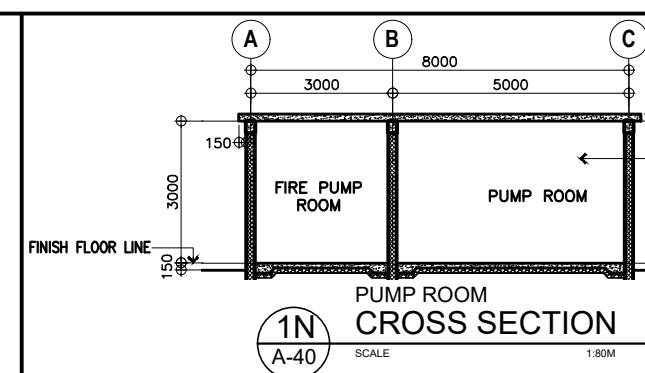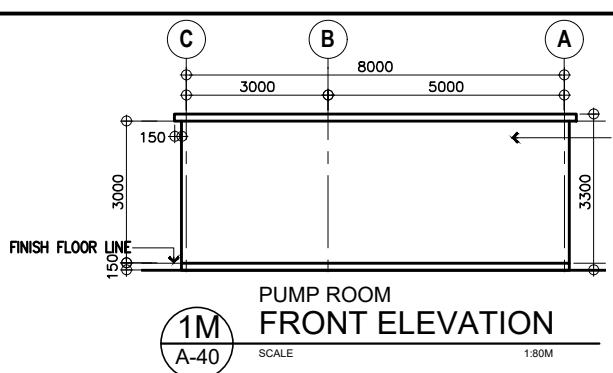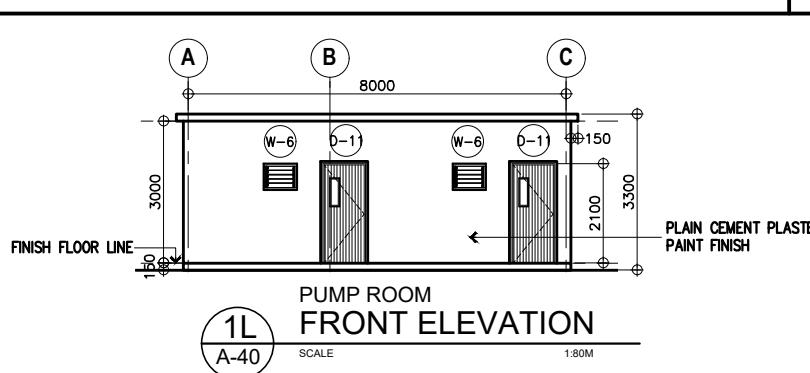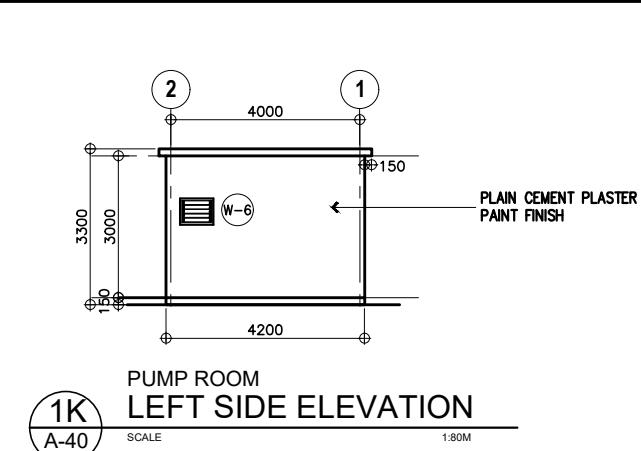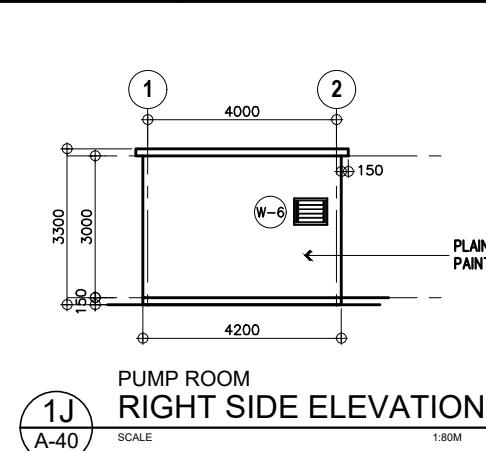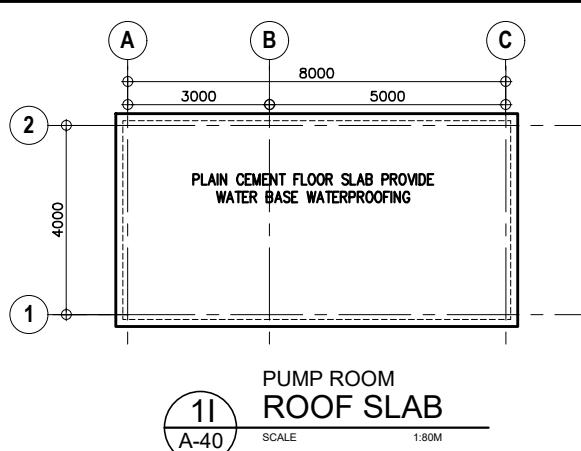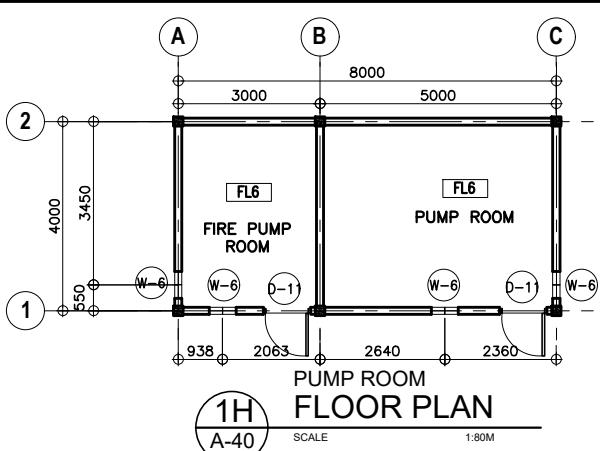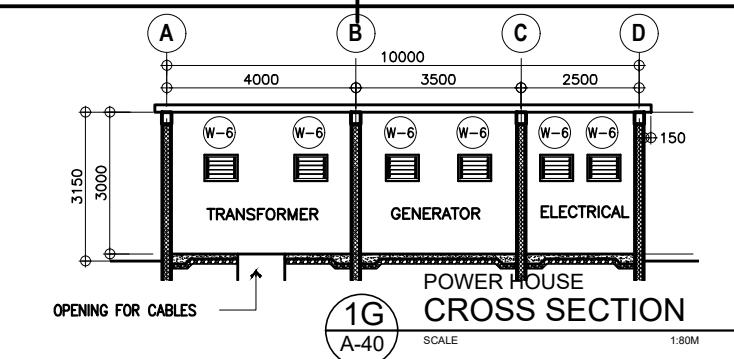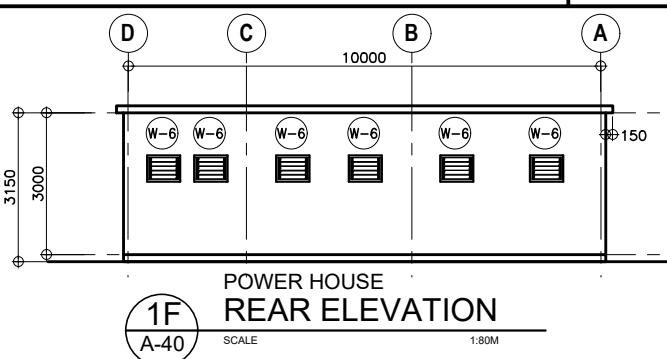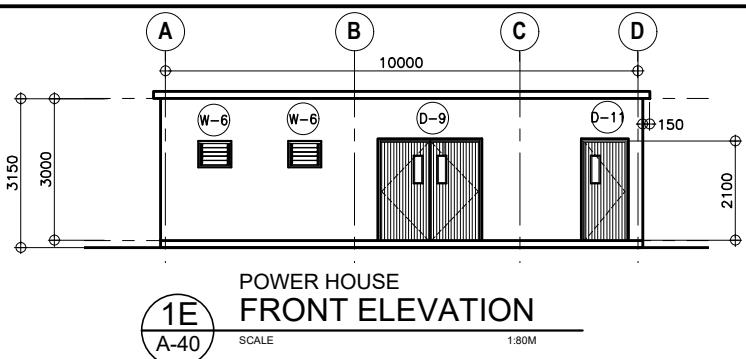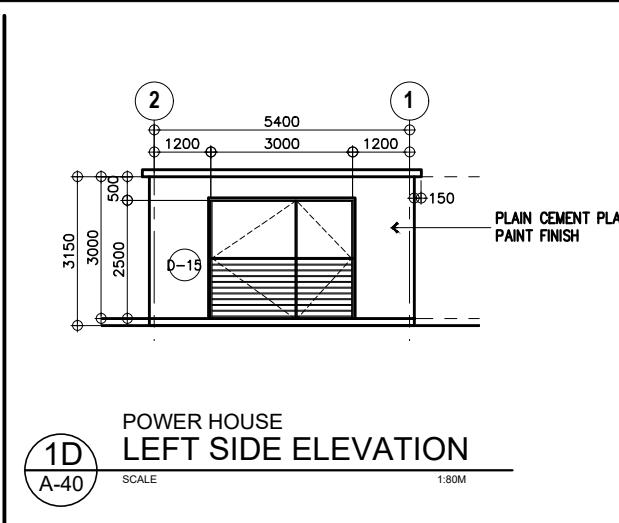
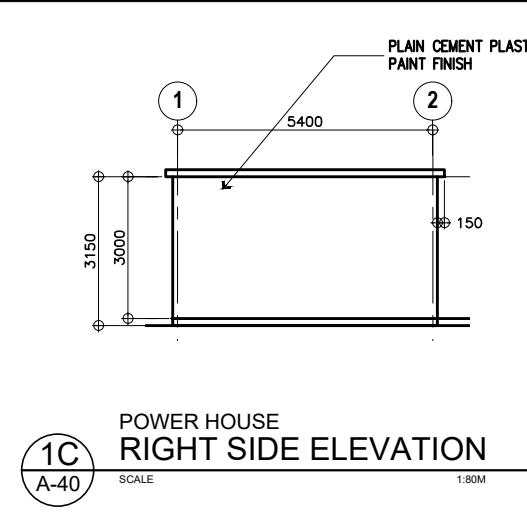
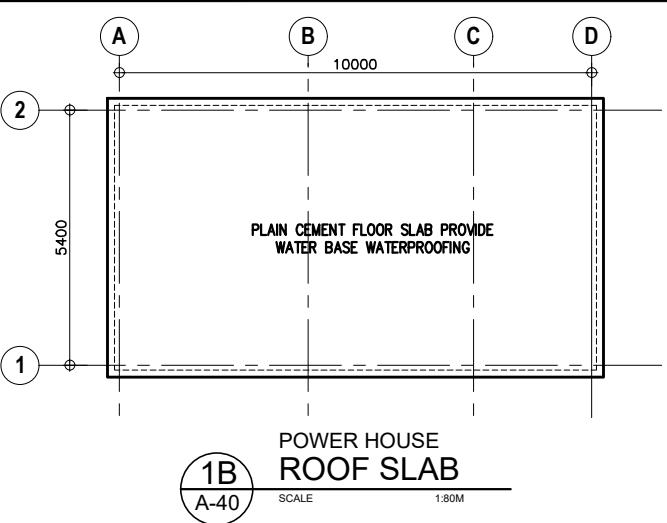
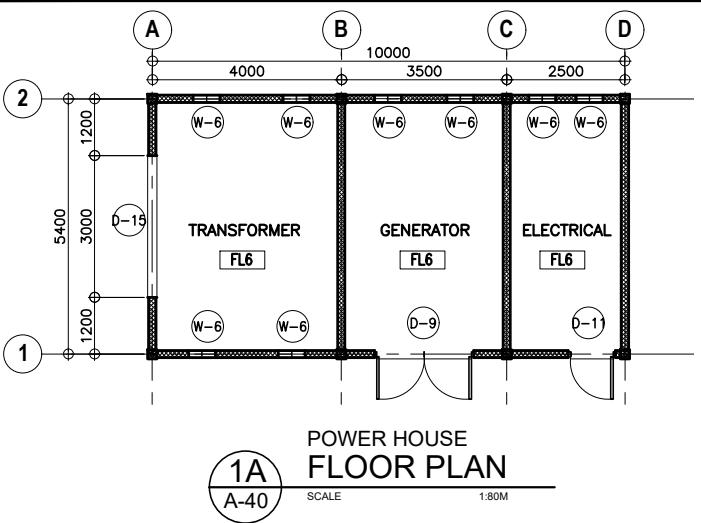


NOTE: PURSUANT TO SECTION 4 OF ANNEX "A" OF THE REVISED IMPLEMENTING RULES AND REGULATION OF R.A. 9164, APPROVAL BY THE AUTHORIZED DPWH OFFICIALS OF DETAILED ENGINEERING SURVEYS AND DESIGN UNDERTAKEN BY CONSULTANTS NEITHER DIMINISHES THE RESPONSIBILITY OF THE LATTER FOR THE TECHNICAL INTEGRITY OF THE SURVEYS AND DESIGN NOR TRANSFER ANY PART OF THAT RESPONSIBILITY TO THE APPROVING OFFICIALS.

THE DESIGN CONSULTANT SHALL BE HELD FULLY RESPONSIBLE FOR THE FAILURE OF THE FACILITY/IES/STRUCTURES DUE TO FAULTY DESIGN EXCEPT FOR THE CHANGES MADE WITHOUT THE CONFORMITY OF THE CONSULTANTS.


1 POWER HOUSE & PUMP ROOM DETAILS



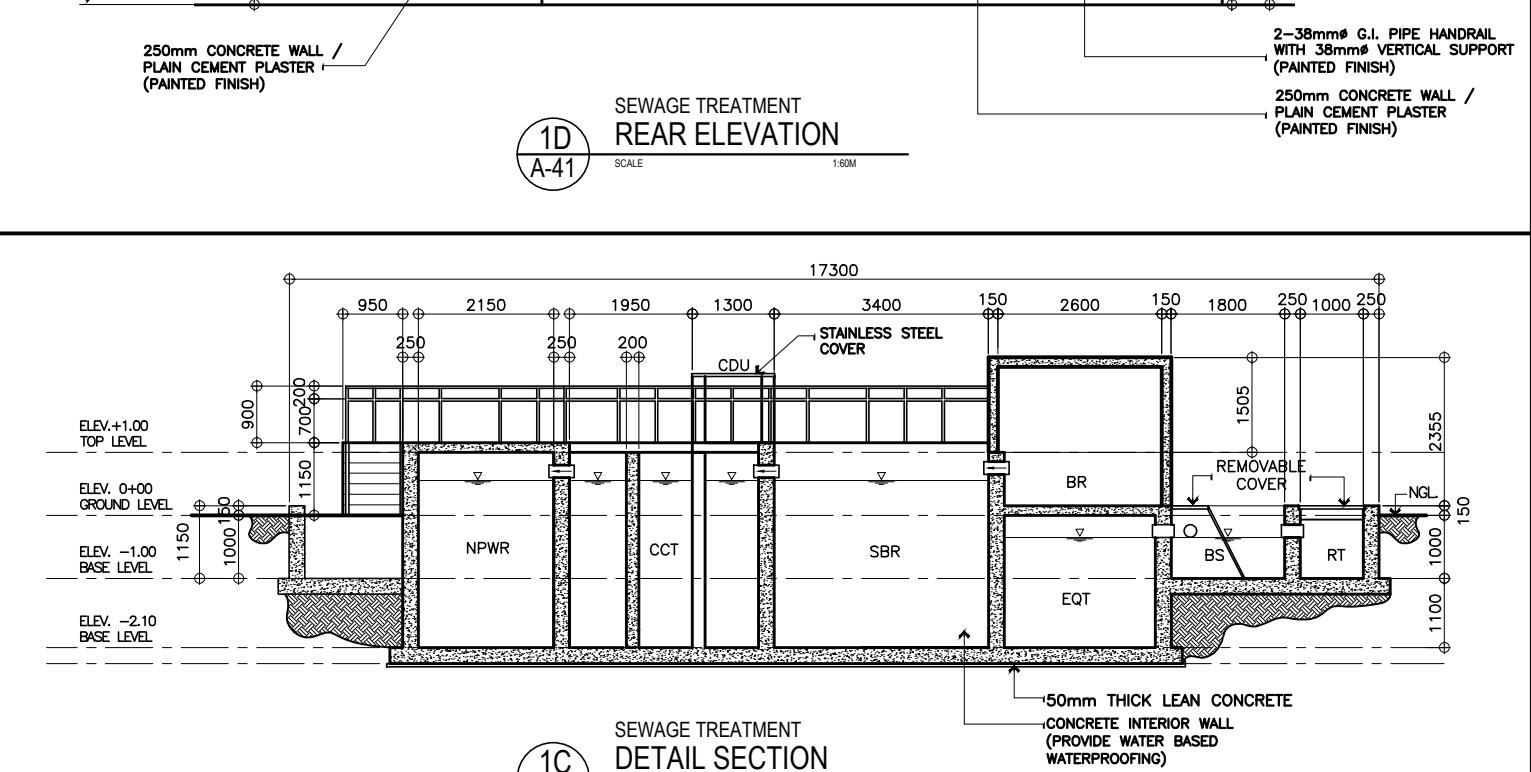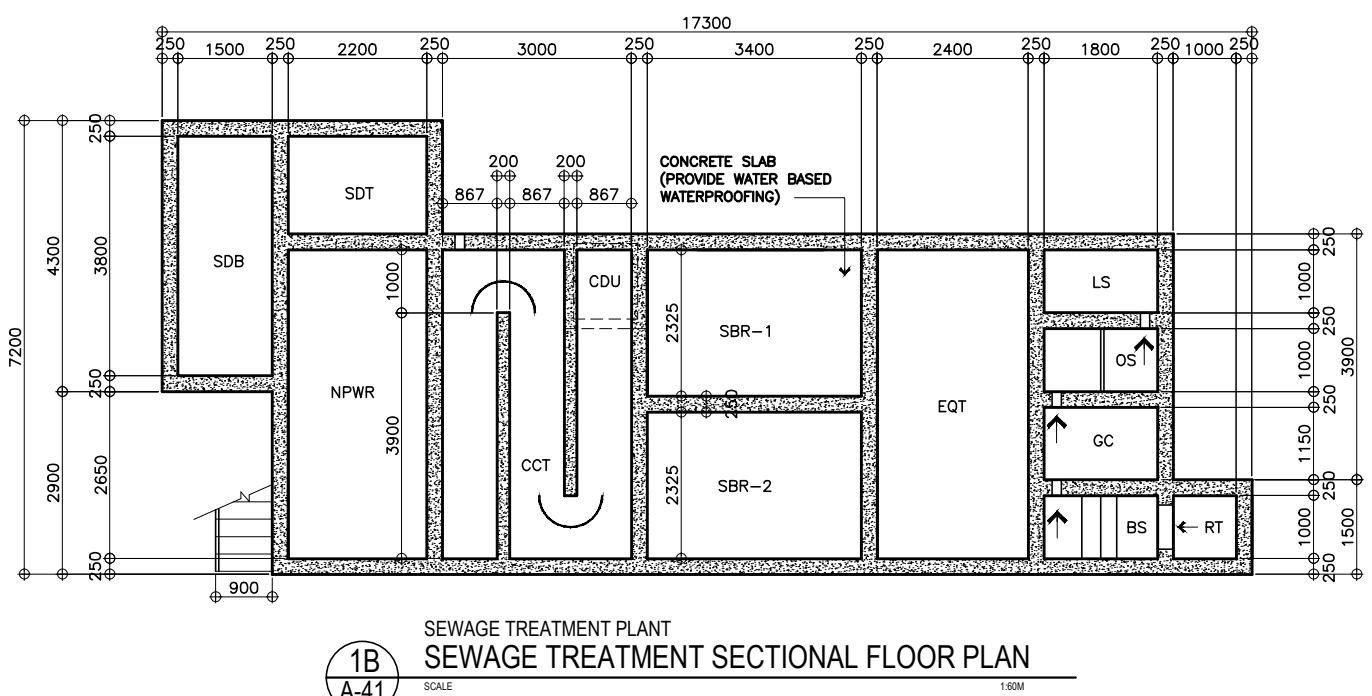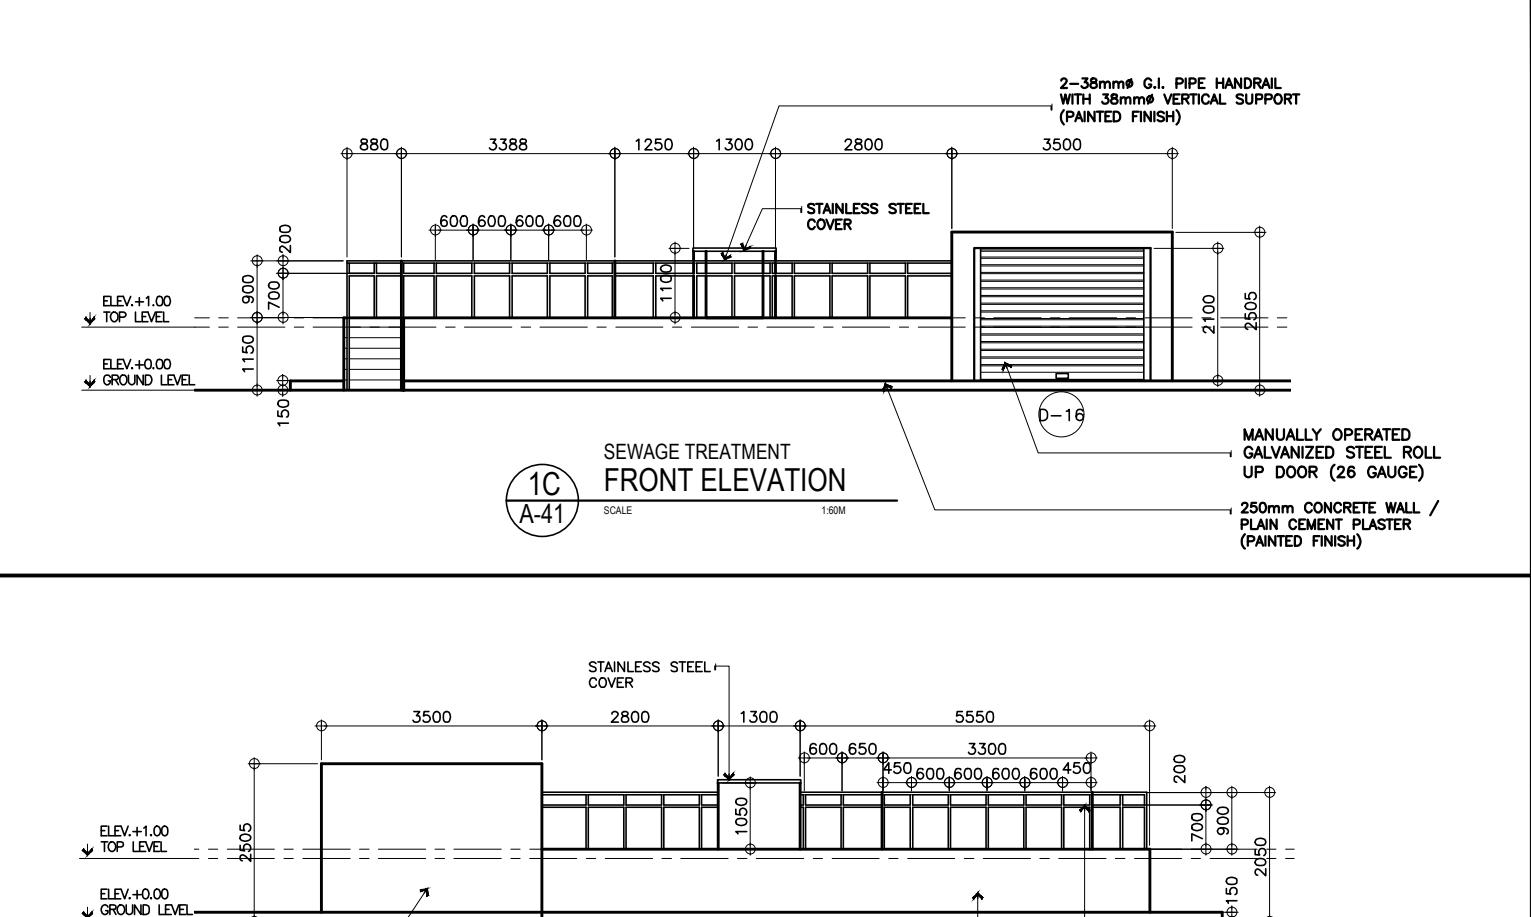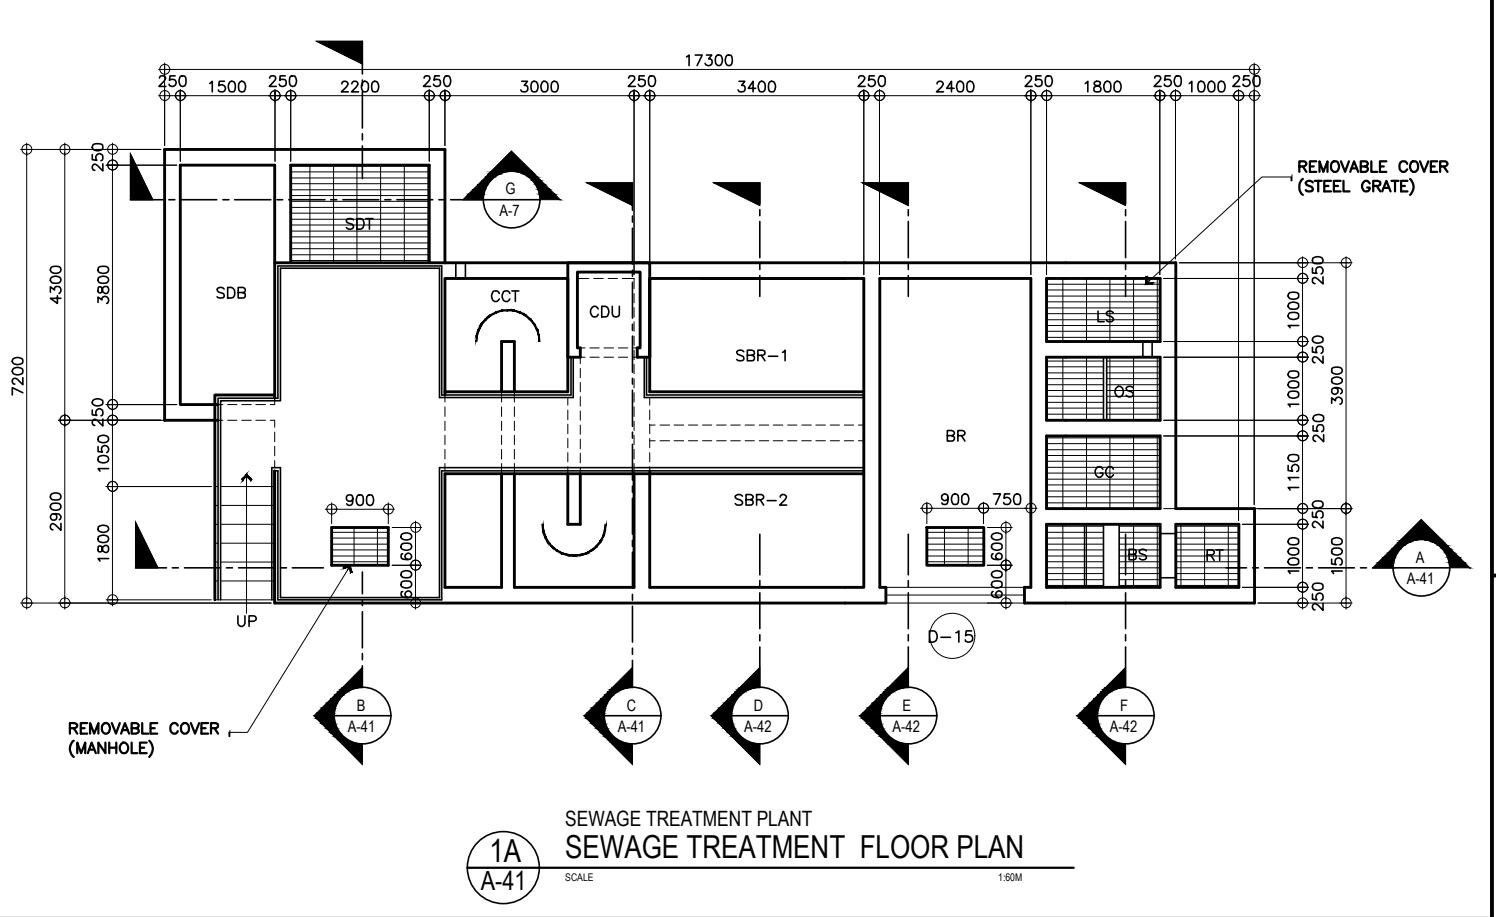



UNITED TECHNOLOGIES CONSOLIDATED PARTNERSHIP		PREPARED BY:	SUBMITTED BY:	REPUBLIC OF THE PHILIPPINES DEPARTMENT OF PUBLIC WORKS AND HIGHWAYS BUREAU OF DESIGN BUILDINGS DIVISION BONIFACIO DRIVE PORT AREA, MANILA	REVIEWED AS TO DESIGN CONCEPT:	RECOMMENDING APPROVAL:	APPROVED:	CONCURRED:	PROJECT & LOCATION / BARANGAY:	SHEET CONTENTS:	SET NO.	SHEET NO.
ARMAN U. CUEVAS ARCHITECTURAL DESIGN POSITION: ARCHITECT PRC No.: 0018676 TIN No.: 907-359-364 PTR No.: 4020896	CYNTHIA CLEMEN A. YU ARCHITECT/TEAM LEADER	(SEE COVER SHEET) JOSEPHINE P. ISTURIS CHIEF, BUILDINGS DIVISION, BOD	(SEE COVER SHEET) LEA N. DELFINADO, CESO IV OFFICER-IN-CHARGE	(SEE COVER SHEET) EMIL K. SADAIN, CESO I UNDERSECRETARY FOR UPMO OPERATIONS & TECHNICAL SERVICES	(SEE COVER SHEET) ROWENA CANDICE M. RUIZ EXECUTIVE DIRECTOR	PROPOSED: PROPOSED SEVEN (7) STOREY GOVERNMENT PROCUREMENT POLICY BOARD (GPPB) UP DILIMAN COMPOUND, DILIMAN, QUEZON CITY	SEWAGE TREATMENT PLANT DETAILS	BOD A-41	43 216			

1 A-41 SEWAGE TREATMENT PLANT DETAILS

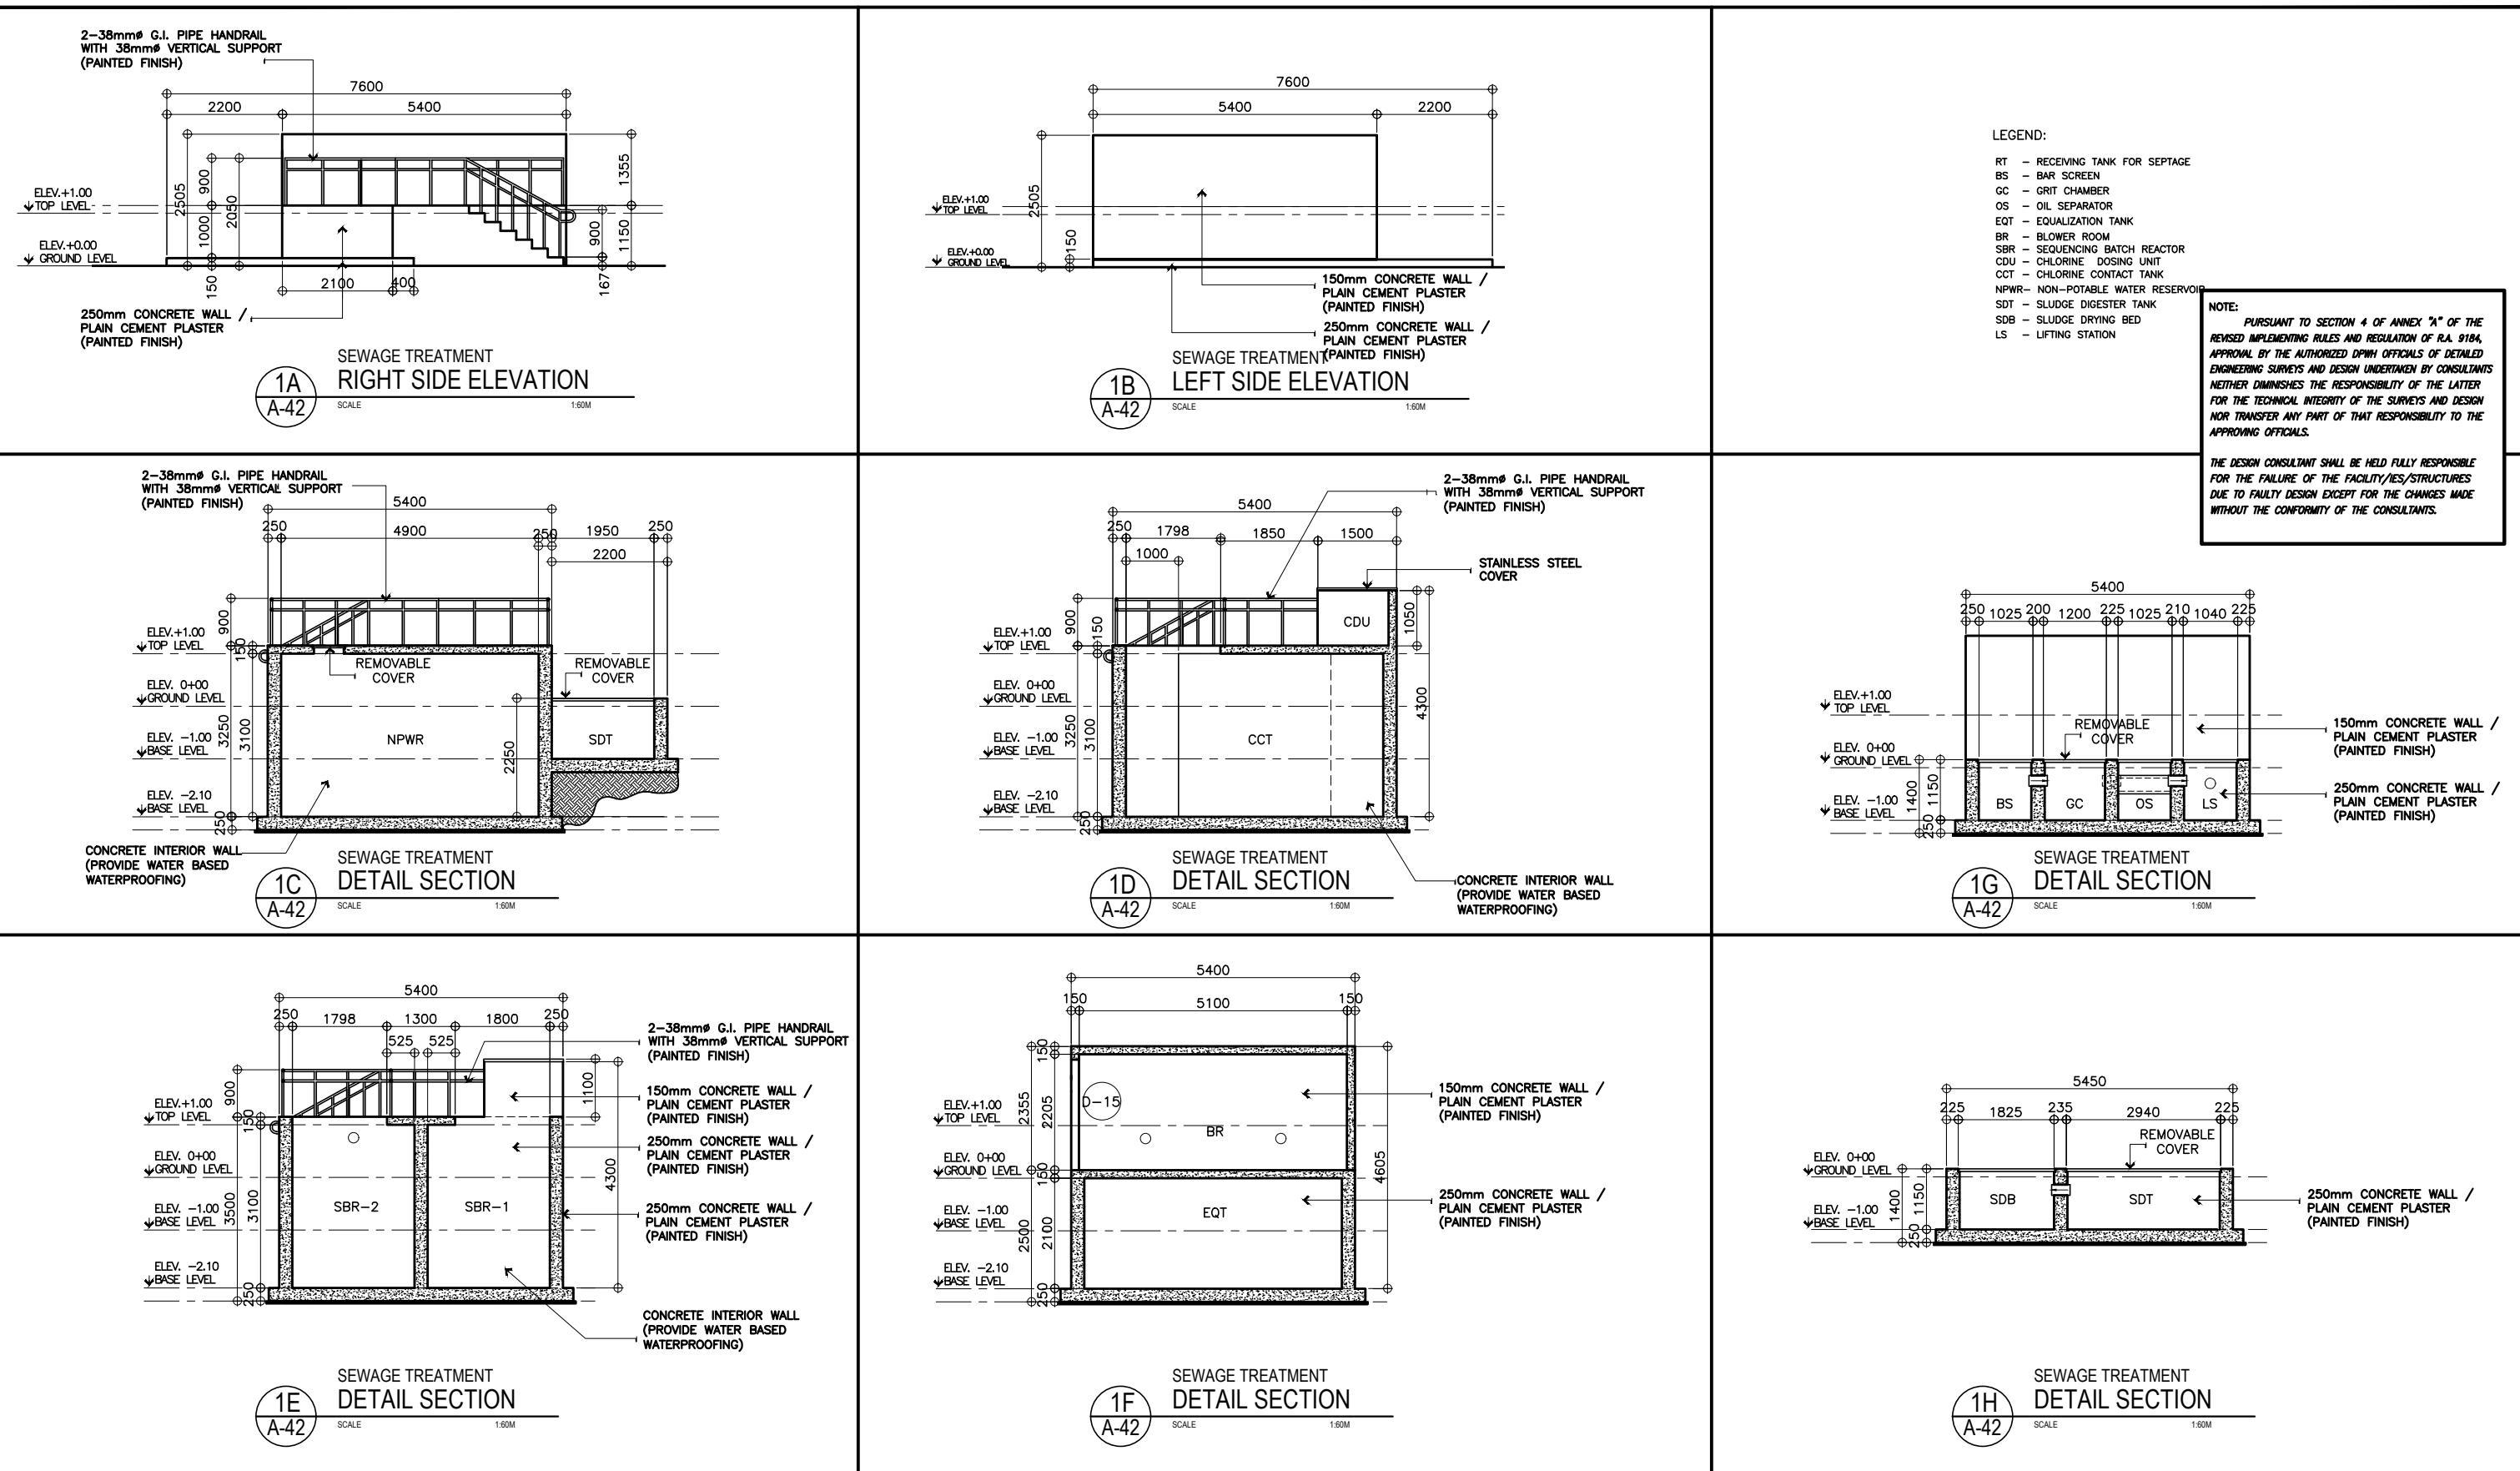

1 SEWAGE TREATMENT PLANT DETAILS

PREPARED BY:	SUBMITTED BY:	REVIEWED AS TO DESIGN CONCEPT:	RECOMMENDING APPROVAL:	APPROVED:	CONCURRED:	PROJECT & LOCATION / BARANGAY:	HEET CONTENTS:	SET NO.	SHEET NO.
ARMAN U. CUEVAS ARCHITECTURAL DESIGN POSITION: ARCHITECT PRC No.: 0018676 TIN No.: 907-359-364 PTR No.: 4020896	CYNTHIA CLEMEN A. YU ARCHITECT/TEAM LEADER	JOSEPHINE P. ISTURIS CHIEF, BUILDINGS DIVISION, BOD	(SEE COVER SHEET) LEA N. DELFINADO, CESO IV OFFICER-IN-CHARGE	(SEE COVER SHEET) EMIL K. SADAIN, CESO I UNDERSECRETARY FOR UPMO OPERATIONS & TECHNICAL SERVICES	(SEE COVER SHEET) ROWENA CANDICE M. RUIZ EXECUTIVE DIRECTOR	PROPOSED SEVEN (7) STOREY GOVERNMENT PROCUREMENT POLICY BOARD (GPPB) UP DILIMAN COMPOUND, DILIMAN, QUEZON CITY	SEWAGE TREATMENT PLANT DETAILS	BOD A-42	44 216






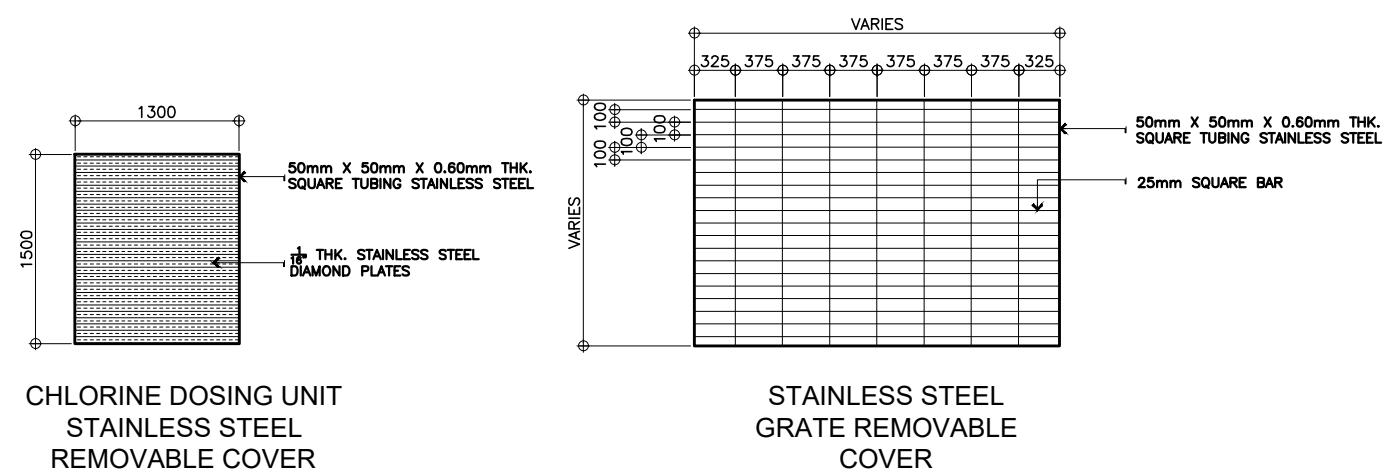
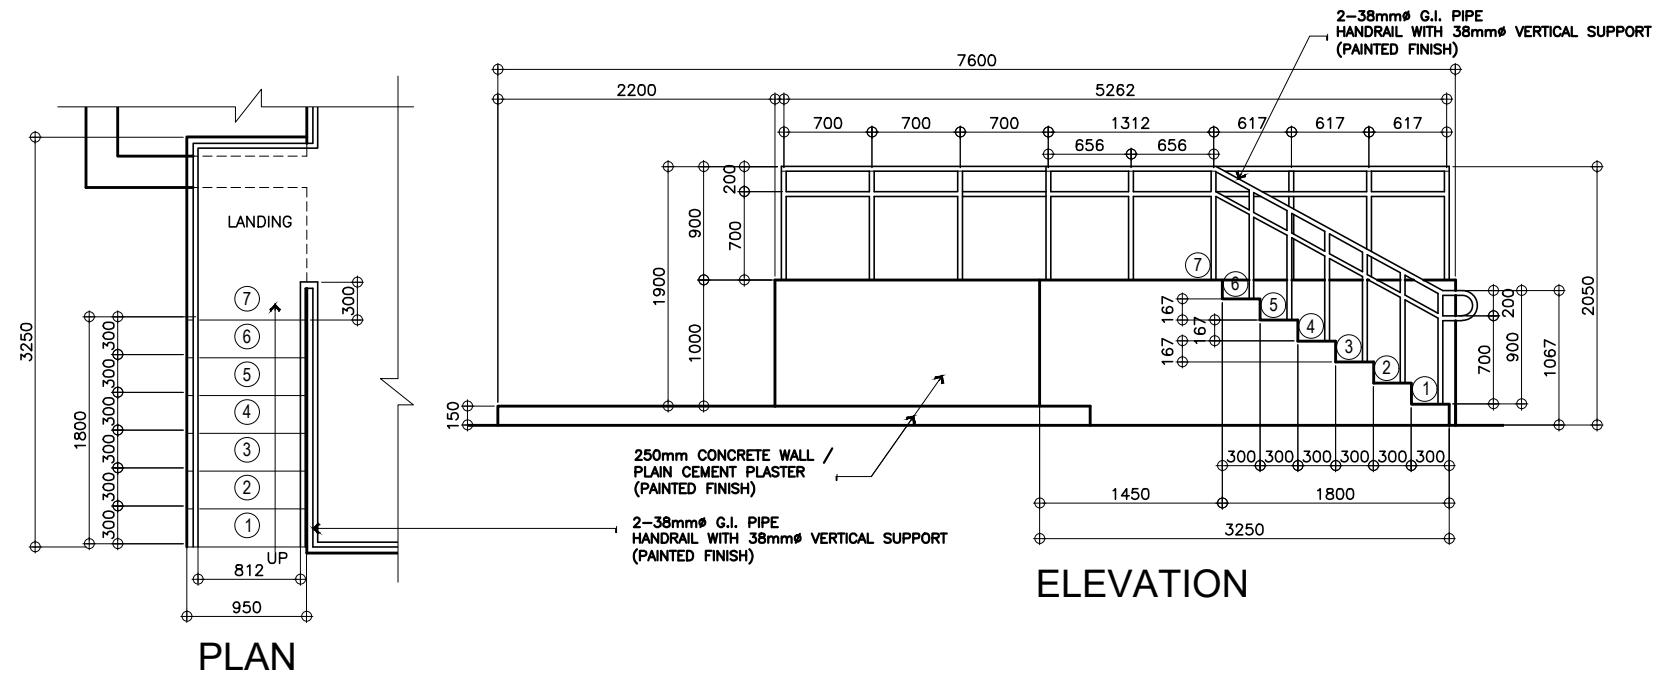


SEWAGE TREATMENT
REMOVABLE COVER

NOTE:
PURSUANT TO SECTION 4 OF ANNEX "A" OF THE
REVISED IMPLEMENTING RULES AND REGULATION OF RA. 9186,
APPROVAL BY THE AUTHORIZED DPWH OFFICIALS OF DETAILED
ENGINEERING SURVEYS AND DESIGN UNDERTAKEN BY CONSULTANTS
NEITHER DIMINISHES THE RESPONSIBILITY OF THE LATTER
FOR THE TECHNICAL INTEGRITY OF THE SURVEYS AND DESIGN
NOR TRANSFER ANY PART OF THAT RESPONSIBILITY TO THE
APPROVING OFFICIALS.

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UNITED TECHNOLOGIES CONSOLIDATED PARTNERSHIP	PREPARED BY:	SUBMITTED BY:	 REPUBLIC OF THE PHILIPPINES DEPARTMENT OF PUBLIC WORKS AND HIGHWAYS BUREAU OF DESIGN BUILDINGS DIVISION BONIFACIO DRIVE PORT AREA, MANILA	REVIEWED AS TO DESIGN CONCEPT:	RECOMMENDING APPROVAL:	APPROVED:	CONCURRED:	PROJECT & LOCATION / BARANGAY:	SHEET CONTENTS:	SET NO.	SHEET NO.
	ARMAN U. CUEVAS ARCHITECTURAL DESIGN LEADER / ARCHITECT CT PRC No.: 0018676 PTB No.: 4020896	CYNTHIA CLEMEN A. YU ARCHITECT/TEAM LEADER TIN No.: 907-359-364		JOSEPHINE P. ISTURIS CHIEF BUILDINGS DIVISION, BOD	(SEE COVER SHEET) LEA N. DELFINADO, CESO IV	(SEE COVER SHEET) EMIL K. SADAIN, CESO I	(SEE COVER SHEET) ROWENA CANDICE M. RUIZ	PROPOSED: PROPOSED SEVEN (7) STOREY GOVERNMENT PROCUREMENT POLICY BOARD (GPPB) UP DILIMAN COMPOUND, DILIMAN, QUEZON CITY	SEWAGE TREATMENT DETAIL OF STAIR AND REMOVABLE COVER	 BOD A-43	 45 216

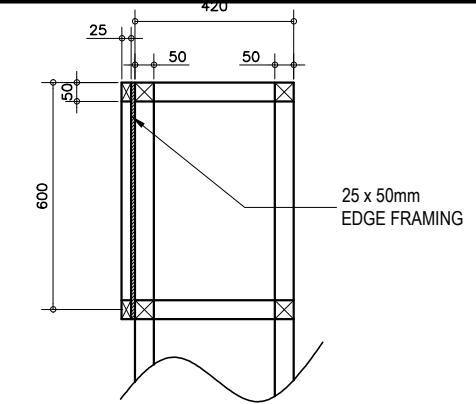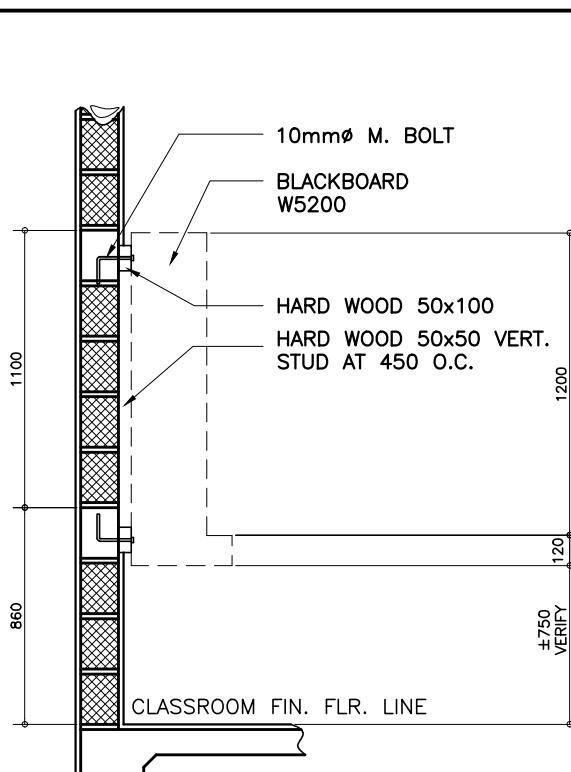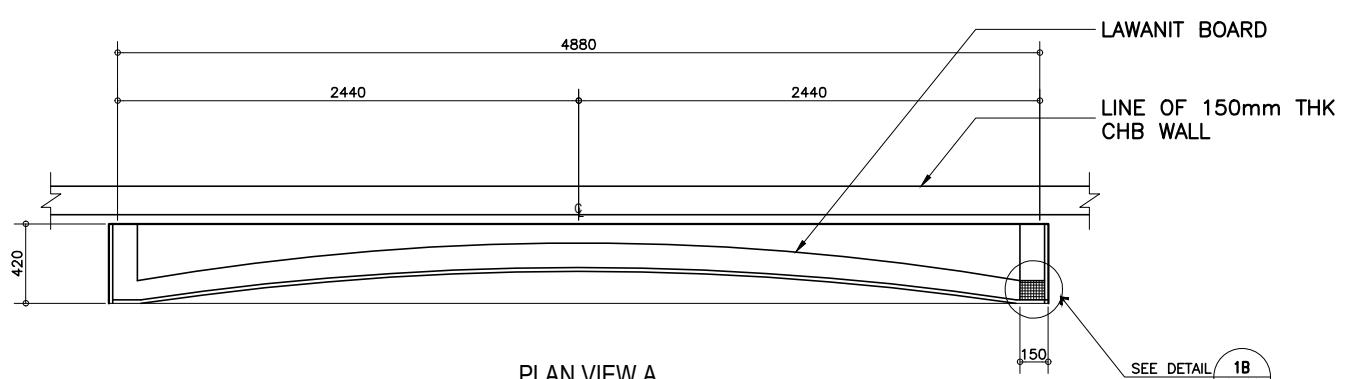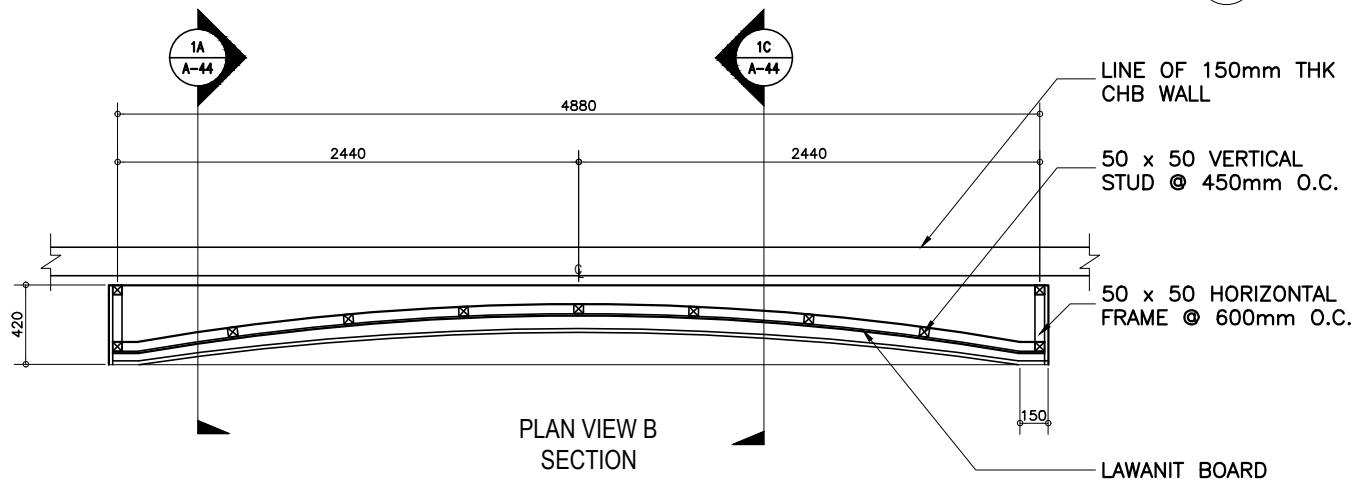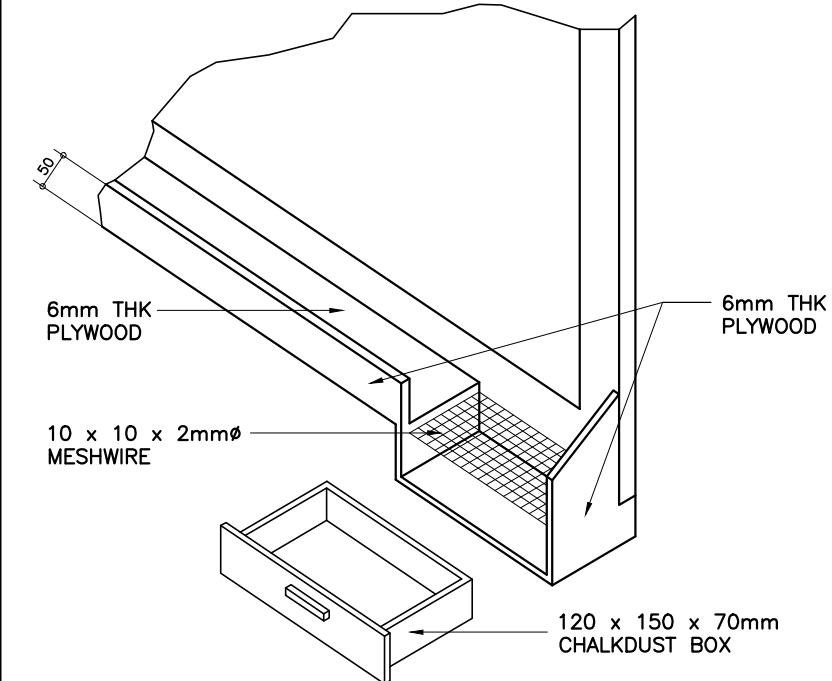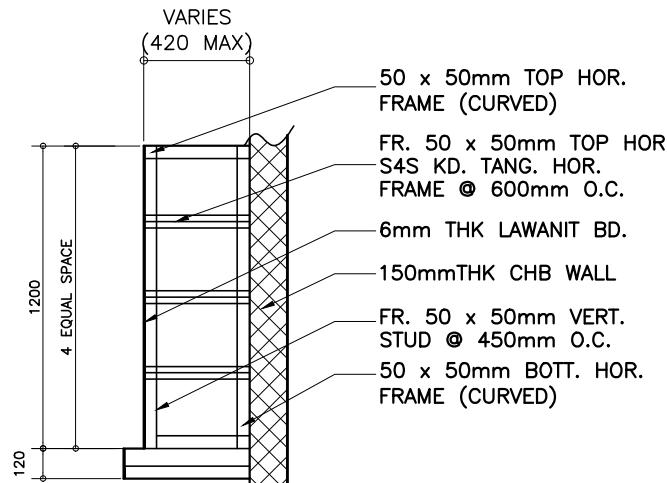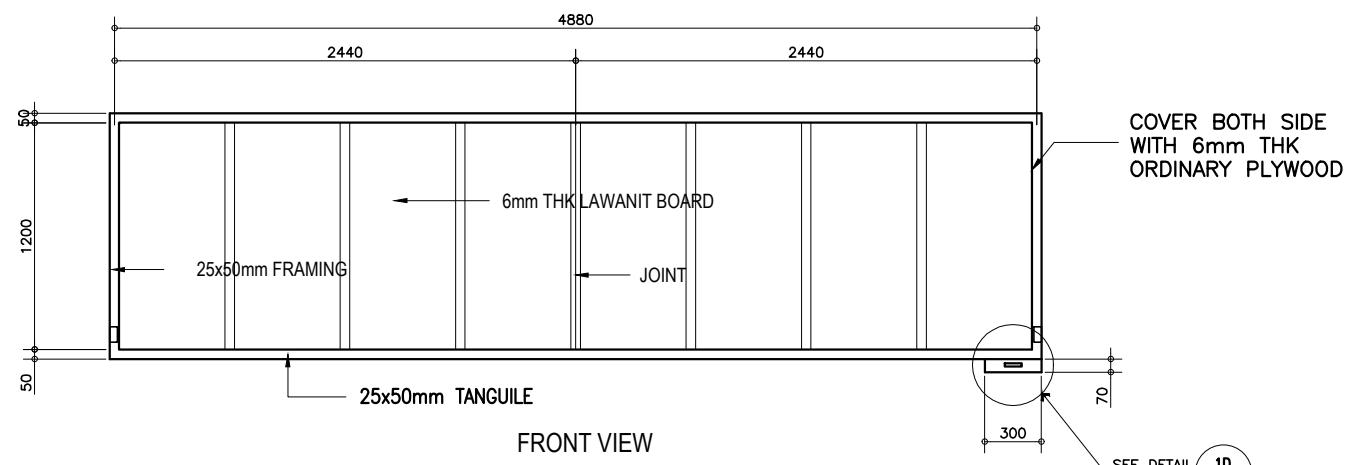

SPECIFICATION:


-25 x 300mm SOLID TANGUE OR EQUIVALENT WOOD FRAMES
-6mm THK. PLYWOOD

PROVIDE: -70 x 120 x 150mm CHALKDUST BOX
-2φ x 10 x 10mm MESHWIRE

FINISH: -FRAMING AND CHALKBOX PAINT WITH QUICK DRYING ENAMEL PAINT (BROWN -BOARD PAINT WITH BLACKBOARD PAINT (GREEN) OR BLACKBOARD SLATE



1 BLACKBOARD DETAIL
A-44 SCALE 1:20M

2 CONNECTION DETAIL SECTION
A-44 SCALE 1:15M

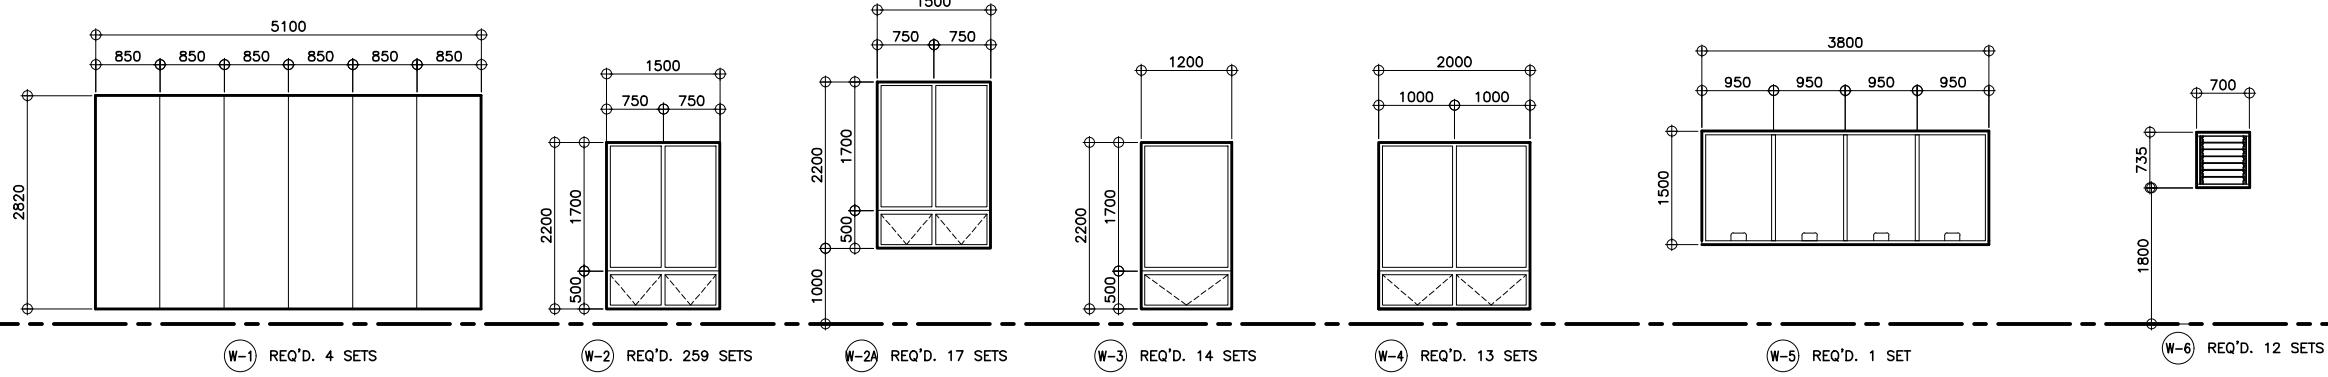

NOTE: PURSUANT TO SECTION 4 OF ANNEX "A" OF THE REVISED IMPLEMENTING RULES AND REGULATION OF RA 9184, APPROVAL BY THE AUTHORIZED DPWH OFFICIALS OF DETAILED ENGINEERING SURVEYS AND DESIGN UNDERTAKEN BY CONSULTANTS NEITHER DIMINISHES THE RESPONSIBILITY OF THE LATTER FOR THE TECHNICAL INTEGRITY OF THE SURVEYS AND DESIGN NOR TRANSFER ANY PART OF THAT RESPONSIBILITY TO THE APPROVING OFFICIALS.

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SCHEDULE OF FINISHES

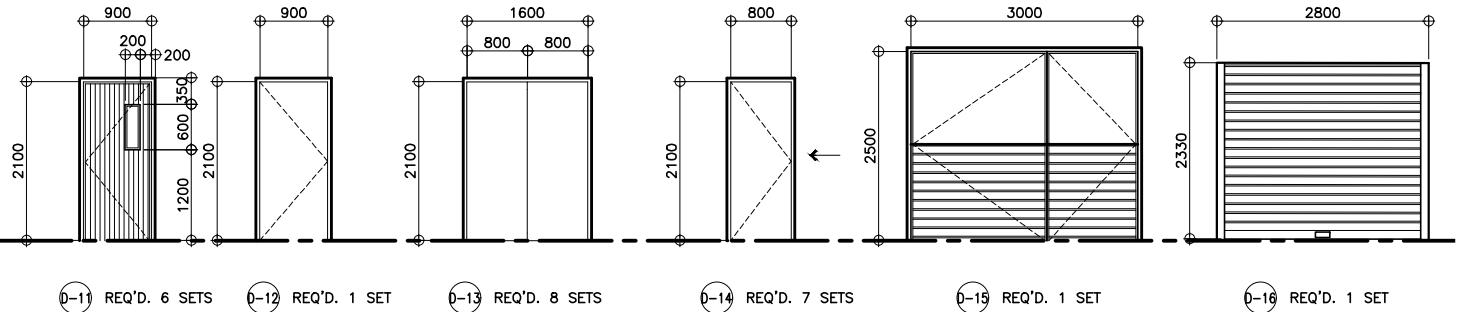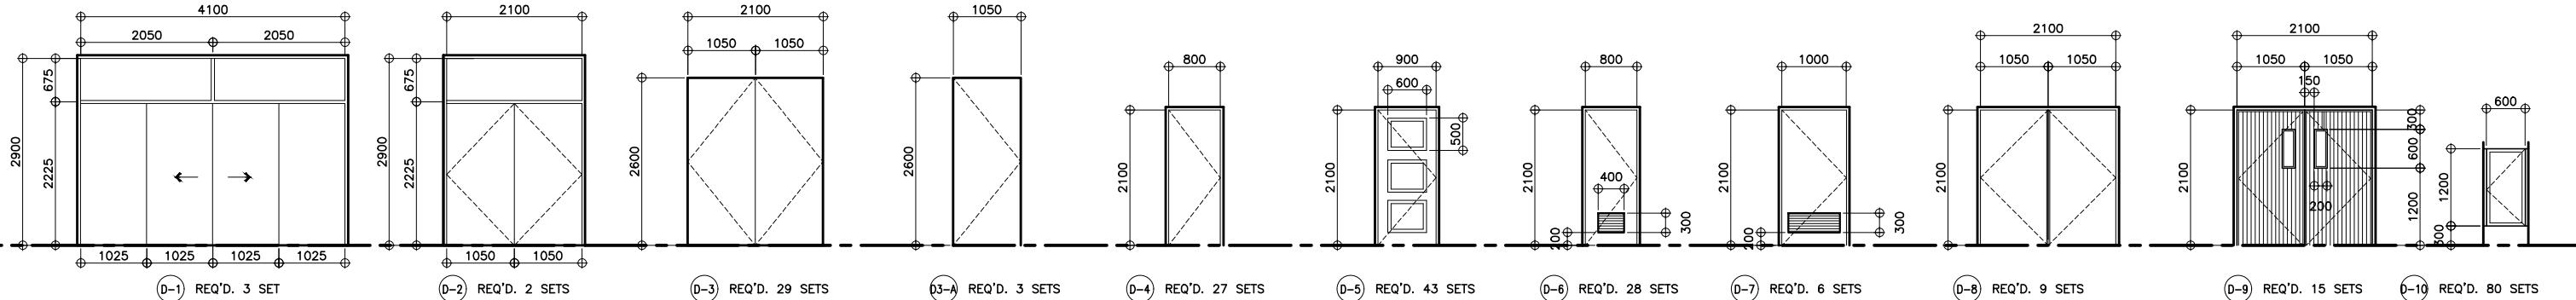DOORS	DOOR No.	PANEL MATERIAL	FRAME	FINISH	TYPE	No. OF PANEL/BLADES	WINDOW SIZE	DOOR SIZE	
								W	H
	D-1	12mm THK. TEMPERED GLASS DOOR W/ HARDWARE AND ACCESSORIES	ALUMINUM	CLEAR	AUTOMATED SLIDING	2	4100 2900		
	D-2	12mm THK. TEMPERED GLASS DOOR W/ HARDWARE AND ACCESSORIES	ALUMINUM	CLEAR	SWING	2	2100 2600		
	D-3	12mm THK. TEMPERED GLASS DOOR W/ HARDWARE AND ACCESSORIES	FRAMELESS	POWDER COATED	SWING	2	2100 2600		
	D3-A	12mm THK. TEMPERED GLASS DOOR W/ HARDWARE AND ACCESSORIES	FRAMELESS	POWDER COATED	SWING	1	2100 2600		
	D-4	SOLID WOOD PANEL DOOR W/ HARDWARE AND ACCESSORIES	MAHOGANY	SEMI-GLOSS WOOD VARNISH	SWING	1	800 2100		
	D-5	SOLID WOOD PANEL DOOR W/ HARDWARE AND ACCESSORIES	MAHOGANY	SEMI-GLOSS WOOD VARNISH	SWING	1	900 2100		
	D-6	SOLID WOOD PANEL DOOR W/ HARDWARE AND ACCESSORIES	MAHOGANY	SEMI-GLOSS WOOD VARNISH	SWING	1	800 2100		
	D-7	SOLID WOOD PANEL DOOR W/ HARDWARE AND ACCESSORIES	MAHOGANY	SEMI-GLOSS WOOD VARNISH	SWING	1	900 2100		
	D-8	SOLID WOOD PANEL DOOR W/ HARDWARE AND ACCESSORIES	MAHOGANY	SEMI-GLOSS WOOD VARNISH	SWING	2	2100 2100		
	D-9	FIRE-RATED STEEL DOOR WITH GLASS VIEWING PANEL	METAL	PAINT	SWING	2	2100 2600		
	D-10	PHENOLIC DOOR w/ HARDWARE ACCESSORIES AND DOOR BOLT	MAHOGANY	SEMI-GLOSS WOOD VARNISH	SWING	1	600 1200		
	D-11	FIRE-RATED STEEL DOOR	METAL	PAINT	SWING	1	900 2100		
	D-12	STEEL DOOR W/ HARDWARE AND ACCESSORIES	METAL	PAINT	SWING	1	800 2100		
	D-13	GLASS DOOR W/ HARDWARE AND ACCESSORIES	ALUMINUM	POWDER COATED	SLIDING	2	800 1650		
	D-14	STEEL DOOR W/ HARDWARE AND ACCESSORIES	ALUMINUM	PAINT	SWING	1	600 2100		
	D-15	3.2 MM THICK STEEL DOOR	METAL	PAINT	SWING	2	3000 2500		
	D-16	MANUALLY OPERATED GALVANIZED STEEL (GAUGE 26)	METAL	PAINT	ROLL UP	1	2800 2330		

SCHEDULE OF DOORS AND WINDOWS

1
A-45

SCALE

1:50M

	PREPARED BY: ARMAN U. CUEVAS	SUBMITTED BY: CYNTHIA CLEMEN A. YU		REVIEWED AS TO DESIGN CONCEPT: JOSEPHINE P. ISTURIS	RECOMMENDING APPROVAL: (SEE COVER SHEET) LEA N. DELFINADO, CESO IV	APPROVED: (SEE COVER SHEET) EMIL K. SADAIN, CESO I	CONCURRED: (SEE COVER SHEET) ROWENA CANDICE M. RUIZ	PROJECT & LOCATION / BARANGAY:	SHEET CONTENTS:	SET NO.	SHEET NO.
								BUREAU OF DESIGN BUILDINGS DIVISION BONIFACIO DRIVE PORT AREA, MANILA	PROPOSED: PROPOSED SEVEN (7) STOREY GOVERNMENT PROCUREMENT POLICY BOARD (GPPB) UP DILIMAN COMPOUND, DILIMAN, QUEZON CITY	SCHEDULE OF DOORS AND WINDOWS	BOD A-45

SCHEDULE OF FINISHES

ROOM NAME	FLOOR	BASE			WALL ABOVE BASE	CEILING			REMARKS
		MAT'L	TYPE	HT (MM)		MAT'L	TYPE	HT (MM)	
LOBBY	900 X 900mm POLISHED SYNTHETIC GRANITE TILE FLOOR FINISH ((SUBMIT SAMPLE FOR APPROVAL))	WOOD	-	100	PLAIN CEMENT PLASTER PAINTED FINISH / WOOD DECORATIVE WALL PANEL / 12mm TEMPERED,LAMINATED INSULATED GLASS	4.5mm THICK FIBER CEMENT BOARD (PAINTED) ON METAL FURRING CHANNELS @ 400mm O.C.	SUSPENDED	4000	TOP OF GRANITE TILES @ 3.00m HIGH FROM FLOOR FINISH LEVEL
RECEIVING / RELEASING ROOM	600 X 600mm CERAMIC TILE FLOOR FINISH ((SUBMIT SAMPLE FOR APPROVAL))	WOOD	-	100	PLAIN CEMENT PLASTER PAINTED FINISH	EXPOSED UNDERSIDE OF CONCRETE SLAB (PAINTED)	SUSPENDED	3100	TOP OF CERAMIC TILES @ 3.00m HIGH FROM FLOOR FINISH LEVEL
SECURITY ROOM	600 X 600mm CERAMIC TILE FLOOR FINISH ((SUBMIT SAMPLE FOR APPROVAL))	WOOD	-	100	PLAIN CEMENT PLASTER PAINTED FINISH	4.5mm THICK FIBER CEMENT BOARD (PAINTED) ON METAL FURRING CHANNELS @ 400mm O.C.	SUSPENDED	3000	TOP OF CERAMIC TILES @ 3.00m HIGH FROM FLOOR FINISH LEVEL
DAYCARE ROOM	600 X 600mm CERAMIC TILE FLOOR FINISH ((SUBMIT SAMPLE FOR APPROVAL))	WOOD	-	100	PLAIN CEMENT PLASTER PAINTED FINISH	4.5mm THICK FIBER CEMENT BOARD (PAINTED) ON METAL FURRING CHANNELS @ 400mm O.C.	SUSPENDED	3000	TOP OF CERAMIC TILES @ 3.00m HIGH FROM FLOOR FINISH LEVEL
RECORDS ROOM	600 X 600mm CERAMIC TILE FLOOR FINISH ((SUBMIT SAMPLE FOR APPROVAL))	WOOD	-	100	PLAIN CEMENT PLASTER PAINTED FINISH	4.5mm THICK FIBER CEMENT BOARD (PAINTED) ON METAL FURRING CHANNELS @ 400mm O.C.	SUSPENDED	3000	TOP OF CERAMIC TILES @ 3.00m HIGH FROM FLOOR FINISH LEVEL
MULTI-PURPOSE AREA	900 X 900mm POLISHED SYNTHETIC GRANITE TILE FLOOR FINISH ((SUBMIT SAMPLE FOR APPROVAL))	WOOD	-	100	PLAIN CEMENT PLASTER PAINTED FINISH	4.5mm THICK FIBER CEMENT BOARD (PAINTED) ON METAL FURRING CHANNELS @ 400mm O.C.	SUSPENDED	3000	TOP OF GRANITE TILES @ 3.00m HIGH FROM FLOOR FINISH LEVEL
CANTEEN AREA	900 X 900mm POLISHED SYNTHETIC GRANITE TILE FLOOR FINISH ((SUBMIT SAMPLE FOR APPROVAL))	WOOD	-	100	PLAIN CEMENT PLASTER PAINTED FINISH	4.5mm THICK FIBER CEMENT BOARD (PAINTED) ON METAL FURRING CHANNELS @ 400mm O.C.	SUSPENDED	3000	TOP OF CERAMIC TILES @ 4.00m HIGH FROM FLOOR FINISH LEVEL
STAIR CASE	600 X 600mm CERAMIC TILE FLOOR FINISH ((SUBMIT SAMPLE FOR APPROVAL))	-	-	100	PLAIN CEMENT PLASTER PAINTED FINISH	EXPOSED UNDERSIDE OF CONCRETE SLAB (PAINTED)			
DRIVERS LOUNGE	PLAIN CEMENT FLOOR FINISH (PROVIDE FLOOR HARDENER)	-	-	-	PLAIN CEMENT PLASTER PAINTED FINISH	4.5mm THICK FIBER CEMENT BOARD (PAINTED) ON METAL FURRING CHANNELS @ 400mm O.C.	SUSPENDED	3000	TOP OF PLAIN CEMENT @ 4.00m HIGH FROM FLOOR FINISH LEVEL
GUARD POST	PLAIN CEMENT FLOOR FINISH (PROVIDE FLOOR HARDENER)	-	-	100	PLAIN CEMENT PLASTER PAINTED FINISH	4.5mm THICK FIBER CEMENT BOARD (PAINTED) ON METAL FURRING CHANNELS @ 400mm O.C.	SUSPENDED	3000	TOP OF CERAMIC TILES @ 4.00m HIGH FROM FLOOR FINISH LEVEL
TOILET (HE AND SHE)	600 X 600mm UNGLAZED VITRIFIED CERAMIC TILE FLOOR FINISH (SIZE & COLOR BY END-USER'S APPROVAL)	-	-	100	600 X 600mm GLAZED CERAMIC TILE FINISH (SIZE & COLOR BY END-USER'S APPROVAL)	4.5mm THICK FIBER CEMENT BOARD (PAINTED) ON METAL FURRING CHANNELS @ 400mm O.C.	SUSPENDED	3000	TOP OF CERAMIC TILES @ 3.00m HIGH FROM FLOOR FINISH LEVEL
PASSAGE FRONT	600 X 600mm TEXTURED CERAMIC TILE (NON-SKID) FLOOR FINISH-OUTDOOR TYPE ((SUBMIT SAMPLE FOR APPROVAL))	-	-	-	PLAIN CEMENT PLASTER PAINTED FINISH	4.5mm THICK FIBER CEMENT BOARD (PAINTED) ON METAL FURRING CHANNELS @ 400mm O.C.	SUSPENDED	4000	TOP OF CERAMIC TILES @ 4.00m HIGH FROM FLOOR FINISH LEVEL
PASSAGE REAR	600 X 600mm TEXTURED CERAMIC TILE (NON-SKID) FLOOR FINISH-OUTDOOR TYPE ((SUBMIT SAMPLE FOR APPROVAL))	-	-	-	PLAIN CEMENT PLASTER PAINTED FINISH	4.5mm THICK FIBER CEMENT BOARD (PAINTED) ON METAL FURRING CHANNELS @ 400mm O.C.	SUSPENDED	4000	TOP OF CERAMIC TILES @ 4.00m HIGH FROM FLOOR FINISH LEVEL
STO	PLAIN CEMENT FLOOR FINISH (PROVIDE FLOOR HARDENER)	-	-	100	PLAIN CEMENT PLASTER PAINTED FINISH	EXPOSED UNDERSIDE OF CONCRETE SLAB (PAINTED)			

SCHEDULE OF FINISHES

ROOM NAME	FLOOR	BASE			WALL ABOVE BASE	CEILING			REMARKS
		MAT'L	TYPE	HT (MM)		MAT'L	TYPE	HT (MM)	
PLANNING & INTERNAL AUDIT	600 X 600mm CERAMIC TILE FLOOR FINISH ((SUBMIT SAMPLE FOR APPROVAL))	WOOD	-	100	PLAIN CEMENT PLASTER PAINTED FINISH / 12mm TEMPERED,LAMINATED INSULATED GLASS	4.5mm THICK FIBER CEMENT BOARD (PAINTED) ON METAL FURRING CHANNELS @ 400mm O.C.	SUSPENDED	3000	TOP OF CERAMIC TILES @ 3.00m HIGH FROM FLOOR FINISH LEVEL
HALL WAY	900 X 900mm POLISHED SYNTHETIC GRANITE TILE FLOOR FINISH ((SUBMIT SAMPLE FOR APPROVAL))	WOOD	-	100	PLAIN CEMENT PLASTER PAINTED FINISH / DRYWALL PAINTED FINISH 12mm TEMPERED,LAMINATED INSULATED GLASS	4.5mm THICK FIBER CEMENT BOARD (PAINTED) ON METAL FURRING CHANNELS @ 400mm O.C.	SUSPENDED	3000	TOP OF GRANITE TILES @ 3.00m HIGH FROM FLOOR FINISH LEVEL
LOBBY	900 X 900mm POLISHED SYNTHETIC GRANITE TILE FLOOR FINISH ((SUBMIT SAMPLE FOR APPROVAL))	WOOD	-	100	PLAIN CEMENT PAINTED FINISH / DRYWALL PAINTED FINISH 12mm TEMPERED,LAMINATED INSULATED GLASS	4.5mm THICK FIBER CEMENT BOARD (PAINTED) ON METAL FURRING CHANNELS @ 400mm O.C.	SUSPENDED	3000	TOP OF GRANITE TILES @ 3.00m HIGH FROM FLOOR FINISH LEVEL
MEETING ROOMS	600 X 600mm CERAMIC TILE FLOOR FINISH ((SUBMIT SAMPLE FOR APPROVAL))	WOOD	-	100	DRYWALL PAINTED FINISH / 12mm TEMPERED,LAMINATED INSULATED GLASS	4.5mm THICK FIBER CEMENT BOARD (PAINTED) ON METAL FURRING CHANNELS @ 400mm O.C.	SUSPENDED	3000	TOP OF GRANITE TILES @ 3.00m HIGH FROM FLOOR FINISH LEVEL
RECORDS ROOM	600 X 600mm CERAMIC TILE FLOOR FINISH ((SUBMIT SAMPLE FOR APPROVAL))	WOOD	-	100	PLAIN CEMENT PLASTER PAINTED FINISH / 12mm TEMPERED,LAMINATED INSULATED GLASS	4.5mm THICK FIBER CEMENT BOARD (PAINTED) ON METAL FURRING CHANNELS @ 400mm O.C.	SUSPENDED	3000	TOP OF GRANITE TILES @ 3.00m HIGH FROM FLOOR FINISH LEVEL
ADMINISTRATIVE DIVISION	900 X 900mm POLISHED SYNTHETIC GRANITE TILE FLOOR FINISH ((SUBMIT SAMPLE FOR APPROVAL))	WOOD	-	100	PLAIN CEMENT PLASTER PAINTED FINISH / DRYWALL PAINTED FINISH 12mm TEMPERED,LAMINATED INSULATED GLASS	4.5mm THICK FIBER CEMENT BOARD (PAINTED) ON METAL FURRING CHANNELS @ 400mm O.C.	SUSPENDED	3000	TOP OF GRANITE TILES @ 3.00m HIGH FROM FLOOR FINISH LEVEL
DIVISION CHIEF	900 X 900mm POLISHED SYNTHETIC GRANITE TILE FLOOR FINISH ((SUBMIT SAMPLE FOR APPROVAL))	WOOD	-	100	DRYWALL PAINTED FINISH / 12mm TEMPERED,LAMINATED INSULATED GLASS	4.5mm THICK FIBER CEMENT BOARD (PAINTED) ON METAL FURRING CHANNELS @ 400mm O.C.	SUSPENDED	3000	TOP OF GRANITE TILES @ 3.00m HIGH FROM FLOOR FINISH LEVEL
STAIR CASE	600 X 600mm CERAMIC TILE FLOOR FINISH ((SUBMIT SAMPLE FOR APPROVAL))	-	-	100	PLAIN CEMENT PLASTER PAINTED FINISH	EXPOSED UNDERSIDE OF CONCRETE SLAB (PAINTED)			
SUPPLY ROOM	PLAIN CEMENT FLOOR FINISH (PROVIDE FLOOR HARDENER)	-	-	-	PLAIN CEMENT PLASTER PAINTED FINISH	4.5mm THICK FIBER CEMENT BOARD (PAINTED) ON METAL FURRING CHANNELS @ 400mm O.C.	SUSPENDED	3000	TOP OF GRANITE TILES @ 3.00m HIGH FROM FLOOR FINISH LEVEL
UTILITY ROOM	PLAIN CEMENT FLOOR FINISH (PROVIDE FLOOR HARDENER)	-	-	100	PLAIN CEMENT PLASTER PAINTED FINISH	4.5mm THICK FIBER CEMENT BOARD (PAINTED) ON METAL FURRING CHANNELS @ 400mm O.C.	SUSPENDED	3000	TOP OF GRANITE TILES @ 3.00m HIGH FROM FLOOR FINISH LEVEL
STORAGE	PLAIN CEMENT FLOOR FINISH (PROVIDE FLOOR HARDENER)	-	-	100	PLAIN CEMENT PLASTER PAINTED FINISH	EXPOSED UNDERSIDE OF CONCRETE SLAB (PAINTED)			TOP OF GRANITE TILES @ 3.00m HIGH FROM FLOOR FINISH LEVEL
TOILET (HE AND SHE)	600 X 600mm UNGLAZED VITRIFIED CERAMIC TILE FLOOR FINISH (SIZE & COLOR BY END-USER'S APPROVAL)	-	-	-	600 X 600mm GLAZED CERAMIC TILE FINISH (SIZE & COLOR BY END-USER'S APPROVAL)	4.5mm THICK FIBER CEMENT BOARD (PAINTED) ON METAL FURRING CHANNELS @ 400mm O.C.	SUSPENDED	3000	TOP OF GRANITE TILES @ 3.00m HIGH FROM FLOOR FINISH LEVEL
PANTRY	600 X 600mm CERAMIC TILE FLOOR FINISH ((SUBMIT SAMPLE FOR APPROVAL))	-	-	100	PLAIN CEMENT PLASTER PAINTED FINISH	4.5mm THICK FIBER CEMENT BOARD (PAINTED) ON METAL FURRING CHANNELS @ 400mm O.C.	SUSPENDED	3000	TOP OF GRANITE TILES @ 3.00m HIGH FROM FLOOR FINISH LEVEL

SCHEDULE OF FLOOR, WALL AND CEILING FINISHES

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PREPARED BY:	SUBMITTED BY:			REVIEWED AS TO DESIGN CONCEPT:	RECOMMENDING APPROVAL:	APPROVED:	CONCURRED:	PROJECT & LOCATION / BARANGAY:	SHEET CONTENTS:	SET NO.	SHEET NO.	
					(SEE COVER SHEET)	(SEE COVER SHEET)	(SEE COVER SHEET)			PROPOSED:		
ARMAN U. CUEVAS	CYNTHIA CLEMEN A. YU			JOSEPHINE P. ISTURIS	LEA N. DELFINADO, CESO IV	EMIL K. SADAIN, CESO I	ROWENA CANDICE M. RUIZ			PROPOSED SEVEN (7) STOREY GOVERNMENT PROCUREMENT POLICY BOARD (GPPB) UP DILIMAN COMPOUND, DILIMAN, QUEZON CITY	SCHEDULE OF FLOOR, WALL AND CEILING FINISHES	216
UNITED TECHNOLOGIES CONSOLIDATED PARTNERSHIP	ARMAN U. CUEVAS	CYNTHIA CLEMEN A. YU		JOSEPHINE P. ISTURIS	LEA N. DELFINADO, CESO IV	EMIL K. SADAIN, CESO I	ROWENA CANDICE M. RUIZ			PROPOSED SEVEN (7) STOREY GOVERNMENT PROCUREMENT POLICY BOARD (GPPB) UP DILIMAN COMPOUND, DILIMAN, QUEZON CITY	SCHEDULE OF FLOOR, WALL AND CEILING FINISHES	216

SCHEDULE OF FINISHES

THIRD FLOOR	ROOM NAME	FLOOR	BASE			WALL ABOVE BASE	CEILING			REMARKS
			MAT'L	TYPE	HT (MM)		MAT'L	TYPE	HT (MM)	
	LOBBY	900 X 900mm POLISHED SYNTHETIC GRANITE TILE FLOOR FINISH ((SUBMIT SAMPLE FOR APPROVAL))	WOOD	-	100	PLAIN CEMENT PLASTER PAINTED FINISH / DRYWALL PAINTED FINISH 12mm TEMPERED,LAMINATED INSULATED GLASS	4.5mm THICK FIBER CEMENT BOARD (PAINTED) ON METAL FURRING CHANNELS @ 400mm O.C.	SUSPENDED	3000	TOP OF GRANITE TILES @ 4.00m HIGH FROM FLOOR FINISH LEVEL
	INFO MANAGEMENT AND DIVISION	600 X 600mm CERAMIC TILE FLOOR FINISH ((SUBMIT SAMPLE FOR APPROVAL))	WOOD	-	100	DRYWALL PAINTED FINISH / 12mm TEMPERED,LAMINATED INSULATED GLASS	4.5mm THICK FIBER CEMENT BOARD (PAINTED) ON METAL FURRING CHANNELS @ 400mm O.C.	SUSPENDED	3000	TOP OF GRANITE TILES @ 3.00m HIGH FROM FLOOR FINISH LEVEL
	LIBRARY AREA	600 X 600mm CERAMIC TILE FLOOR FINISH ((SUBMIT SAMPLE FOR APPROVAL))	WOOD	-	100	DRYWALL PAINTED FINISH / 12mm TEMPERED,LAMINATED INSULATED GLASS	4.5mm THICK FIBER CEMENT BOARD (PAINTED) ON METAL FURRING CHANNELS @ 400mm O.C.	SUSPENDED	3000	TOP OF GRANITE TILES @ 3.00m HIGH FROM FLOOR FINISH LEVEL
	TOILET (HE AND SHE)	600 X 600mm CERAMIC TILE FLOOR FINISH ((SUBMIT SAMPLE FOR APPROVAL))	WOOD	-	100	600 X 600mm GLAZED CERAMIC TILE FINISH (SIZE & COLOR BY END-USER'S APPROVAL)	4.5mm THICK FIBER CEMENT BOARD (PAINTED) ON METAL FURRING CHANNELS @ 400mm O.C.	SUSPENDED	3000	TOP OF GRANITE TILES @ 3.00m HIGH FROM FLOOR FINISH LEVEL
	PANTRY AREA	600 X 600mm CERAMIC TILE FLOOR FINISH ((SUBMIT SAMPLE FOR APPROVAL))	-	-	-	PLAIN CEMENT PLASTER PAINTED FINISH	4.5mm THICK FIBER CEMENT BOARD (PAINTED) ON METAL FURRING CHANNELS @ 400mm O.C.	SUSPENDED	3000	TOP OF GRANITE TILES @ 3.00m HIGH FROM FLOOR FINISH LEVEL
	CCTV ROOM	600 X 600mm CERAMIC TILE FLOOR FINISH ((SUBMIT SAMPLE FOR APPROVAL))	WOOD		100	PLAIN CEMENT PLASTER PAINTED FINISH	4.5mm THICK FIBER CEMENT BOARD (PAINTED) ON METAL FURRING CHANNELS @ 400mm O.C.	SUSPENDED	3000	TOP OF GRANITE TILES @ 3.00m HIGH FROM FLOOR FINISH LEVEL
	SERVER ROOM	600 X 600mm CERAMIC TILE FLOOR FINISH ((SUBMIT SAMPLE FOR APPROVAL))	WOOD	-	100	PLAIN CEMENT PLASTER PAINTED FINISH	4.5mm THICK FIBER CEMENT BOARD (PAINTED) ON METAL FURRING CHANNELS @ 400mm O.C.	SUSPENDED	3000	TOP OF GRANITE TILES @ 3.00m HIGH FROM FLOOR FINISH LEVEL
	HALLWAY	600 X 600mm POLISHED SYNTHETIC GRANITE TILE FLOOR FINISH ((SUBMIT SAMPLE FOR APPROVAL))	-	-	-	PLAIN CEMENT PLASTER PAINTED FINISH / 12mm TEMPERED,LAMINATED INSULATED GLASS	4.5mm THICK FIBER CEMENT BOARD (PAINTED) ON METAL FURRING CHANNELS @ 400mm O.C.	SUSPENDED	3000	TOP OF GRANITE TILES @ 3.00m HIGH FROM FLOOR FINISH LEVEL
	STAIR CASE	600 X 600mm CERAMIC TILE FLOOR FINISH ((SUBMIT SAMPLE FOR APPROVAL))	-	-	-	PLAIN CEMENT PLASTER PAINTED FINISH	EXPOSED UNDERSIDE OF CONCRETE SLAB (PAINTED)			
	DIVISION CHIEF	600 X 600mm CERAMIC TILE FLOOR FINISH ((SUBMIT SAMPLE FOR APPROVAL))	WOOD	-	-	DRYWALL PAINTED FINISH / 12mm TEMPERED,LAMINATED INSULATED GLASS	4.5mm THICK FIBER CEMENT BOARD (PAINTED) ON METAL FURRING CHANNELS @ 400mm O.C.	SUSPENDED	3000	TOP OF GRANITE TILES @ 3.00m HIGH FROM FLOOR FINISH LEVEL
	CAPACITY AND DEVELOPMENT	600 X 600mm CERAMIC TILE FLOOR FINISH ((SUBMIT SAMPLE FOR APPROVAL))	WOOD	-	-	DRYWALL PAINTED FINISH / 12mm TEMPERED,LAMINATED INSULATED GLASS	4.5mm THICK FIBER CEMENT BOARD (PAINTED) ON METAL FURRING CHANNELS @ 400mm O.C.	SUSPENDED	3000	TOP OF GRANITE TILES @ 3.00m HIGH FROM FLOOR FINISH LEVEL
	LEGAL AND RESEARCH	600 X 600mm CERAMIC TILE FLOOR FINISH ((SUBMIT SAMPLE FOR APPROVAL))	WOOD	-	-	DRYWALL PAINTED FINISH / 12mm TEMPERED,LAMINATED INSULATED GLASS	4.5mm THICK FIBER CEMENT BOARD (PAINTED) ON METAL FURRING CHANNELS @ 400mm O.C.	SUSPENDED	3000	TOP OF GRANITE TILES @ 3.00m HIGH FROM FLOOR FINISH LEVEL
	PERFORMANCE MONITORING	600 X 600mm CERAMIC TILE FLOOR FINISH ((SUBMIT SAMPLE FOR APPROVAL))	WOOD	-	-	DRYWALL PAINTED FINISH / 12mm TEMPERED,LAMINATED INSULATED GLASS	4.5mm THICK FIBER CEMENT BOARD (PAINTED) ON METAL FURRING CHANNELS @ 400mm O.C.	SUSPENDED	3000	TOP OF GRANITE TILES @ 3.00m HIGH FROM FLOOR FINISH LEVEL
	STORAGE	PLAIN CEMENT FLOOR FINISH (PROVIDE FLOOR HARDENER)	-	-	-	PLAIN CEMENT PLASTER PAINTED FINISH	EXPOSED UNDERSIDE OF CONCRETE SLAB (PAINTED)			

SCHEDULE OF FINISHES

FOURTH FLOOR	ROOM NAME	FLOOR	BASE			WALL ABOVE BASE	CEILING			REMARKS
			MAT'L	TYPE	HT (MM)		MAT'L	TYPE	HT (MM)	
	LOBBY	900 X 900mm POLISHED SYNTHETIC GRANITE TILE FLOOR FINISH ((SUBMIT SAMPLE FOR APPROVAL))	WOOD	-	100	PLAIN CEMENT PLASTER PAINTED FINISH / DRYWALL PAINTED FINISH 12mm TEMPERED,LAMINATED INSULATED GLASS	4.5mm THICK FIBER CEMENT BOARD (PAINTED) ON METAL FURRING CHANNELS @ 400mm O.C.	SUSPENDED	3000	TOP OF GRANITE TILES @ 3.00m HIGH FROM FLOOR FINISH LEVEL
	GPPB LOUNGE	600 X 600mm CERAMIC TILE FLOOR FINISH ((SUBMIT SAMPLE FOR APPROVAL))	-	-	100	DRYWALL PAINTED FINISH /PLAIN CEMENT PLASTER PAINTED FINISH 12mm TEMPERED,LAMINATED INSULATED GLASS	4.5mm THICK FIBER CEMENT BOARD (PAINTED) ON METAL FURRING CHANNELS @ 400mm O.C.	SUSPENDED	3000	TOP OF GRANITE TILES @ 3.00m HIGH FROM FLOOR FINISH LEVEL
	OFFICE OF THE DEPUTY EXECUTIVE DIRECTOR	600 X 600mm CERAMIC TILE FLOOR FINISH ((SUBMIT SAMPLE FOR APPROVAL))	WOOD	-	100	DRYWALL PAINTED FINISH / PLAIN CEMENT PLASTER PAINTED FINISH	4.5mm THICK FIBER CEMENT BOARD (PAINTED) ON METAL FURRING CHANNELS @ 400mm O.C.	SUSPENDED	3000	TOP OF GRANITE TILES @ 3.00m HIGH FROM FLOOR FINISH LEVEL
	DIVISION CHIEF	600 X 600mm CERAMIC TILE FLOOR FINISH ((SUBMIT SAMPLE FOR APPROVAL))	WOOD	-	100	DRYWALL PAINTED FINISH /PLAIN CEMENT PLASTER PAINTED FINISH 12mm TEMPERED,LAMINATED INSULATED GLASS	4.5mm THICK FIBER CEMENT BOARD (PAINTED) ON METAL FURRING CHANNELS @ 400mm O.C.	SUSPENDED	3000	TOP OF GRANITE TILES @ 3.00m HIGH FROM FLOOR FINISH LEVEL
	SECRETARIAT DIVISION	600 X 600mm CERAMIC TILE FLOOR FINISH ((SUBMIT SAMPLE FOR APPROVAL))	-	-	100	DRYWALL PAINTED FINISH /PLAIN CEMENT PLASTER PAINTED FINISH 12mm TEMPERED,LAMINATED INSULATED GLASS	4.5mm THICK FIBER CEMENT BOARD (PAINTED) ON METAL FURRING CHANNELS @ 400mm O.C.	SUSPENDED	3000	TOP OF GRANITE TILES @ 3.00m HIGH FROM FLOOR FINISH LEVEL
	PANTRY AREA	600 X 600mm CERAMIC TILE FLOOR FINISH ((SUBMIT SAMPLE FOR APPROVAL))	WOOD		100	PLAIN CEMENT PLASTER PAINTED FINISH / DRYWALL PAINTED FINISH PLAIN CEMENT PLASTER PAINTED FINISH	4.5mm THICK FIBER CEMENT BOARD (PAINTED) ON METAL FURRING CHANNELS @ 400mm O.C.	SUSPENDED	3000	TOP OF GRANITE TILES @ 3.00m HIGH FROM FLOOR FINISH LEVEL
	RECEPTION AREA	600 X 600mm CERAMIC TILE FLOOR FINISH ((SUBMIT SAMPLE FOR APPROVAL))	WOOD	-	100	DRYWALL PAINTED FINISH / 12mm TEMPERED,LAMINATED INSULATED GLASS	4.5mm THICK FIBER CEMENT BOARD (PAINTED) ON METAL FURRING CHANNELS @ 400mm O.C.	SUSPENDED	3000	TOP OF GRANITE TILES @ 3.00m HIGH FROM FLOOR FINISH LEVEL
	STAIR CASE	600 X 600mm CERAMIC TILE FLOOR FINISH ((SUBMIT SAMPLE FOR APPROVAL))	-	-	100	DRYWALL PAINTED FINISH	EXPOSED UNDERSIDE OF CONCRETE SLAB (PAINTED)			
	MEETING ROOM	600 X 600mm CERAMIC TILE FLOOR FINISH ((SUBMIT SAMPLE FOR APPROVAL))	WOOD	-	-	DRYWALL PAINTED FINISH / 12mm TEMPERED,LAMINATED INSULATED GLASS	4.5mm THICK FIBER CEMENT BOARD (PAINTED) ON METAL FURRING CHANNELS @ 400mm O.C.	SUSPENDED	3000	TOP OF GRANITE TILES @ 3.00m HIGH FROM FLOOR FINISH LEVEL
	OFFICE OF THE CHAIRPERSON	900 X 900mm POLISHED SYNTHETIC GRANITE TILE FLOOR FINISH ((SUBMIT SAMPLE FOR APPROVAL))	WOOD	-	100	DRYWALL PAINTED FINISH / PLAIN CEMENT PLASTER PAINTED FINISH 12mm TEMPERED,LAMINATED INSULATED GLASS	4.5mm THICK FIBER CEMENT BOARD (PAINTED) ON METAL FURRING CHANNELS @ 400mm O.C.	SUSPENDED	3000	TOP OF GRANITE TILES @ 3.00m HIGH FROM FLOOR FINISH LEVEL
	TOILET (HE AND SHE), PWD	600 X 600mm UNGLAZED VITRIFIED CERAMIC TILE FLOOR FINISH (SIZE & COLOR BY END-USER'S APPROVAL)	-	-	100	600 X 600mm GLAZED CERAMIC TILE FINISH (SIZE & COLOR BY END-USER'S APPROVAL)	4.5mm THICK FIBER CEMENT BOARD (PAINTED) ON METAL FURRING CHANNELS @ 400mm O.C.	SUSPENDED	3000	TOP OF GRANITE TILES @ 3.00m HIGH FROM FLOOR FINISH LEVEL
	T&B	600 X 600mm UNGLAZED VITRIFIED CERAMIC TILE FLOOR FINISH (SIZE & COLOR BY END-USER'S APPROVAL)	-	-	-	600 X 600mm GLAZED CERAMIC TILE FINISH (SIZE & COLOR BY END-USER'S APPROVAL)	4.5mm THICK FIBER CEMENT BOARD (PAINTED) ON METAL FURRING CHANNELS @ 400mm O.C.	SUSPENDED	3000	TOP OF GRANITE TILES @ 3.00m HIGH FROM FLOOR FINISH LEVEL
	BOARD ROOM	900 X 900mm TEXTURED CERAMIC TILE (NON-SKID) FLOOR FINISH-OUTDOOR TYPE ((SUBMIT SAMPLE FOR APPROVAL))	WOOD-	-	100	PLAIN CEMENT PLASTER PAINTED FINISH	4.5mm THICK FIBER CEMENT BOARD (PAINTED) ON METAL FURRING CHANNELS @ 400mm O.C.	SUSPENDED	3000	TOP OF GRANITE TILES @ 3.00m HIGH FROM FLOOR FINISH LEVEL
	PANTRY	600 X 600mm CERAMIC TILE FLOOR FINISH ((SUBMIT SAMPLE FOR APPROVAL))	WOOD		100	PLAIN CEMENT PLASTER PAINTED FINISH	4.5mm THICK FIBER CEMENT BOARD (PAINTED) ON METAL FURRING CHANNELS @ 400mm O.C.	SUSPENDED	3000	TOP OF GRANITE TILES @ 3.00m HIGH FROM FLOOR FINISH LEVEL
	MINI-RESTING ROOM	600 X 600mm CERAMIC TILE FLOOR FINISH ((SUBMIT SAMPLE FOR APPROVAL))	WOOD		100	PLAIN CEMENT PLASTER PAINTED FINISH	4.5mm THICK FIBER CEMENT BOARD (PAINTED) ON METAL FURRING CHANNELS @ 400mm O.C.	SUSPENDED	3000	TOP OF GRANITE TILES @ 3.00m HIGH FROM FLOOR FINISH LEVEL
	OFFICE OF THE EXECUTIVE DIRECTOR	900 X 900mm POLISHED SYNTHETIC GRANITE TILE FLOOR FINISH ((SUBMIT SAMPLE FOR APPROVAL))	WOOD		100	DRYWALL PAINTED FINISH / PLAIN CEMENT PLASTER PAINTED FINISH	4.5mm THICK FIBER CEMENT BOARD (PAINTED) ON METAL FURRING CHANNELS @ 400mm O.C.	SUSPENDED	3000	TOP OF GRANITE TILES @ 3.00m HIGH FROM FLOOR FINISH LEVEL

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SCHEDULE OF FLOOR, WALL AND CEILING FINISHES

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UNITED TECHNOLOGIES CONSOLIDATED PARTNERSHIP	PREPARED BY: ARMAN U. CUEVAS	SUBMITTED BY: CYNTHIA CLEMEN A. YU ARCHITECT/TEAM LEADER PRC No.: 0018676 TIN No.: 907-359-364 PTR No.: 4020896	REPUBLIC OF THE PHILIPPINES DEPARTMENT OF PUBLIC WORKS AND HIGHWAYS BUREAU OF DESIGN BUILDINGS DIVISION BONIFACIO DRIVE PORT AREA, MANILA	REVIEWED AS TO DESIGN CONCEPT:	RECOMMENDING APPROVAL:	APPROVED:	CONCURRED:	PROJECT & LOCATION / BARANGAY:	HEET CONTENTS:	SET NO.	HEET NO.
				JOSEPHINE P. ISTURIS	(SEE COVER SHEET)	(SEE COVER SHEET)	(SEE COVER SHEET)	PROPOSED: PRO			

SCHEDULE OF FINISHES

FIFTH FLOOR	ROOM NAME	FLOOR	BASE			WALL ABOVE BASE	CEILING			REMARKS
			MAT'L	TYPE	HT (MM)		MAT'L	TYPE	HT (MM)	
	LOBBY	900 X 900mm POLISHED SYNTHETIC GRANITE TILE FLOOR FINISH ((SUBMIT SAMPLE FOR APPROVAL))	WOOD	-	100	PLAIN CEMENT PLASTER PAINTED FINISH / DRYWALL PAINTED FINISH 12mm TEMPERED,LAMINATED INSULATED GLASS	4.5mm THICK FIBER CEMENT BOARD (PAINTED) ON METAL FURRING CHANNELS @ 400mm O.C.	SUSPENDED	3000	TOP OF GRANITE TILES @ 3.00m HIGH FROM FLOOR FINISH LEVEL
	LOUNGE	600 X 600mm CERAMIC TILE FLOOR FINISH ((SUBMIT SAMPLE FOR APPROVAL))	WOOD	-	100	DRYWALL PAINTED FINISH	4.5mm THICK FIBER CEMENT BOARD (PAINTED) ON METAL FURRING CHANNELS @ 400mm O.C.	SUSPENDED	3000	TOP OF CERAMIC TILES @ 3.00m HIGH FROM FLOOR FINISH LEVEL
	CHAPEL	900 X 900mm POLISHED SYNTHETIC GRANITE TILE FLOOR FINISH ((SUBMIT SAMPLE FOR APPROVAL))	WOOD	-	100	DRYWALL PAINTED FINISH / 12mm TEMPERED,LAMINATED INSULATED GLASS	4.5mm THICK FIBER CEMENT BOARD (PAINTED) ON METAL FURRING CHANNELS @ 400mm O.C.	SUSPENDED	3000	TOP OF GRANITE TILES @ 3.00m HIGH FROM FLOOR FINISH LEVEL
	TRAINING ROOM	600 X 600mm CERAMIC TILE FLOOR FINISH ((SUBMIT SAMPLE FOR APPROVAL))	WOOD	-	100	DRYWALL PAINTED FINISH	4.5mm THICK FIBER CEMENT BOARD (PAINTED) ON METAL FURRING CHANNELS @ 400mm O.C.	SUSPENDED	3000	TOP OF CERAMIC TILES @ 3.00m HIGH FROM FLOOR FINISH LEVEL
	PANTRY AREA	600 X 600mm CERAMIC TILE FLOOR FINISH ((SUBMIT SAMPLE FOR APPROVAL))	WOOD	-	100	PLAIN CEMENT PLASTER PAINTED FINISH	4.5mm THICK FIBER CEMENT BOARD (PAINTED) ON METAL FURRING CHANNELS @ 400mm O.C.	SUSPENDED	3000	TOP OF CERAMIC TILES @ 3.00m HIGH FROM FLOOR FINISH LEVEL
	TOILET (HE AND SHE), PWD	600 X 600mm UNGLAZED VITRIFIED CERAMIC TILE FLOOR FINISH (SIZE & COLOR BY END-USER'S APPROVAL)	-		100	600 X 600mm GLAZED CERAMIC TILE FINISH (SIZE & COLOR BY END-USER'S APPROVAL)	4.5mm THICK FIBER CEMENT BOARD (PAINTED) ON METAL FURRING CHANNELS @ 400mm O.C.	SUSPENDED	3000	TOP OF CERAMIC TILES @ 3.00m HIGH FROM FLOOR FINISH LEVEL
	STAIR CASE	600 X 600mm CERAMIC TILE FLOOR FINISH ((SUBMIT SAMPLE FOR APPROVAL))	-	-	100	PLAIN CEMENT PLASTER PAINTED FINISH	EXPOSED UNDERSIDE OF CONCRETE SLAB (PAINTED)			
	STORAGE ROOM	PLAIN CEMENT FLOOR FINISH (PROVIDE FLOOR HARDENER)	-	-	100	PLAIN CEMENT PLASTER PAINTED FINISH	EXPOSED UNDERSIDE OF CONCRETE SLAB (PAINTED)			
	HALLWAY	900 X 900mm POLISHED SYNTHETIC GRANITE TILE FLOOR FINISH ((SUBMIT SAMPLE FOR APPROVAL))	WOOD	-	-	PLAIN CEMENT PLASTER PAINTED FINISH / DRYWALL PAINTED FINISH 12mm TEMPERED,LAMINATED INSULATED GLASS	4.5mm THICK FIBER CEMENT BOARD (PAINTED) ON METAL FURRING CHANNELS @ 400mm O.C.	SUSPENDED		TOP OF GRANITE TILES @ 3.00m HIGH FROM FLOOR FINISH LEVEL

SCHEDULE OF FINISHES

SIXTH FLOOR	ROOM NAME	FLOOR	BASE			WALL ABOVE BASE	CEILING			REMARKS
			MAT'L	TYPE	HT (MM)		MAT'L	TYPE	HT (MM)	
	LOBBY	900 X 900mm POLISHED SYNTHETIC GRANITE TILE FLOOR FINISH ((SUBMIT SAMPLE FOR APPROVAL))	WOOD	-	100	PLAIN CEMENT PLASTER PAINTED FINISH	4.5mm THICK FIBER CEMENT BOARD (PAINTED) ON METAL FURRING CHANNELS @ 400mm O.C.	SUSPENDED	3000	TOP OF CERAMIC TILES @ 3.00m HIGH FROM FLOOR FINISH LEVEL
	RECEPTION/RECEIVING AREA	600 X 600mm CERAMIC TILE FLOOR FINISH ((SUBMIT SAMPLE FOR APPROVAL))	WOOD	-	100	PLAIN CEMENT PLASTER PAINTED FINISH	4.5mm THICK FIBER CEMENT BOARD (PAINTED) ON METAL FURRING CHANNELS @ 400mm O.C.	SUSPENDED	3000	TOP OF CERAMIC TILES @ 3.00m HIGH FROM FLOOR FINISH LEVEL
	HALLWAY	900 X 900mm POLISHED SYNTHETIC GRANITE TILE FLOOR FINISH ((SUBMIT SAMPLE FOR APPROVAL))	WOOD	-	100	PLAIN CEMENT PLASTER PAINTED FINISH	4.5mm THICK FIBER CEMENT BOARD (PAINTED) ON METAL FURRING CHANNELS @ 400mm O.C.	SUSPENDED	3000	TOP OF CERAMIC TILES @ 3.00m HIGH FROM FLOOR FINISH LEVEL
	LOUNGE / DORMITORY LOUNGE	600 X 600mm CERAMIC TILE FLOOR FINISH ((SUBMIT SAMPLE FOR APPROVAL))		-		PLAIN CEMENT PLASTER PAINTED FINISH	4.5mm THICK FIBER CEMENT BOARD (PAINTED) ON METAL FURRING CHANNELS @ 400mm O.C.	SUSPENDED	3000	TOP OF CERAMIC TILES @ 3.00m HIGH FROM FLOOR FINISH LEVEL
	VIP ROOMS	600 X 600mm CERAMIC TILE FLOOR FINISH ((SUBMIT SAMPLE FOR APPROVAL))		-		PLAIN CEMENT PLASTER PAINTED FINISH	4.5mm THICK FIBER CEMENT BOARD (PAINTED) ON METAL FURRING CHANNELS @ 400mm O.C.	SUSPENDED	3000	TOP OF CERAMIC TILES @ 3.00m HIGH FROM FLOOR FINISH LEVEL
	VIP T&B	600 X 600mm CERAMIC TILE FLOOR FINISH ((SUBMIT SAMPLE FOR APPROVAL))	WOOD	-	100	600 X 600mm GLAZED CERAMIC TILE FINISH (SIZE & COLOR BY END-USER'S APPROVAL)	4.5mm THICK FIBER CEMENT BOARD (PAINTED) ON METAL FURRING CHANNELS @ 400mm O.C.	SUSPENDED	3000	TOP OF CERAMIC TILES @ 3.00m HIGH FROM FLOOR FINISH LEVEL
	DORMITORY T&B,PWD	600 X 600mm UNGLAZED CERAMIC TILE FLOOR FINISH ((SUBMIT SAMPLE FOR APPROVAL))	WOOD	-	100	600 X 600mm GLAZED CERAMIC TILE FINISH (SIZE & COLOR BY END-USER'S APPROVAL)	4.5mm THICK FIBER CEMENT BOARD (PAINTED) ON METAL FURRING CHANNELS @ 400mm O.C.	SUSPENDED	3000	TOP OF CERAMIC TILES @ 3.00m HIGH FROM FLOOR FINISH LEVEL
	PANTRY	600 X 600mm CERAMIC TILE FLOOR FINISH ((SUBMIT SAMPLE FOR APPROVAL))		-		PLAIN CEMENT PLASTER PAINTED FINISH	4.5mm THICK FIBER CEMENT BOARD (PAINTED) ON METAL FURRING CHANNELS @ 400mm O.C.	SUSPENDED	3000	TOP OF CERAMIC TILES @ 3.00m HIGH FROM FLOOR FINISH LEVEL
	UTILITY / STORAGE	PLAIN CEMENT FLOOR FINISH (PROVIDE FLOOR HARDENER)		-		PLAIN CEMENT PLASTER PAINTED FINISH	EXPOSED UNDERSIDE OF CONCRETE SLAB (PAINTED)			
	STAIR CASE	600 X 600mm CERAMIC TILE FLOOR FINISH ((SUBMIT SAMPLE FOR APPROVAL))		-		PLAIN CEMENT PLASTER PAINTED FINISH	EXPOSED UNDERSIDE OF CONCRETE SLAB (PAINTED)			
	DORMITORY 1&2	600 X 600mm CERAMIC TILE FLOOR FINISH ((SUBMIT SAMPLE FOR APPROVAL))		-		PLAIN CEMENT PLASTER PAINTED FINISH	EXPOSED UNDERSIDE OF ROOFING INSULATION			
	AUDITORIUM	CARPET MAD RIBBED FLOORING 1820 X 190 X 19mm THK. LAMINATE FLOORING		-		PLAIN CEMENT PLASTER PAINTED FINISH / FABRIC WRAPPED ACOUSTICAL WALL PANELS	4.5mm THICK FIBER CEMENT BOARD (PAINTED) ON METAL FURRING CHANNELS @ 400mm O.C. / FABRIC WRAPPED ACOUSTIC CEILING PANEL	SUSPENDED	4000	TOP OF LAMINATE FLOORING @ 4.00m HIGH FROM FLOOR FINISH LEVEL
	AUDITORIUM TOILET	600 X 600mm UNGLAZED CERAMIC TILE FLOOR FINISH ((SUBMIT SAMPLE FOR APPROVAL))		-		600 X 600mm GLAZED CERAMIC TILE FINISH (SIZE & COLOR BY END-USER'S APPROVAL)	EXPOSED UNDERSIDE OF ROOFING INSULATION			
	AUDIO VISUAL	600 X 600mm CERAMIC TILE FLOOR FINISH ((SUBMIT SAMPLE FOR APPROVAL))		-		PLAIN CEMENT PLASTER PAINTED FINISH	EXPOSED UNDERSIDE OF ROOFING INSULATION			

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SCHEDULE OF FLOOR, WALL AND CEILING FINISHES

UNITED TECHNOLOGIES CONSOLIDATED PARTNERSHIP	PREPARED BY:	SUBMITTED BY:		REPUBLIC OF THE PHILIPPINES DEPARTMENT OF PUBLIC WORKS AND HIGHWAYS BUREAU OF DESIGN BUILDINGS DIVISION BONIFACIO DRIVE PORT AREA, MANILA	REVIEWED AS TO DESIGN CONCEPT:	RECOMMENDING APPROVAL:	APPROVED:	CONCURRED:	PROJECT & LOCATION / BARANGAY:	SHEET CONTENTS:	SET NO.	SHEET NO.
											BOD A-48	50 216
	ARMAN U. CUEVAS ARCHITECTURAL DESIGN POSITION: ARCHITECT PRC No.: 0018676 TIN No.: 907-359-364 PTR No.: 4020896	CYNTHIA CLEMEN A. YU ARCHITECT/TEAM LEADER			JOSEPHINE P. ISTURIS CHIEF, BUILDINGS DIVISION, BOD	(SEE COVER SHEET) LEA N. DELFINADO, CESO IV	(SEE COVER SHEET) EMIL K. SADAIN, CESO I	(SEE COVER SHEET) ROWENA CANDICE M. RUIZ	PROPOSED: PROPOSED SEVEN (7) STOREY GOVERNMENT PROCUREMENT POLICY BOARD (GPPB) UP DILIMAN COMPOUND, DILIMAN, QUEZON CITY	SCHEDULE OF FLOOR, WALL AND CEILING FINISHES		

SCHEDULE OF FINISHES

SEVENTH FLOOR	ROOM NAME	FLOOR	BASE			WALL ABOVE BASE	CEILING				REMARKS
			MAT'L	TYPE	HT (MM)		MAT'L	TYPE	HT (MM)		
	LOBBY	900 X 900mm POLISHED SYNTHETIC GRANITE TILE FLOOR FINISH ((SUBMIT SAMPLE FOR APPROVAL))	WOOD	-	100	PLAIN CEMENT PLASTER PAINTED FINISH	4.5mm THICK FIBER CEMENT BOARD (PAINTED) ON METAL FURRING CHANNELS @ 400mm O.C.	SUSPENDED	3000	TOP OF CERAMIC TILES @ 3.00m HIGH FROM FLOOR FINISH LEVEL	
	GYM	600 X 600mm CERAMIC TILE FLOOR FINISH ((SUBMIT SAMPLE FOR APPROVAL))	WOOD	-	100	PLAIN CEMENT PLASTER PAINTED FINISH	4.5mm THICK FIBER CEMENT BOARD (PAINTED) ON METAL FURRING CHANNELS @ 400mm O.C.	SUSPENDED	3000	TOP OF CERAMIC TILES @ 3.00m HIGH FROM FLOOR FINISH LEVEL	
	HALLWAY	900 X 900mm POLISHED SYNTHETIC GRANITE TILE FLOOR FINISH ((SUBMIT SAMPLE FOR APPROVAL))	WOOD	-	100	PLAIN CEMENT PLASTER PAINTED FINISH	4.5mm THICK FIBER CEMENT BOARD (PAINTED) ON METAL FURRING CHANNELS @ 400mm O.C.	SUSPENDED	3000	TOP OF CERAMIC TILES @ 3.00m HIGH FROM FLOOR FINISH LEVEL	
	STORAGE	PLAIN CEMENT FLOOR FINISH (PROVIDE FLOOR HARDENER)		-		PLAIN CEMENT PLASTER PAINTED FINISH	EXPOSED UNDERSIDE OF CONCRETE SLAB (PAINTED)				
	UTILITY ROOM	PLAIN CEMENT FLOOR FINISH (PROVIDE FLOOR HARDENER)		-		PLAIN CEMENT PLASTER PAINTED FINISH	EXPOSED UNDERSIDE OF CONCRETE SLAB (PAINTED)				
	LOCKER DRESSER (HE)	600 X 600mm CERAMIC TILE FLOOR FINISH ((SUBMIT SAMPLE FOR APPROVAL))	WOOD	-	100	PLAIN CEMENT PLASTER PAINTED FINISH	4.5mm THICK FIBER CEMENT BOARD (PAINTED) ON METAL FURRING CHANNELS @ 400mm O.C.	SUSPENDED	3000	TOP OF CERAMIC TILES @ 3.00m HIGH FROM FLOOR FINISH LEVEL	
	LOCKER DRESSER (SHE)	600 X 600mm CERAMIC TILE FLOOR FINISH ((SUBMIT SAMPLE FOR APPROVAL))	WOOD	-	100	PLAIN CEMENT PLASTER PAINTED FINISH	4.5mm THICK FIBER CEMENT BOARD (PAINTED) ON METAL FURRING CHANNELS @ 400mm O.C.	SUSPENDED	3000	TOP OF CERAMIC TILES @ 3.00m HIGH FROM FLOOR FINISH LEVEL	
	T&B (HE)	600 X 600mm CERAMIC TILE FLOOR FINISH ((SUBMIT SAMPLE FOR APPROVAL))		-		600 X 600mm GLAZED CERAMIC TILE FINISH (SIZE & COLOR BY END-USER'S APPROVAL)	4.5mm THICK FIBER CEMENT BOARD (PAINTED) ON METAL FURRING CHANNELS @ 400mm O.C.	SUSPENDED	3000	TOP OF CERAMIC TILES @ 3.00m HIGH FROM FLOOR FINISH LEVEL	
	T&B (SHE)	600 X 600mm CERAMIC TILE FLOOR FINISH ((SUBMIT SAMPLE FOR APPROVAL))		-		600 X 600mm GLAZED CERAMIC TILE FINISH (SIZE & COLOR BY END-USER'S APPROVAL)	4.5mm THICK FIBER CEMENT BOARD (PAINTED) ON METAL FURRING CHANNELS @ 400mm O.C.	SUSPENDED	3000	TOP OF CERAMIC TILES @ 3.00m HIGH FROM FLOOR FINISH LEVEL	
	STAIR CASE	600 X 600mm CERAMIC TILE FLOOR FINISH ((SUBMIT SAMPLE FOR APPROVAL))		-		PLAIN CEMENT PLASTER PAINTED FINISH	EXPOSED UNDERSIDE OF CONCRETE SLAB (PAINTED)				
	BASKETBALL COURT	1820 X 190 X 19mm THK. LAMINATE FLOORING COLOR: SHERWOOD OAK		-		PLAIN CEMENT PLASTER PAINTED FINISH	EXPOSED UNDERSIDE OF ROOFING INSULATION				

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SCHEDULE OF FLOOR, WALL AND CEILING FINISHES

N T S

DOORS	SCHEDULE OF FINISHES							WINDOWS	SCHEDULE OF FINISHES							
	DOOR No.	PANEL MATERIAL	FRAME	FINISH	TYPE	No. OF PANEL	DOOR SIZE		WINDOW No.	PANEL MATERIAL	FRAME	FINISH	TYPE	No. OF PANEL/BLADES	WINDOW SIZE	W
D-1	12mm THK. TEMPERED GLASS DOOR W/ HARDWARE AND ACCESSORIES		ALUMINUM	CLEAR	AUTOMATED SLIDING	2	4100	2900	W-1	10mm THK. TEMPERED GLASS	FRAMELESS	CLEAR	FIXED	6	5100	2820
D-2	12mm THK. TEMPERED GLASS DOOR W/ HARDWARE AND ACCESSORIES		ALUMINUM	CLEAR	SWING	2	2100	2600	W-2	10mm THK. TEMPERED GLASS	ALUMINUM	CLEAR	FIXED/AWNING	2	1500	2200
D-3	12mm THK. TEMPERED GLASS DOOR W/ HARDWARE AND ACCESSORIES		FRAMELESS	POWDER COATED	SWING	2	2100	2600	W-2A	10mm THK. TEMPERED GLASS	ALUMINUM	CLEAR	FIXED/AWNING	2	1500	2200
D-3-A	12mm THK. TEMPERED GLASS DOOR W/ HARDWARE AND ACCESSORIES		FRAMELESS	POWDER COATED	SWING	1	2100	2600	W-3	10mm THK. TEMPERED GLASS	ALUMINUM	CLEAR	FIXED/AWNING	1	1200	2200
D-4	SOLID WOOD PANEL DOOR W/ HARDWARE AND ACCESSORIES	MAHOGANY	SEMI-GLOSS WOOD VARNISH	SWING	1	800	2100	W-4	10mm THK. TEMPERED GLASS	ALUMINUM	CLEAR	FIXED/AWNING	4	2000	1600	
D-5	SOLID WOOD PANEL DOOR W/ HARDWARE AND ACCESSORIES	MAHOGANY	SEMI-GLOSS WOOD VARNISH	SWING	1	900	2100	W-5	10mm THK. TEMPERED GLASS	ALUMINUM	CLEAR	FIXED	4	2000	1600	
D-6	SOLID WOOD PANEL DOOR W/ HARDWARE AND ACCESSORIES	MAHOGANY	SEMI-GLOSS WOOD VARNISH	SWING	1	800	2100	W-6	GALVANIZED BLADES (GAUGE 26)	ALUMINUM	PAINTED	JALOUSIE	7	700	735	
D-7	SOLID WOOD PANEL DOOR W/ HARDWARE AND ACCESSORIES	MAHOGANY	SEMI-GLOSS WOOD VARNISH	SWING	1	900	2100									
D-8	SOLID WOOD PANEL DOOR W/ HARDWARE AND ACCESSORIES	MAHOGANY	SEMI-GLOSS WOOD VARNISH	SWING	2	2100	2100									
D-9	FIRE-RATED STEEL DOOR WITH GLASS VIEWING PANEL	METAL	PAINT	SWING	2	2100	2600									
D-10	PHENOLIC DOOR w/ HARDWARE ACCESSORIES AND DOOR BOLT	MAHOGANY	SEMI-GLOSS WOOD VARNISH	SWING	1	600	1200									
D-11	FIRE-RATED STEEL DOOR	METAL	PAINT	SWING	1	900	2100									
D-12	STEEL DOOR W/ HARDWARE AND ACCESSORIES	METAL	PAINT	SWING	1	800	2100									
D-13	GLASS DOOR W/ HARDWARE AND ACCESSORIES	ALUMINUM	POWDER COATED	SLIDING	2	800	1650									
D-14	STEEL DOOR W/ HARDWARE AND ACCESSORIES	ALUMINUM	PAINT	SWING	1	600	2100									
D-15	3.2 MM THICK STEEL DOOR	METAL	PAINT	SWING	2	3000	2500									
D-16	MANUALLY OPERATED GALVANIZED STEEL (GAUGE 26)	METAL	PAINT	ROLL UP	1	2800	2330									

NOTE:
PURSUANT TO SECTION 4 OF ANNEX "A" OF THE REVISED IMPLEMENTING RULES AND REGULATION OF RA. 9184, APPROVAL BY THE AUTHORIZED DPWH OFFICIALS OF DETAILED ENGINEERING SURVEYS AND DESIGN UNDERTAKEN BY CONSULTANTS NEITHER DIMINISHES THE RESPONSIBILITY OF THE LATTER FOR THE TECHNICAL INTEGRITY OF THE SURVEYS AND DESIGN NOR TRANSFER ANY PART OF THAT RESPONSIBILITY TO THE APPROVING OFFICIALS.

THE DESIGN CONSULTANT SHALL BE HELD FULLY RESPONSIBLE FOR THE FAILURE OF THE FACILITY/IES/STRUCTURES DUE TO FAULTY DESIGN EXCEPT FOR THE CHANGES MADE WITHOUT THE CONFORMITY OF THE CONSULTANTS.

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SCHEDULE OF DOOR AND WINDOW FINISHES

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UNITED TECHNOLOGIES CONSOLIDATED PARTNERSHIP	PREPARED BY:	SUBMITTED BY:		REPUBLIC OF THE PHILIPPINES DEPARTMENT OF PUBLIC WORKS AND HIGHWAYS BUREAU OF DESIGN BUILDINGS DIVISION BONIFACIO DRIVE PORT AREA, MANILA	REVIEWED AS TO DESIGN CONCEPT:	RECOMMENDING APPROVAL:	APPROVED:	CONCURRED:	PROJECT & LOCATION / BARANGAY:	SHEET CONTENTS:	SET NO.	SHEET NO.		
											(SEE COVER SHEET)	(SEE COVER SHEET)	(SEE COVER SHEET)	PROPOSED: PROPOSED SEVEN (7) STOREY GOVERNMENT PROCUREMENT POLICY BOARD (GPPB) UP DILIMAN COMPOUND, DILIMAN, QUEZON CITY
	ARMAN U. CUEVAS ARCHITECTURAL DESIGN POSITION: ARCHITECT PRC No.: 0018676 TIN No.: 907-359-364 PTR No.: 4020896	CYNTHIA CLEMEN A. YU ARCHITECT/TEAM LEADER			JOSEPHINE P. ISTURIS CHIEF, BUILDINGS DIVISION, BOD	LEA N. DELFINADO, CESO IV OFFICER-IN-CHARGE	EMIL K. SADAIN, CESO I UNDERSECRETARY FOR UPMO OPERATIONS & TECHNICAL SERVICES	ROWENA CANDICE M. RUIZ EXECUTIVE DIRECTOR						